

SWMP NOTES

1. SITE DESCRIPTION

For Information Only to fulfill the CDPS-SCP (Colorado Discharge Permit System - Stormwater Construction Permit) Update to reflect current project site conditions.

A. PROJECT SITE DESCRIPTION:

This project provides for an expansion of 3.3 miles of US-50 Eastbound, from Purcell boulevard to Wills Boulevard, from the current two lane section, to a three lane section. The construction of this project will include full depth replacement of part of one of the existing lanes, widening the roadway to add an additional 12' lane and 12' shoulder, grading to construct a swale to convey runoff to one of two water quality ponds, grading of the two water quality ponds, a storm sewer system to capture and convey the 100-year storm for the eastern portion of the project, and the bridge over Williams Creek will be widened. Once grading activities are completed soil retention blankets and seeding will be applied to the swale and embankment areas.

B. PROPOSED SEQUENCING FOR MAJOR ACTIVITIES:

The US-50 Eastbound Widening Project will generally follow the following sequence for events that may impact water quality -

C. ACRES OF DISTURBANCE:

1. Total area of construction site: 41.2 acres
2. Total area of disturbance: 28.6 acres
3. Acreage of seeding: 20 acres

D. EXISTING SOIL DATA:

Local soils are silt loams, silty clay loams and shale. The National Resource Conservation Service (NRCS) has mapped the area, and has identified the following soil types in the project area:

- CsE - Cascajo Shale outcrop, 5 to 30 percent slopes. This soil type has a hydraulic soils grouping of "A" that is indicative of soils that are well drained and have low runoff potential and a high infiltration rate.
- Ha - Haverson silt loam. This soil type has a hydraulic soils grouping of "B" that is indicative of soils that have a moderate infiltration rate due to the moderately fine to moderately coarse texture.
- He - Heldt silty clay loam, 2 to 6 percent slopes. This soil type has a hydraulic soils grouping of "C" that is indicative of soils that have a slow infiltration rate, due to a layer that impedes the downward movement of water due to moderately fine to fine texture.
- LnA - Limon silty clay loam, 0 to 2 percent slopes. This soil type has a hydraulic soils grouping of "C" that is indicative of soils that have a slow infiltration rate, due to a layer that impedes the downward movement of water due to moderately fine to fine texture.
- LvB - Limon silty clay, 0 to 5 percent slopes. This soil type has a hydraulic soils grouping of "C" that is indicative of soils that have a slow infiltration rate, due to a layer that impedes the downward movement of water due to moderately fine to fine texture.
- MaB - Manvel silt loam, 1 to 5 percent slopes. This soil type has a hydraulic soils grouping of "B" that is indicative of soils that have a moderate infiltration rate due to the moderately fine to moderately coarse texture.
- MpA - Manzanola silty clay loam, 0 to 2 percent slopes. This soil type has a hydraulic soils grouping of "C" that is indicative of soils that have a slow infiltration rate, due to a layer that impedes the downward movement of water due to moderately fine to fine texture.
- MsD - Midway Shale outcrop, 1 to 9 percent slopes. This soil type has a hydraulic soils grouping of "D" that is indicative of soils having a very slow infiltration rate and high runoff potential, due to a prevalence of clays or other impervious materials, such as shales.
- Mv - Minnequa Manvel loam. This soil type has a hydraulic soils grouping of "C" that is indicative of soils that have a slow infiltration rate, due to a layer that impedes the downward movement of water due to moderately fine to fine texture.
- PmE - Penrose-Minnequa, 1 to 15 percent slopes. This soil type has a hydraulic soils grouping of "D" that is indicative of soils having a very slow infiltration rate and high runoff potential, due to a prevalence of clays or other impervious materials, such as shales.
- PrF - Penrose Rock outcrop, 25 to 65 percent slopes. This soil type has a hydraulic soils grouping of "D" that is indicative of soils having a very slow infiltration rate and high runoff potential, due to a prevalence of clays or other impervious materials, such as shales.
- Ra - Razor clay loam. This soil type has a hydraulic soils grouping of "C" that is indicative of soils that have a slow infiltration rate, due to a layer that impedes the downward movement of water due to moderately fine to fine texture.
- SaE - Schamber gravelly sandy loam, 5 to 25 percent slopes. This soil type has a hydraulic soils grouping of "A" that is indicative of soils that are well drained and have a high infiltration rate.
- SgD - Shingle silty clay loam, 1 to 9 percent slopes. This soil type has a hydraulic soils grouping of "D" that is indicative of soils having a very slow infiltration rate and high runoff potential, due to a prevalence of clays or other impervious materials, such as shales.
- Sh - Stoneham loam. This soil type has a hydraulic soils grouping of "B" that is indicative of soils that have a moderate infiltration rate due to the moderately fine to moderately coarse texture.

E. EXISTING VEGETATION, INCLUDING PERCENT COVER:

Existing vegetation consists of native grasses.
Percent Cover of existing vegetation: 60%

F. POTENTIAL POLLUTANTS SOURCES: See First Construction Activities under Potential Pollutant Sources. The ECS shall prepare a list of all potential pollutants and their locations in accordance with subsection 107.25.

G. RECEIVING WATER:

1. Outfall locations:

TABLE 1-1

Location	Size	Type	Receiving
97+67.59	30 inch	CSP	Outfall off project site, flows to Williams Creek
108+68.53	30 inch	CSP	Outfall off project site, flows to Williams Creek
122+68.72	27 inch	CSP	Outfall off project site, flows to Williams Creek
123+69.58	36 inch	CSP	3 Pipes, Outfall off project site, flows to Williams Creek
135+28.54	36 inch	CSP	3 Pipes, Outfall off project site, flows to Williams Creek
146+78.35	30 inch	CSP	Ditch outfall to Williams Creek
156+70.47	27 inch	CSP	Ditch outfall to Williams Creek
168+81.54	27 inch	CSP	Outfall off project site, flows to Williams Creek
177+71.79	27 inch	CSP	Outfall off project site, flows to Williams Creek
191+77.26	27 inch	CSP	Outfall off project site, flows to Williams Creek
198+43.96, RT 36'	27 inch	CSP	Conveys ditch flow from north to south side of US 50 to Williams Creek
199+07.77, LT 48'	27 inch	CSP	Conveys ditch flow from south to north side of US 50 to Williams Creek
207+07.17, LT 59'	27 inch	CSP	Conveys ditch flow from north to south side of US 50 to Williams Creek
213+83.49, RT 36'	27 inch	CSP	Williams Creek
215+36.99, RT 36'	27 inch	CSP	Conveys ditch flow from west to east side of Pueblo Blvd to Williams Creek
216+05.96, LT 86'	30 inch	CSP	Conveys ditch flow from south to north side of US 50 to Williams Creek
218+39.91, RT 36'	27 inch	CSP	Williams Creek
219+64.11, LT 65'	21 inch	CSP	Conveys ditch flow from south to north side of US 50 to Williams Creek
222+54.93, RT 42'	27 inch	CSP	Williams Creek
247+63.91, RT 73'	27 inch	CSP	Ditch outfall To Wild Horse Dry Creek

2. Names of receiving water(s) on site and the ultimate receiving water: Williams Creek and Wildhorse Creek cross the project. The ultimate receiving water is the Arkansas River.

3. Distance ultimate receiving water is from project: Approx. 2.8 miles

H. ALLOWABLE NON-STORMWATER DISCHARGES:

No non-stormwater discharges are anticipated for this project.

1. Groundwater and stormwater dewatering: Discharges to the ground of water from construction dewatering activities may be authorized provided that:
 - a. the source is groundwater and/or groundwater combined with stormwater that does not contain pollutants
 - b. the source and BMPs are identified in the SWMP
 - c. discharges do not leave the site as surface runoff or to surface waters.
2. If discharges do not meet the above criteria a separate permit from the Department of Health will be required. Contaminated groundwater requiring coverage under a separate permit may include groundwater contaminated with pollutants from a landfill, mining activities, industrial pollutant plumes, underground storage tank, etc.

I. ENVIRONMENTAL IMPACTS:

1. Wetland Impacts: NO
2. Stream Impacts: YES
3. Threatened and Endangered Species: Suitable habitat present along Wild Horse Dry Creek and Williams Creek for the Northern Leopard Frog and Plains Leopard Frog, Triploid Colorado Checkered Whiptail (State Species of Special Concern), and Massasauga Rattlesnake. Please refer to Environmental Notes for specific requirements for special status species.

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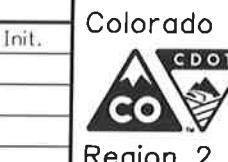
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Date:	Comments	Init.



Colorado Department of Transportation
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Region 2

As Constructed	US 50 WEST PURCELL BLVD. TO WILLS BLVD. SWMP NOTES		Project No./Code
No Revisions:			
Revised:	Designer: LK	Structure Numbers	

Void:	Detailer: LK	Subset: SN	Subset Sheets: SNI of 5	Sheet Number 200
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2. SITE MAP COMPONENTS:

Pre-construction

- A. PROJECT CONSTRUCTION POTENTIAL SITE BOUNDARIES
- B. ALL AREAS OF GROUND SURFACE DISTURBANCE
- C. AREAS OF CUT AND FILL
- D. LOCATION OF ALL STRUCTURAL BMPs IDENTIFIED IN THE SWMP
- E. LOCATION OF NON-STRUCTURAL BMPs AS APPLICABLE IN THE SWMP
- F. SPRINGS, STREAMS, WETLANDS AND OTHER SURFACE WATER
- G. PROTECTION OF TREES, SHRUBS, CULTURAL RESOURCES AND MATURE VEGETATION
- H. AREAS USED FOR STORING AND STOCKPILING OF MATERIALS, STAGING AREAS (field trailer, fueling, etc) and BATCH PLANTS

Revise site maps in accordance to 208.03

3. SWMP ADMINISTRATOR FOR DESIGN:

Luke R. Myers, P.E.
J.F. Sato & Associates

4. STORMWATER MANAGEMENT CONTROLS FIRST CONSTRUCTION ACTIVITIES

THE CONTRACTOR SHALL PERFORM THE FOLLOWING:

- A. DESIGNATE A SWMP ADMINISTRATOR/EROSION CONTROL SUPERVISOR (To be filled out at time of construction; designate the individual(s) responsible for implementing, maintaining and revising the SWMP, including the title and contact information. The activities and responsibilities of the administrator shall address all aspects of the projects SWMP.)

Name/Title: Contact information:

B. POTENTIAL POLLUTANT SOURCES

Evaluate, identify and describe all potential sources of pollutants at the site in accordance with subsection 107.25 and place in the SWMP notebook. All BMPs related to potential pollutants shall be shown on the SWMP site map by the contractor's ECS.

C. BEST MANAGEMENT PRACTICES (BMPs) FOR STORMWATER POLLUTION PREVENTION

PHASED BMP IMPLEMENTATION, APPLICATION AND NARRATIVE:

During Design: "BMP as Designed" boxes are marked when used in the SWMP. During construction: the ECS shall update the narratives, include new narratives and update the "In use on site" boxes to match which BMPs are currently in use on site. Clearly describe the relationship between the phases of construction and the implementation of BMP controls.

STRUCTURAL and NONSTRUCTURAL BMPs that may be potentially used on the project for erosion and sediment control; practices may include, but are not limited to:

TABLE 4-1

Structural BMPs and Application	Narrative	BMP As Designed	In Use On Site	First Construction Activities	During Construction	Interim/Final Stabilization
Earth Berm/Stockpile	Placed around toe to contain sediment around stockpile					
Earth Berm/Toe of fill	Placed prior to earthwork within specified distance of toe to capture sediment and protect undisturbed areas					
Earthberm/Diversion	Placed to divert drainage and subdivide runoff volume from less than 10 acre sub basins. Temp feature to be removed upon final stabilization					
Rock Check Dams/Ditch	Velocity checks in ditches placed immediately after ditch grading					
Silt Fence/Sediment Control	Placed on contour to contain construction runoff	X		X	X	
Silt Fence/Protection of Vegetation	Placed to protect undisturbed area and delineate boundary of protected area					
Erosion Logs, Silt Berms or Silt Dikes/Ditch Checks	Erosion Control checks in ditches placed immediately after ditch grading to reduce flow velocity of runoff in ditch	X		X	X	X
Erosion Logs/ Existing Inlet	Placed prior to disturbance at existing inlets where disturbance maybe occurring to cause sediment laden water to enter pipe	X		X	X	
Erosion Logs/culvert inlet or outlet	Placed on culvert to filter or prevent sediment from entering pipe. If disturbance occurs above pipe then erosion logs are placed above pipe	X		X	X	X
Erosion Logs/Sediment Control	Placed to protect undisturbed area and delineate boundary of protected area	X		X	X	
Storm Drain Inlet Protection/Sediment Control	Placed to protect storm drain inlets to filter or prevent sediment from entering drainage system	X		X	X	X
Temporary Sediment Trap/Basin	Contain and filter sediment laden water from < 5 acre sub basins within construction disturbance					
Permanent Sediment Trap/Basin	Utilized during construction to act as temporary sediment containment. Outlet structure shall be modified for construction runoff					
Embankment Protection on Temp Slope Drain	Placed as a conduit or chute to drain runoff down slope and prevent erosion of slope					
Outlet Protection	Material placed as energy dissipation device to prevent erosion at outlet structure	X			X	X
Concrete Washouts/Construction Control	Construction waste management of concrete washout material	X			X	
Vehicle tracking Pad/Construction Control	Placed to prevent tracking of sediment from disturbance to offsite surface	X		X	X	
Sweeping/Construction or Source Control	Utilized to remove sediment on pavement surface and to prevent sediment from entering drainage system					
Dewatering/ Construction Control	Sediment control to remove or filter sediment from construction dewatering					
Temporary Stream Crossing/ Construction Control	Constructed over stream or drainage to prevent discharge of pollutants from construction equipment into stream					
Clean water diversion	Placed to divert clean surface or ground water from mixing with construction runoff or activity					
Other						

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US 50 WEST
PURCELL BLVD. TO WILLS BLVD.
SWMP NOTES

Designer: LK Structure Numbers

Detailer: LK

Subset: SN Subset Sheets: SN2 of 5

Project No./Code

FSA 0503-081

19751

Sheet Number 201

TABLE 4-2

Non Structural BMPs and Application	Narrative	BMP As Desig ned	In Use On Site	First Construction Activities	During Construction	Interim/ Final Stabilization
Surface Roughening/Grading Techniques	Interim and temp stabilization of disturbance and to minimize wind and erosion				X	X
Seeding Permanent/Final Stabilization	Reduce runoff and control erosion on disturbed areas	X			X	X
Seeding Temporary	Over wintering of disturbance or used to control erosion for areas scheduled for future construction				X	
Mulch/Mulch Tackifier/ Temp or Final Stabilization	Placed as a surface cover for erosion control and/or seeding establishment				X	X
Soil Retention Blanket /Temp or Final Stabilization	Placed as surface cover for erosion control and seeding establishment	X			X	X
Turf Reinforcement Mat/ Final Stabilization	Placed in channels or on slopes for erosion control, channel liner and seeding establishment					
Soil Binder/Temp Stabilization	Placed as surface treatment to provide temp erosion control					
Spray on mulch blanket/ Temp or Final Stabilization	Placed cover on slopes to control erosion and seeding establishment					
Vegetative Buffer Strips	Filter sediment laden runoff from disturbance area					
Protection of Trees/Protected Resources -Fence Plastic	Placed prior to construction to protect existing vegetation to remain					
Preservation Of Mature Vegetation/Work access and grading plans	Used to protect existing stable cover and minimize impact to vegetation					

*Check dams may be rock, erosion logs, silt dike, silt berm, etc. as indicated in the narratives and SWMP site map.

Erosion control devices are used to limit the amount of soil loss on site. Sediment control devices are designed to capture sediment on the project site.

Construction control are BMPs related to construction access and staging.

BMP locations are indicated on the SWMP site map.

BMP details and narratives not covered by the SWMP or Standard Plan M-208-1 shall be added to the SWMP notebook by the ECS.

D. OFFSITE DRAINAGE (RUN ON WATER)

- Describe and record BMPs on the SWMP site map that has been implemented to address off site run-on water in accordance with subsection 208.03.

E. VEHICLE TRACKING PAD

- BMPs shall be implemented in accordance with subsection 208.04.

F. PERIMETER CONTROL

- Perimeter control shall be established as the first item on the SWMP to prevent the potential for pollutants leaving the construction site boundaries, entering the stormwater drainage system, or discharging to state waters.
- Perimeter control may consist of vegetation buffers, berms, silt fence, erosion logs, existing landforms, or other BMPs as approved.
- Perimeter control shall be in accordance with subsection 208.04.

5. DURING CONSTRUCTION

RESPONSIBILITIES OF THE SWMP ADMINISTRATOR/EROSION CONTROL SUPERVISOR DURING CONSTRUCTION

The SWMP should be considered a "living document" that is continuously reviewed and modified. During construction, the following items shall be added, updated, or amended as needed by the SWMP Administrator/Erosion Control Supervisor (ECS) in accordance with Section 208.

During construction, indicate how items that have not been addressed during design are being handled in construction. If items are covered in the template or other sections of the SWMP notebook indicate below what section the discussion takes place.

A. STOCKPILE MANAGEMENT - shall be done in accordance with subsection 107.25 and 208.07

B. CONCRETE WASHOUT - Concrete wash out water or waste from field laboratories and paving equipment shall be contained in accordance with subsection 208.05.

C. SAW CUTTING - shall be done in accordance with subsection 107.25, 208.04, 208.05

D. STREET CLEANING - shall be done in accordance with subsection 208.04MARCH 17, 2014

6. INSPECTIONS

A. Inspections shall be in accordance with subsection 208.03 (c).

7. BMP MAINTENANCE

A. Maintenance shall be in accordance with subsection 208.04 (f).

8. RECORD KEEPING

A. Records shall be kept in accordance with subsection 208.03 (c).

9. INTERIM AND FINAL STABILIZATION

A. SEEDING PLAN

Soil preparation, soil conditioning or topsoil, seeding (native), mulching (weed free) and mulch tackifier will be required for an estimated 20.00 acres of disturbed area within the right-of-way limits which are not surfaced. The following types and rates shall be used:

- Revegetation Requirements Along Wild Horse Dry Creek (Senate Bill 40 Resources) will be completed following the removal of tamarisk per the revised project special specification 217 (Herbicide Treatment). A. Willow Cutting Zone will be revegetated with 1,100 Willow Brush Cuttings
- Shrub Planting Zone will be revegetated with 9,950 square feet seeded with four-winged saltbush (*Atriplex canescens*), as follows: The Grass Zone will be revegetated with 20,020 square feet of grass seed-mix, as follows:

Common Name	Botanical Name	Pounds of seed per Acre
Shrub Planting Zone		
Four-winged saltbush	<i>Atriplex canescens</i>	4
Grass Zone		
Alkali Sacaton	<i>Sporobolus airoides</i>	1
Western Wheatgrass	<i>Pascopyrum smithii v. Arriba</i>	8
Galleta	<i>Pleuraphis jamesii v. Viv</i>	6
Blue Grama	<i>Bouteloua gracilis</i>	2
Alkaligrass	<i>Puccinellia distans</i>	1
American Vetch	<i>Vicia americana</i>	4
Total		26

2. Revegetation Requirements - All Other Areas of Disturbance

All other areas of disturbance will be revegetated with 871,200 square feet of grass seed-mix, as follows:

Common Name	Botanical Name	Pounds of seed per Acre
Blue Grama	<i>Bouteloua gracilis v. Hachita</i>	1
Buffalo Grass	<i>Boutelous dactyloides</i>	4
Galleta	<i>Pleuraphis jamesii v. Viva</i>	4
Western Wheatgrass	<i>Pascopyrum smithii v. Arriba</i>	4
Green needle grass	<i>Nassella Virdula v. Lordom</i>	2.5
Side-oats grama	<i>Boutelous curtipendula</i>	1.5
Indian ricegrass	<i>Achnatherum hymenoides v. Paloma</i>	2
American Vetch	<i>Vicia americana</i>	4
Purple prairieclover	<i>Dalea Purpurea v. Purpurea</i>	1
Blue Flax	<i>Linum Perenne v. Appar</i>	2
Total		26

Planting of trees and shrubs will follow CDOT's Standard Specification 214 (Planting).

B. SEEDING APPLICATION: Drill seed 0.25 inch to 0.5 inch into the soil. In small areas not accessible to a drill, hand broadcast at double the rate and rake 0.25 inch to 0.5 inch into the soil.

C. MULCHING APPLICATION: Apply a minimum of 1 ½ tons of certified weed free native hay per acre and in accordance with Section 213, and mechanically crimp it into the soil in combination with an organic mulch tackifier.

D. SPECIAL REQUIREMENTS: Due to high failure rates, hydromulching and/or hydroseeding will not be allowed

E. Soil conditioning and fertilizer requirements:

Soil conditioner paid for as Item 212- Soil Conditioning (Acre)		
Biological nutrient organic based fertilizer (lbs/acre)*	Humate (lbs/acre)	Compost (cys/acre) (1/2 inch depth)
600	200	65

*Biological nutrient shall not exceed 8-8-8 (N-P-K). Humate based material shall be in accordance to Section 212 and compost shall be in accordance to Special Provision 212.

F. BLANKET APPLICATION: On slopes and ditches requiring a blanket, the blanket shall be placed in lieu of mulch and mulch tackifier. See SWMP for blanket locations.

G. RESEEDING OPERATIONS/CORRECTIVE STABILIZATION

Prior to final acceptance:

- Seeded areas shall be reviewed during the 14 day inspections by the Erosion Control Supervisor for bare soils caused by surface or wind erosion. Bare areas caused by surface or gully erosion, blown away mulch, etc. shall be regraded, seeded, mulched and have mulch tackifier (or blanket) applied as necessary, at no additional cost to the project.
- Areas where seed has not germinated after one season shall be evaluated by the Engineer and CDOT Landscape Architect. Areas that have not germinated shall have seed, mulch and mulch tackifier (or blanket) reapplied. Work shall be paid for by the appropriate bid item.
- The Contractor shall maintain seeding/mulch/tackifier, mow to control weeds or apply herbicide to control weeds in the seeded areas until Final Acceptance.

10. PRIOR TO FINAL ACCEPTANCE

A. Final Acceptance shall be in accordance with subsection 208.10.

11. TABULATION OF STORMWATER QUANTITIES

Pay Item	Description	Pay Unit	* Quantity
203-01500	Blading	Hour	100
203-01510	Backhoe	Hour	100
203-01550	Dozing	Hour	100
207-00205	Topsoil	CY	5,374
208-00005	Erosion Log	LF	2,500
208-00011	Erosion Bales (Weed Free)	Each	300
208-00020	Sill Fence	LF	13,100
208-00034	Gravel Bag (Aggregate Bag)	LF	700
208-00045	Concrete Washout Structure	Each	3
208-00050	Storm Drain Inlet Protection	Each	40
208-00070	Vehicle Tracking Pad	Each	4
208-00103	Removal and Disposal of Sediment (Labor)	Hour	400
208-00105	Removal and Disposal of Sediment (Equipment)	Hour	400
208-00106	Sweeping (Sediment Removal)	Hour	800
208-00107	Removal of Trash	Hour	300
208-00205	Erosion Control Supervisor	Hour	1,500
208-00300	Temporary Berm	LF	5,000
212-00006	Seeding (Native)	ACRE	19.6
212-00010	Seeding (Lawn)	LB	5
212-00025	Seeding (Shrubs)	LB	5
212-00032	Soil Conditioning	ACRE	10
212-00040	Soil Preparation (Lawn)	ACRE	1
213-00002	Mulching (Weed Free Hay)	ACRE	20
213-00061	Mulch Tackifier	LB	6
213-00150	Bonded Fiber Matrix	ACRE	1
216-00201	Soil Retention Blanket (Straw/Coconut) (Biodegradable Class 1)	SY	2420
700-70380	Erosion Control	FA	1

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Sheet Number 203

*It is anticipated that additional BMPs and BMP quantities not shown on the SWMP Site Maps shall be required on the project for unforeseen conditions and replacement of items that are beyond their useful service life, see subsection 208.03 and 208.04 (e). Quantities for all BMPs shown above are estimated, and have been increased for unforeseen Project conditions.




The quantity of Seeding (Native) shall include soil preparation, fertilizer, soil conditioner and seed applied, completed and accepted.

- A. BMP sediment removal and disposal shall be paid for as: 208 Removal and Disposal of Sediment (Equipment) and 208 Removal and Disposal of Sediment (Labor). All other BMP maintenance shall be included in the cost of the BMP Device.
 - B. Maintenance of seeded areas shall be paid for as: FA Erosion Control, 212 Seeding (native), 213 Mulching, 216 Soil Retention Covering

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**Know what's below.
Call before you dig.**



LEGEND

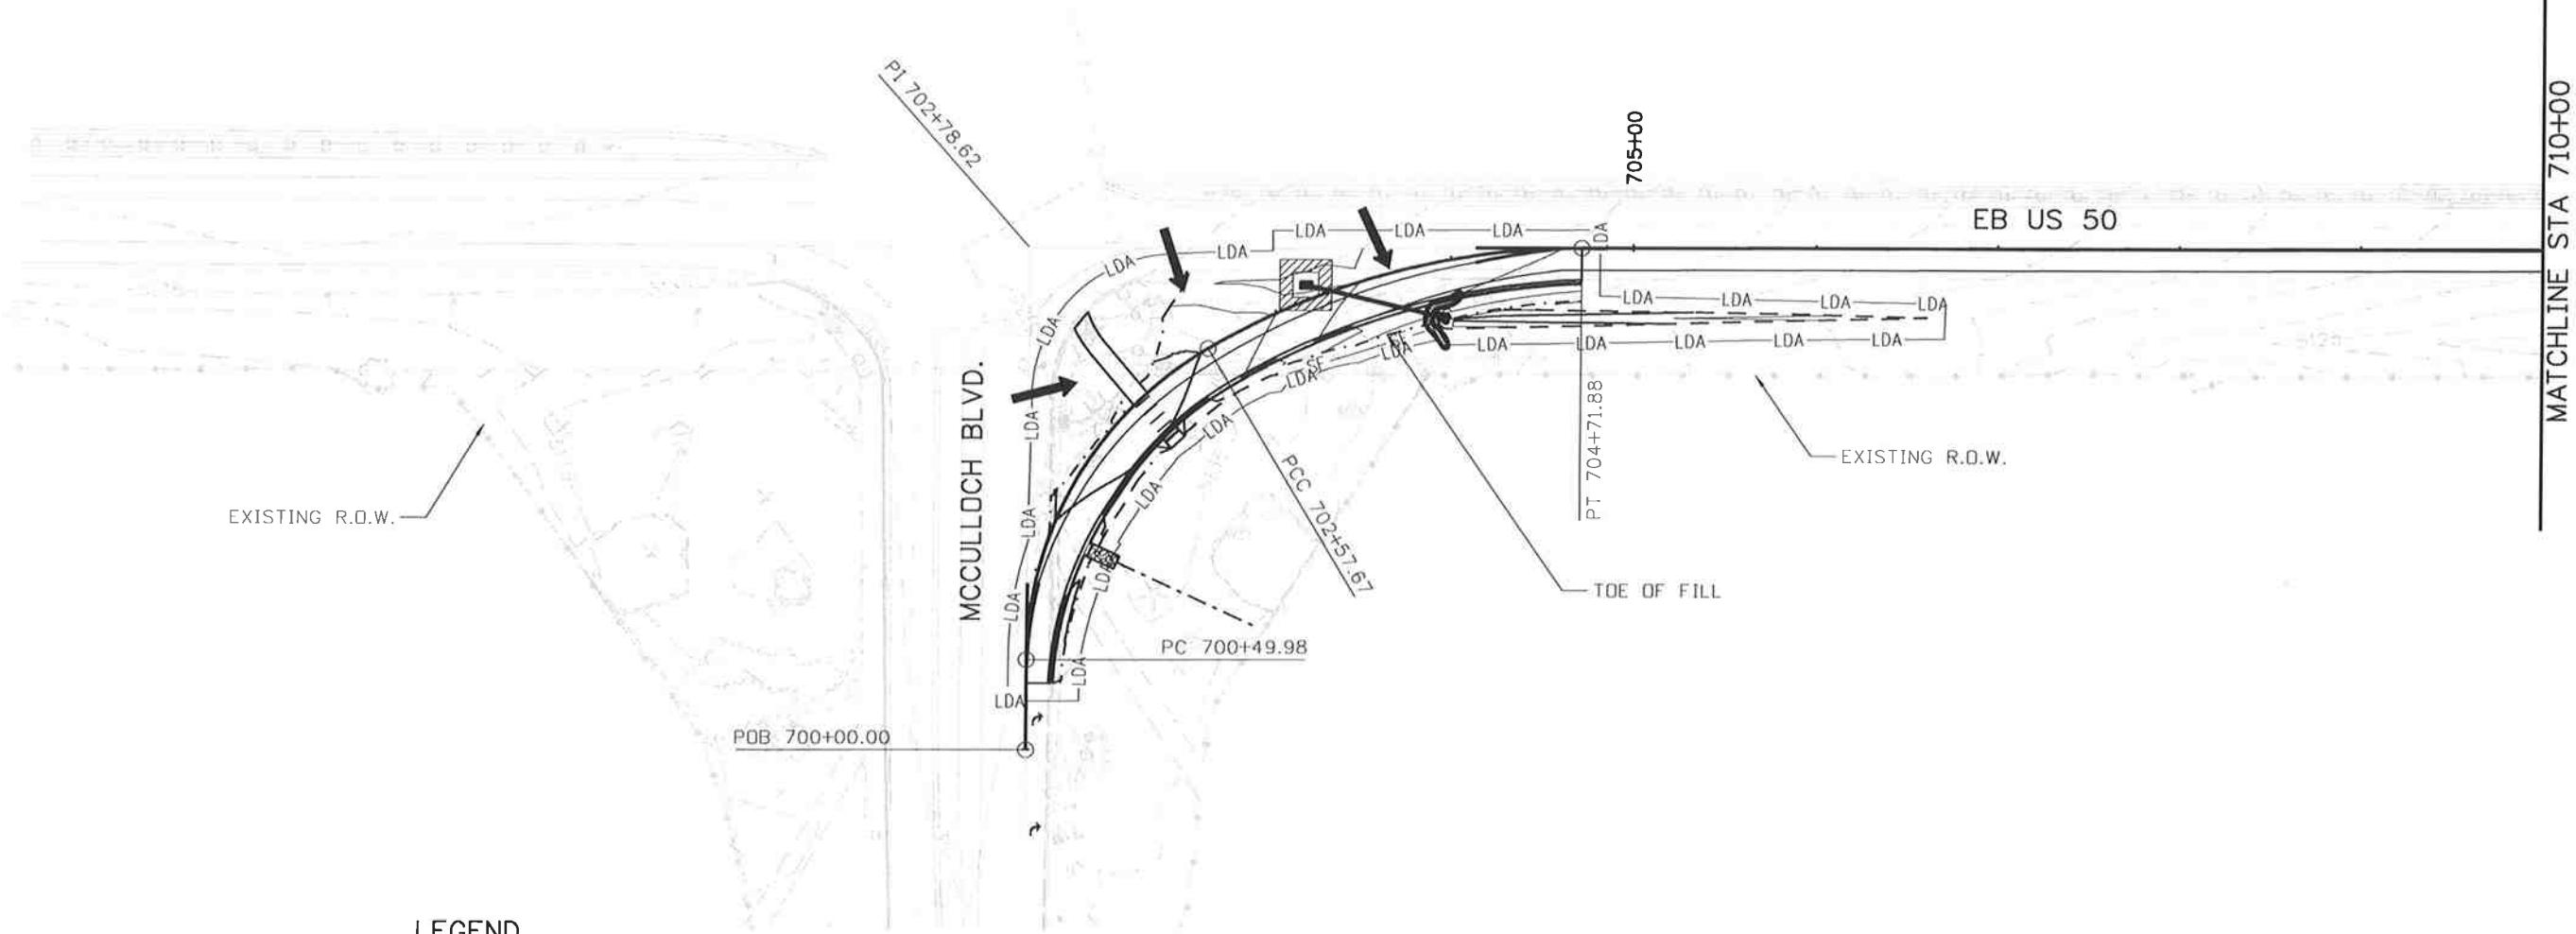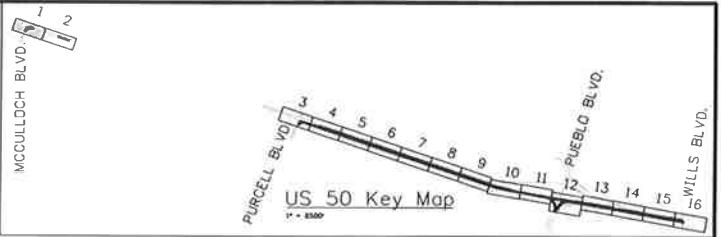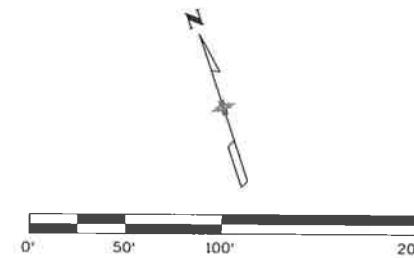	EROSION LOG DITCH CHECK
	VEHICLE TRACKING PADS
	CONCRETE WASHOUT STRUCTURE
	SILT FENCE
	LIMITS OF DISTURBANCE
	DIRECTION OF SURFACE FLOW
	AGGREGATE BAG CURB CHECK
	DROP INLET PROTECTION
	STORM DRAIN INLET PROTECTION
	PIPE EROSION LOG
	PIPE EROSION LOG-INLET
	WETLAND
	RIPRAP

- NOTES:**
- ECS TO UPDATE SITE MAPS DURING CONSTRUCTION.
 - ALL DISTURBED AREAS NOT TO BE PAVED SHALL HAVE AN APPLICATION OF SEED(NATIVE), MULCH(WEEED), AND MULCH TACKIFIER.
 - THE EROSION LOG DITCH CHECK SYMBOL IS NOT SHOWN TO SCALE. THE ACTUAL LENGTH IS DEFINED AS THE DISTANCE FROM PROPOSED EDGE OF ROAD TO PROPOSED TOE OF SLOPE.

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Sheet Revisions

Date:	Comments	Init.

Colorado Department of Transportation
Region 2
902 Erie Avenue
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Phone: 719-562-5509 FAX: 719-546-5702

DTD

As Constructed

No Revisions:

Revised:

Void:

**US 50 WEST
MCCULLOCH BLVD.
EROSION CONTROL PLAN- INITIAL**

Project No./Code

FSA 0503-081



19751

Sheet Number 205

Subset Sheets: ECO1 of 16



**Know what's below.
Call before you dig.**

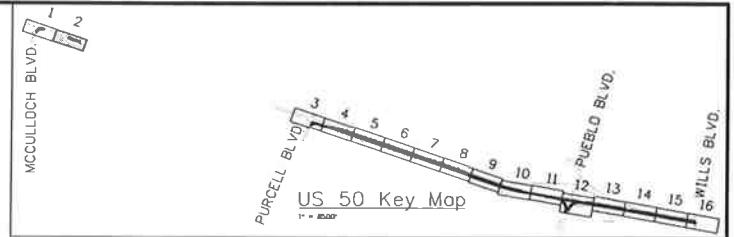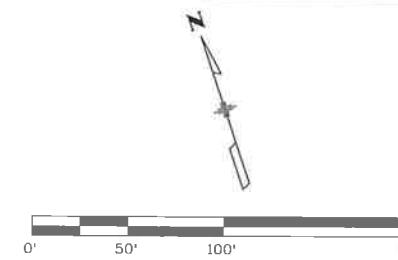

MATCH| INF STA 710±00

715-00

7200

— EXISTING R.O.W.

LEGEND

	EROSION LOG DITCH CHECK		AGGREGATE BAG CURB CHECK
	VEHICLE TRACKING PADS		DROP INLET PROTECTION
	CONCRETE WASHOUT STRUCTURE		STORM DRAIN INLET PROTECTION
	SILT FENCE		PIPE EROSION LOG
	LIMITS OF DISTURBANCE		PIPE EROSION LOG-INLET
	DIRECTION OF SURFACE FLOW		WETLAND

१५८

RIPRAP

- NOTES:

 1. ECS TO UPDATE SITE MAPS DURING CONSTRUCTION.
 2. ALL DISTURBED AREAS NOT TO BE PAVED SHALL HAVE AN APPLICATION OF SEED(NATIVE), MULCH(WEEED), AND MULCH TACKIFIER.
 3. THE EROSION LOG DITCH CHECK SYMBOL IS NOT SHOWN TO SCALE. THE ACTUAL LENGTH IS DEFINED AS THE DISTANCE FROM PROPOSED EDGE OF ROAD TO PROPOSED TOE OF SLOPE.

100

Sheet Revision	
Date:	Comments

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As Constructed		US 50 WEST MCCULLOCH BLVD. <u>EROSION CONTROL PLAN- INITIAL</u>			Project No./Code	
No Revisions:					FSA 0503-081	
Revised:		Designer:	AB	Structure		
		Detailer:	AB	Numbers		
Void:		Subset:	EC	Subsel Sheets:	EC02 of 16	Sheet Number 206




**Know what's below.
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0' 50' 100' 200'



EXISTING R.O.W.

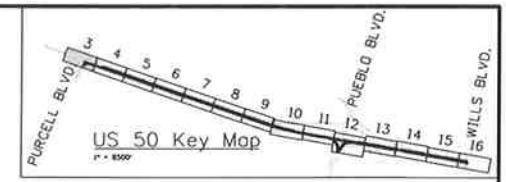

WB US 50

EB US 50

EXISTING R.O.W.

LEGEND


- EROSION LOG DITCH CHECK
- VEHICLE TRACKING PADS
- CONCRETE WASHOUT STRUCTURE
- SF — SILT FENCE
- LDA — LIMITS OF DISTURBANCE
- DIRECTION OF SURFACE FLOW

- AGGREGATE BAG CURB CHECK
- DROP INLET PROTECTION
- STORM DRAIN INLET PROTECTION
- PIPE EROSION LOG
- PIPE EROSION LOG-INLET
- WETLAND



RIPRAP

PURCELL BLVD.

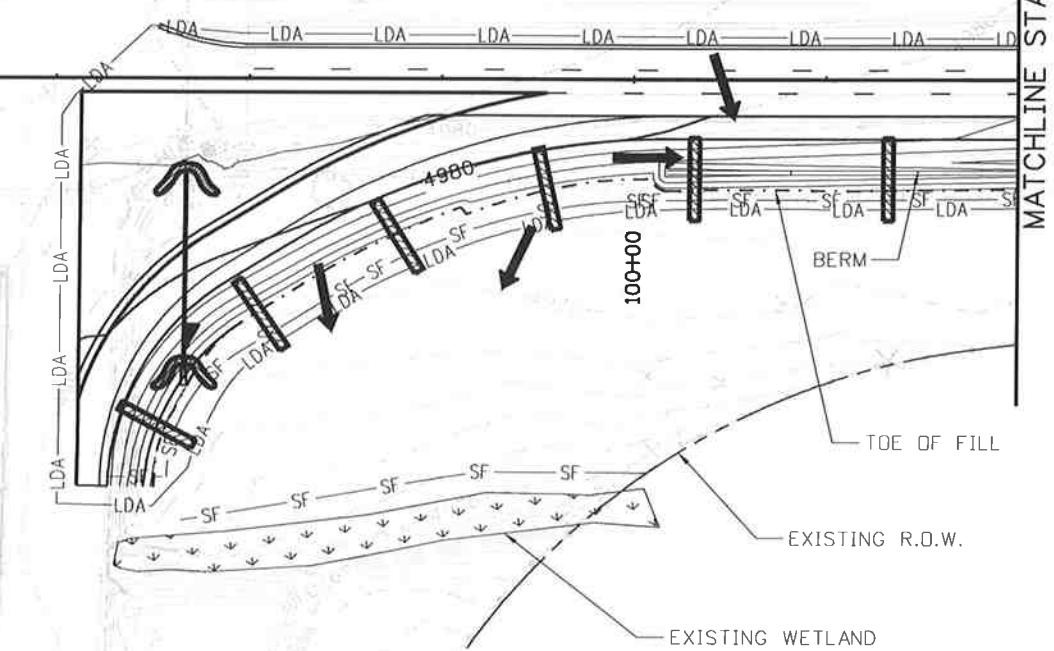

- NOTES:
- ECS TO UPDATE SITE MAPS DURING CONSTRUCTION.
 - ALL DISTURBED AREAS NOT TO BE PAVED SHALL HAVE AN APPLICATION OF SEED(NATIVE), MULCH(WEEED), AND MULCH TACKIFIER.
 - THE EROSION LOG DITCH CHECK SYMBOL IS NOT SHOWN TO SCALE. THE ACTUAL LENGTH IS DEFINED AS THE DISTANCE FROM PROPOSED EDGE OF ROAD TO PROPOSED TOE OF SLOPE.

Print Date: 10/28/2014

File Name: I9056DES_SWMP_03_Plan.dgn

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No Revisions:

Revised:

Void:

US 50 WEST
PURCELL BLVD. TO WILLS BLVD.
EROSION CONTROL PLAN- INITIAL

Project No./Code

FSA 0503-081

19751

Sheet Number 207



DTD

Subset: EC Subset Sheets: ECO3 of 16



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0' 50' 100' 200'

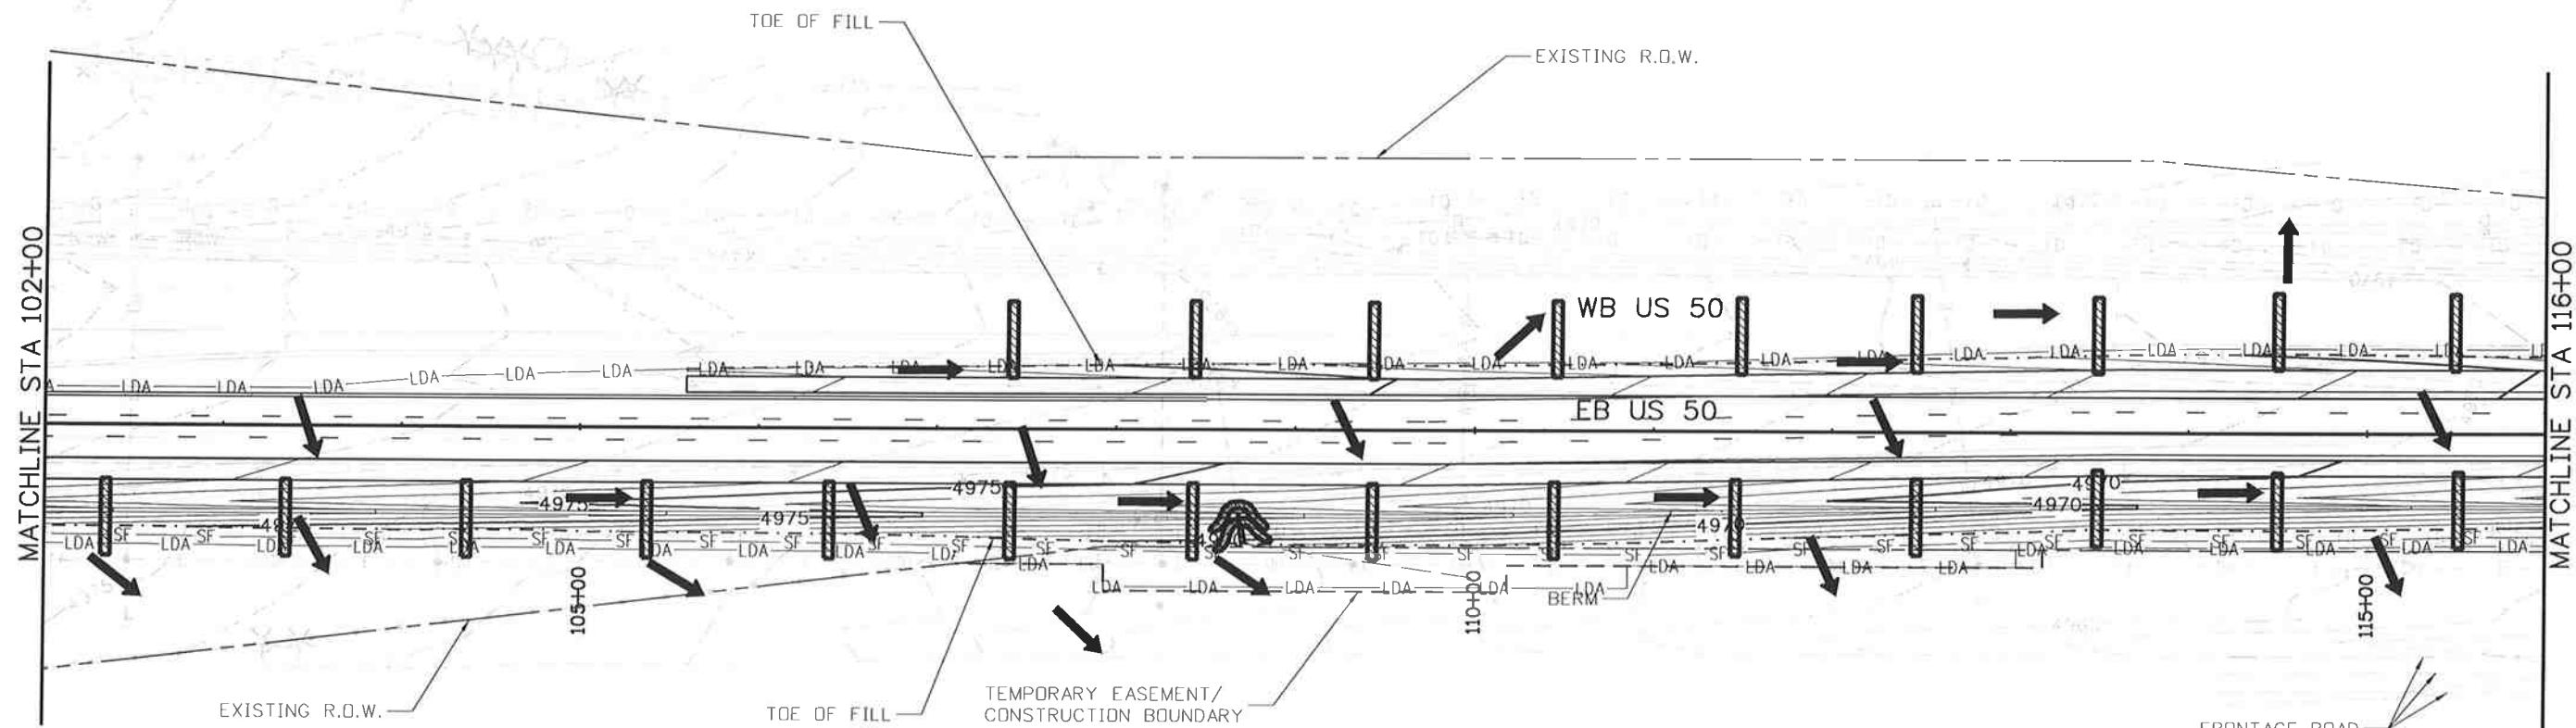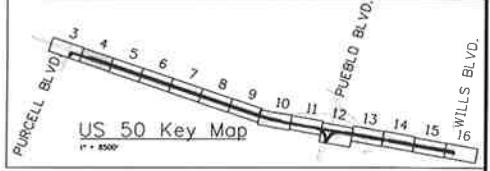

LEGEND

	EROSION LOG DITCH CHECK
	VEHICLE TRACKING PADS
	CONCRETE WASHOUT STRUCTURE
	SILT FENCE
	LIMITS OF DISTURBANCE
	DIRECTION OF SURFACE FLOW
	AGGREGATE BAG CURB CHECK
	DROP INLET PROTECTION
	STORM DRAIN INLET PROTECTION
	PIPE EROSION LOG
	PIPE EROSION LOG-INLET
	WETLAND
	RIPRAP

- NOTES:
1. ECS TO UPDATE SITE MAPS DURING CONSTRUCTION.
 2. ALL DISTURBED AREAS NOT TO BE PAVED SHALL HAVE AN APPLICATION OF SEED(NATIVE), MULCH(WEEED), AND MULCH TACKIFIER.
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Print Date: 10/28/2014

File Name: 19056DES_SWMP_04_Plan.dgn

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US 50 WEST
PURCELL BLVD. TO WILLS BLVD.
EROSION CONTROL PLAN- INITIAL

Project No./Code

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Sheet Number 208

Subset: EC Subset Sheets: ECO4 of 16

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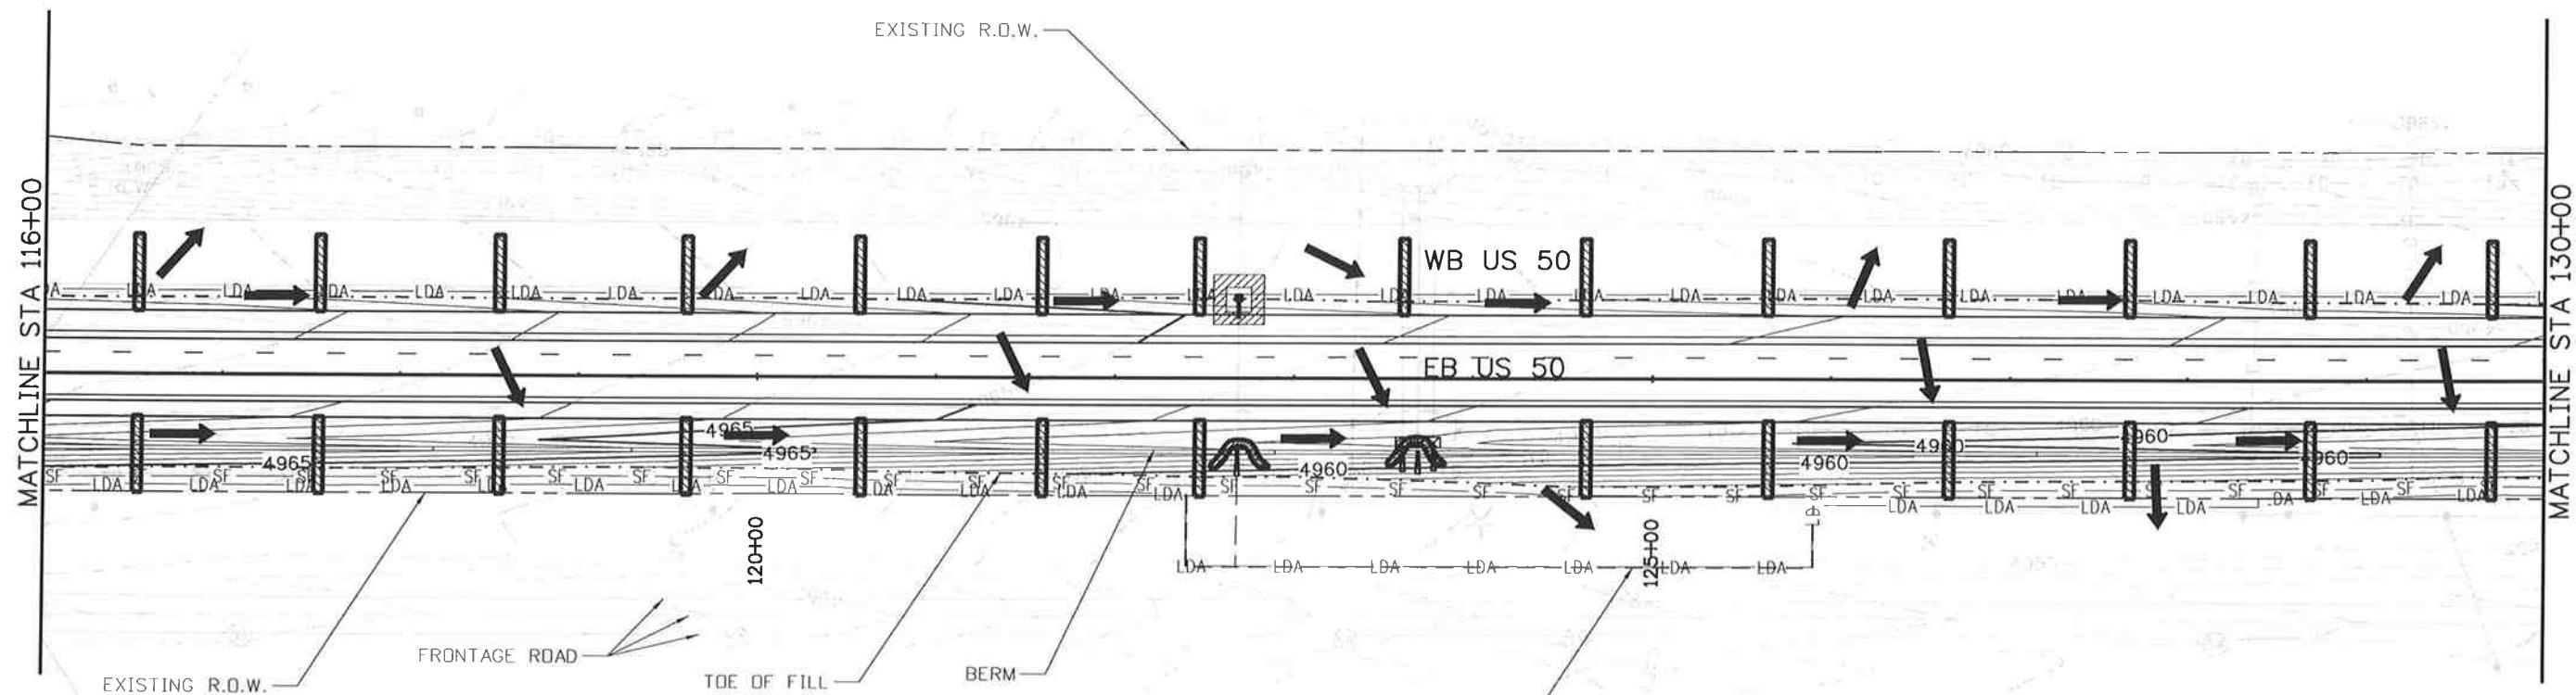
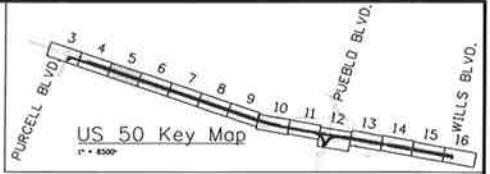
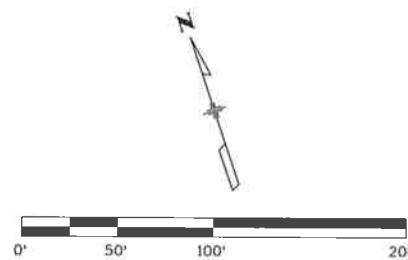
Designer: AB Structure Numbers

Detailer: AB

Subset: EC Subset Sheets: ECO4 of 16



**Know what's below.
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LEGEND

	EROSION LOG DITCH CHECK		AGGREGATE BAG CURB CHECK		TEMPORARY EASEMENT/CONSTRUCTION BOUNDARY
	VEHICLE TRACKING PADS		DROP INLET PROTECTION		
	CONCRETE WASHOUT STRUCTURE		STORM DRAIN INLET PROTECTION		
	SILT FENCE		PIPE EROSION LOG		
	LIMITS OF DISTURBANCE		PIPE EROSION LOG-INLET		
	DIRECTION OF SURFACE FLOW		WETLAND		RIPRAP

- NOTES:
1. ECS TO UPDATE SITE MAPS DURING CONSTRUCTION.
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File Name: I9056DES_SWMP_05_Plan.dgn

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PURCELL BLVD. TO WILLS BLVD.
EROSION CONTROL PLAN-INITIAL

Project No./Code

FSA 0503-081


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Sheet Number 209



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Z.



LEGEND

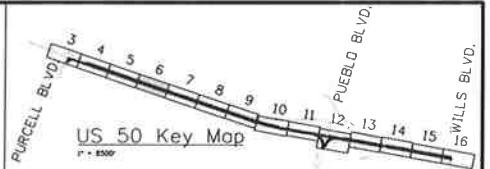	EROSION LOG DITCH CHECK
	VEHICLE TRACKING PADS
	CONCRETE WASHOUT STRUCT
— SF —	SILT FENCE
-LDA—	LIMITS OF DISTURBANCE
	DIRECTION OF SURFACE FLOW

-  AGGREGATE BAG CURB CHECK
-  DROP INLET PROTECTION
-  STORM DRAIN INLET PROTECTION
-  PIPE EROSION LOG
-  PIPE EROSION LOG-INLET
-  WETLAND

RIPRAP

Print Date: 10/28/2014

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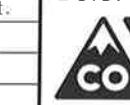
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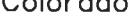
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Littleton, Colorado 80120

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Sheet Revision

Date:	Comments
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Colorado Department of Transportation
 902 Erie Avenue
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Region 2 DTD

As Constructed

AS 8011

US 50 WEST
PURCELL BLVD. TO WILLS BLVD.
EROSION CONTROL PLAN-INITIAL

Project No./Code




Object No. 9

107E1

Sheet Number 210



**Know what's below.
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LEGEND

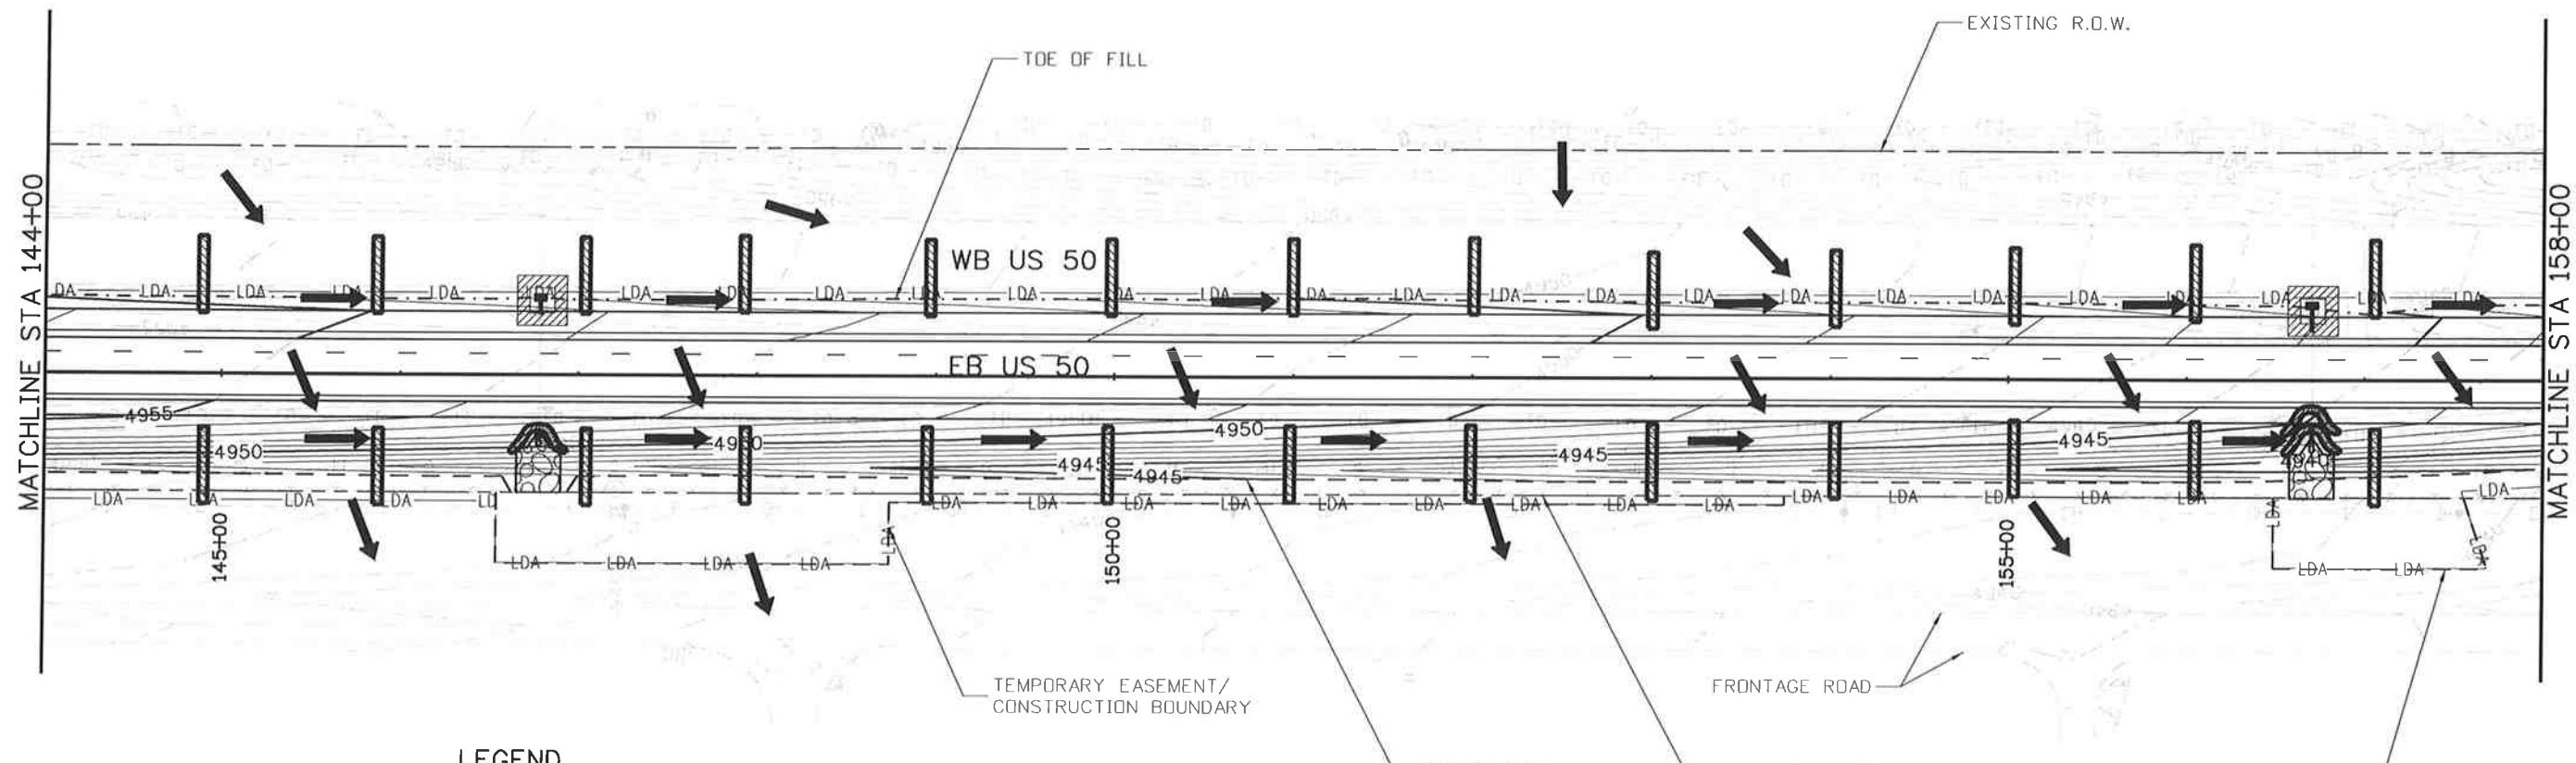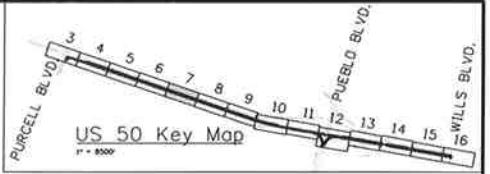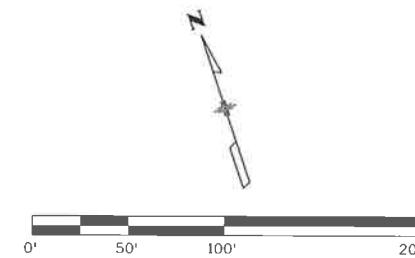	EROSION LOG DITCH CHECK		AGGREGATE BAG CURB CHECK
	VEHICLE TRACKING PADS		DROP INLET PROTECTION
	CONCRETE WASHOUT STRUCTURE		STORM DRAIN INLET PROTECTION
	SILT FENCE		PIPE EROSION LOG
	LIMITS OF DISTURBANCE		PIPE EROSION LOG-INLET
	DIRECTION OF SURFACE FLOW		WETLAND
			RIPRAP

NOTES:



1. ECS TO UPDATE SITE MAPS DURING CONSTRUCTION.
2. ALL DISTURBED AREAS NOT TO BE PAVED SHALL HAVE AN APPLICATION OF SEED(NATIVE), MULCH(WEEED), AND MULCH TACKIFIER.
3. THE EROSION LOG DITCH CHECK SYMBOL IS NOT SHOWN TO SCALE. THE ACTUAL LENGTH IS DEFINED AS THE DISTANCE FROM PROPOSED EDGE OF ROAD TO PROPOSED TOE OF SLOPE.

Print Date: 10/28/2014		Sheet Revisions			 Colorado Department of Transportation 902 Erie Avenue Pueblo, CO 81001 Phone: 719-562-5509 FAX: 719-546-5702 Region 2	As Constructed		US 50 WEST		Project No./Code	
File Name: 19056DES_SWMP_07_Plan.dgn		Date:	Comments	Init.		No Revisions:	PURCELL	BLVD. TO WILLS BLVD.	FSA 0503-081		
Horiz. Scale: 1:100	Vert. Scale: As Noted					Revised:	EROSION	CONTROL PLAN-INITIAL	19751		
JFS & A	J. F. SATO AND ASSOCIATES					Designer:	AB	Structure	Sheet Number 211		
5898 South Rapp Street	Littleton, Colorado 80120					Detailer:	AB	Numbers			
						Void:	Subset:	EC	Subset Sheets: ECO7 of 16		



**Know what's below.
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0' 50' 100' 200'

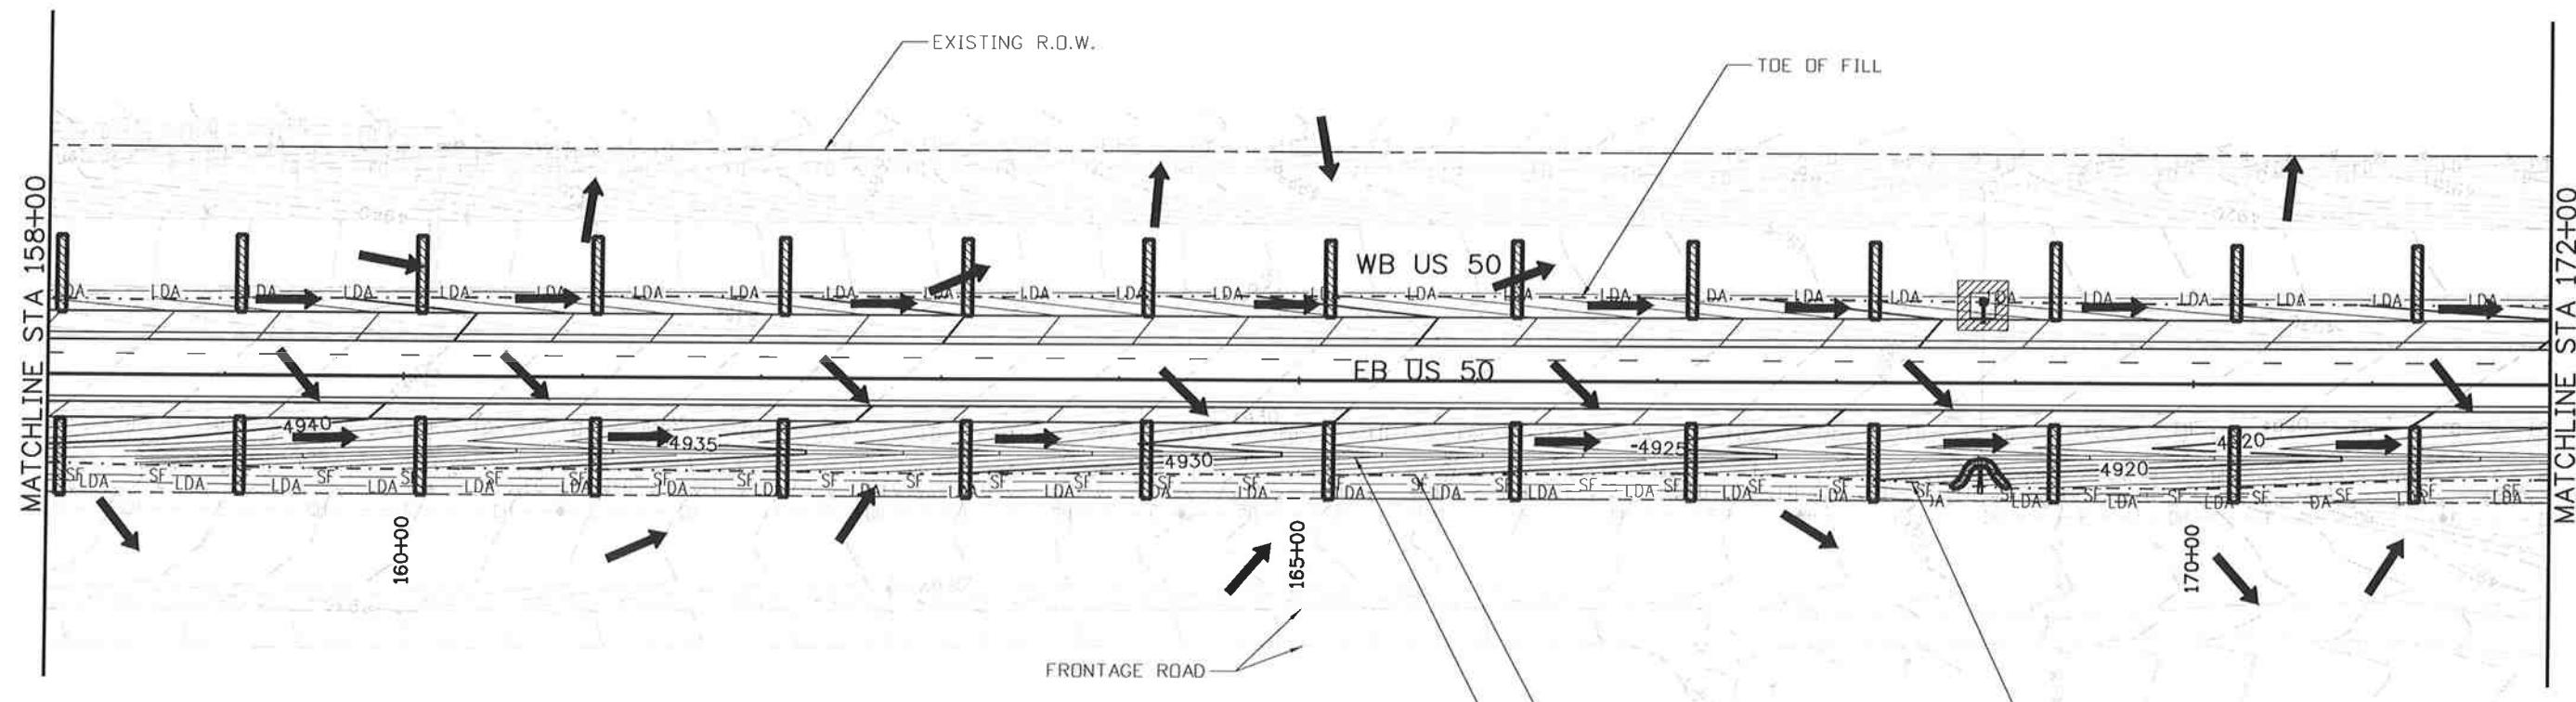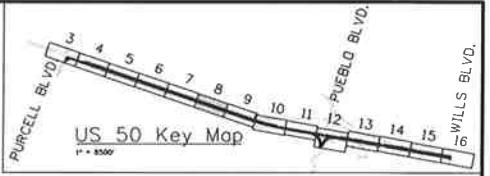

LEGEND

	EROSION LOG DITCH CHECK
	VEHICLE TRACKING PADS
	CONCRETE WASHOUT STRUCTURE
	SILT FENCE
	LIMITS OF DISTURBANCE
	DIRECTION OF SURFACE FLOW
	AGGREGATE BAG CURB CHECK
	DROP INLET PROTECTION
	STORM DRAIN INLET PROTECTION
	PIPE EROSION LOG
	PIPE EROSION LOG-INLET
	WETLAND
	RIPRAP

- NOTES:
1. ECS TO UPDATE SITE MAPS DURING CONSTRUCTION.
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File Name: 19056DES_SWMP_08_Plan.dgn

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Region 2
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No Revisions:

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Void:

US 50 WEST
PURCELL BLVD. TO WILLS BLVD.
EROSION CONTROL PLAN-INITIAL

Project No./Code

FSA 0503-081




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Sheet Number 212

Designer: AB	Structure Numbers
Detailer: AB	
Subset: EC	Subset Sheets: EC08 of 16



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LEGEND

	EROSION LOG DITCH CHECK
	VEHICLE TRACKING PADS
	CONCRETE WASHOUT STRUCTURE
	SILT FENCE
	LIMITS OF DISTURBANCE
	DIRECTION OF SURFACE FLOW
	AGGREGATE BAG CURB CHECK
	DROP INLET PROTECTION
	STORM DRAIN INLET PROTECTION
	PIPE EROSION LOG
	PIPE EROSION LOG-INLET
	WETLAND
	RIPRAP

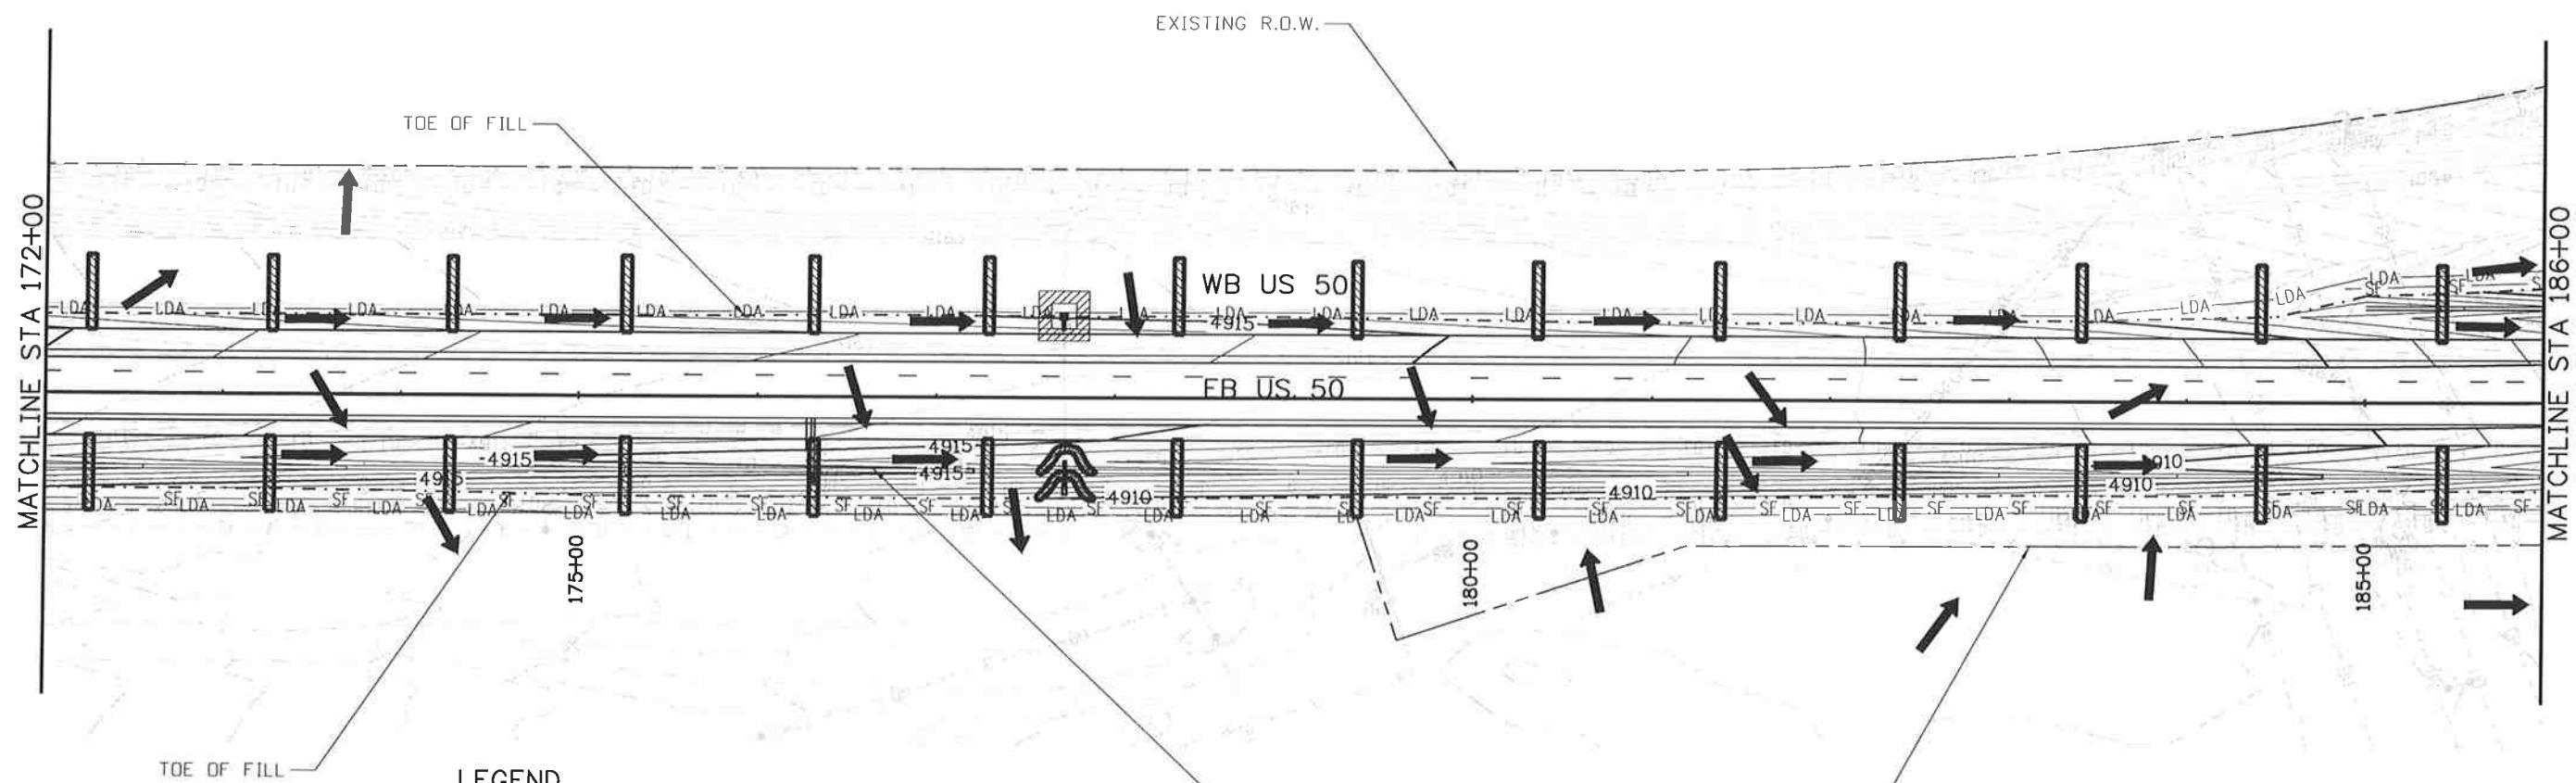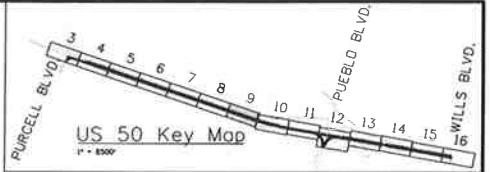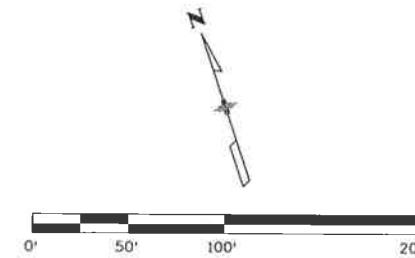- NOTES:
1. ECS TO UPDATE SITE MAPS DURING CONSTRUCTION.
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File Name: I9056DES_SWMP_09_Plan.dgn

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EROSION CONTROL PLAN-INITIAL

Project No./Code

FSA 0503-081

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Sheet Number 213

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Designer: AB
Detailer: AB
Subset: EC
Structure Numbers
Subset Sheets: EC09 of 16




**Know what's below.
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0' 50' 100' 150'

Call before you dig.



LEGEND

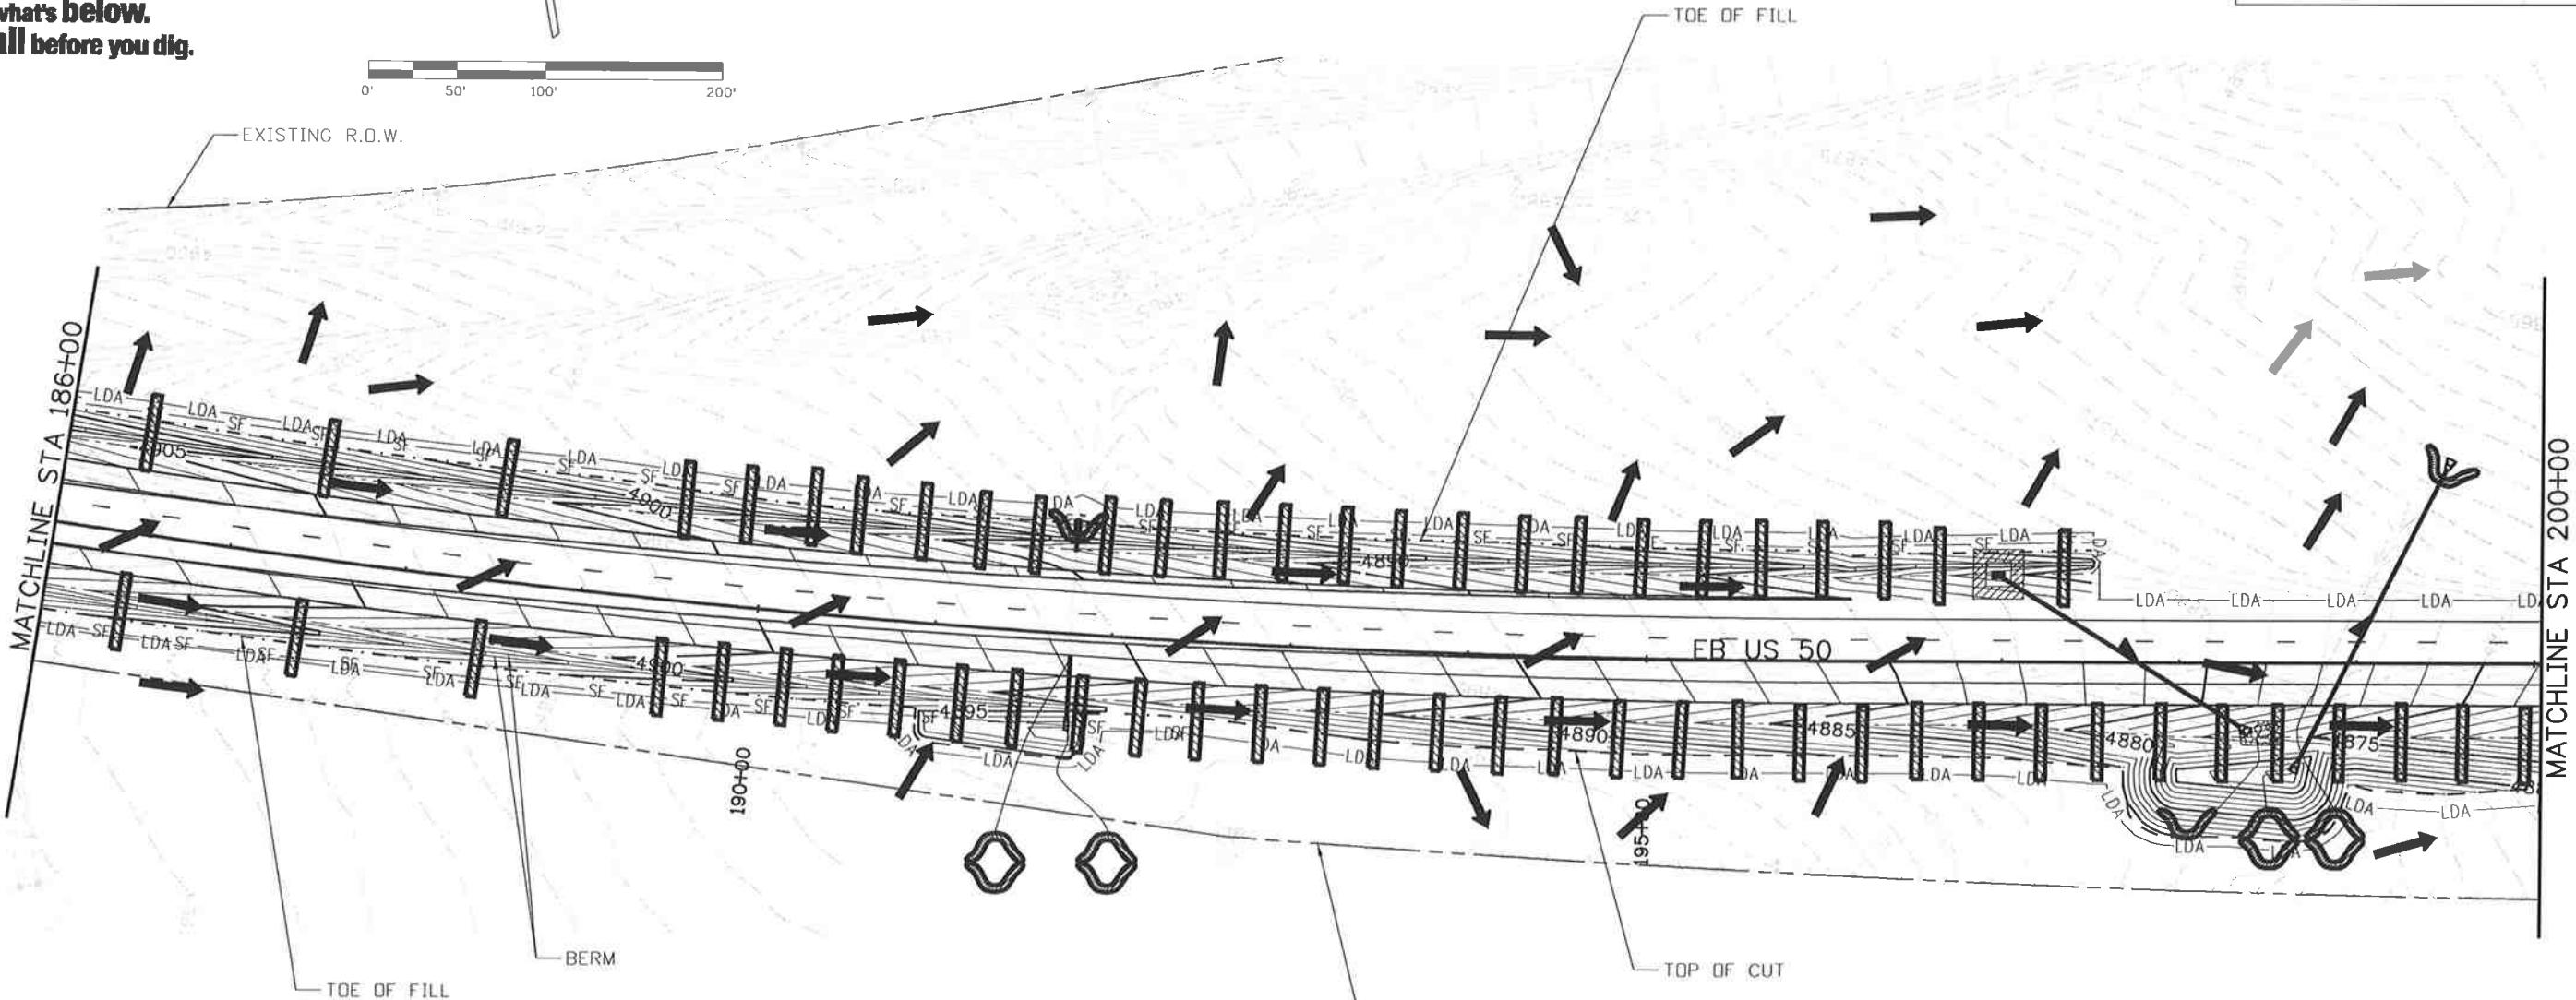LEGEND




- EROSION LOG DITCH CHECK
- AGGREGATE BAG CURB CHECK
- EXISTING ROAD
- VEHICLE TRACKING PADS
- DROP INLET PROTECTION
- CW CONCRETE WASHOUT STRUCTURE
- STORM DRAIN INLET PROTECTION
- SILT FENCE
- PIPE EROSION LOG
- Limits of Disturbance
- PIPE EROSION LOG-INLET
- DIRECTION OF SURFACE FLOW
- WETLAND
- RIPRAP

NOTES:

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**Know what's below.
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LEGEND

	EROSION LOG DITCH CHECK
	VEHICLE TRACKING PADS
	CONCRETE WASHOUT STRUCTURE
	SILT FENCE
	LIMITS OF DISTURBANCE
	DIRECTION OF SURFACE FLOW
	AGGREGATE BAG CURB CHECK
	DROP INLET PROTECTION
	STORM DRAIN INLET PROTECTION
	PIPE EROSION LOG
	PIPE EROSION LOG-INLET
	WETLAND
	RIPRAP

- NOTES:
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Print Date: 10/28/2014

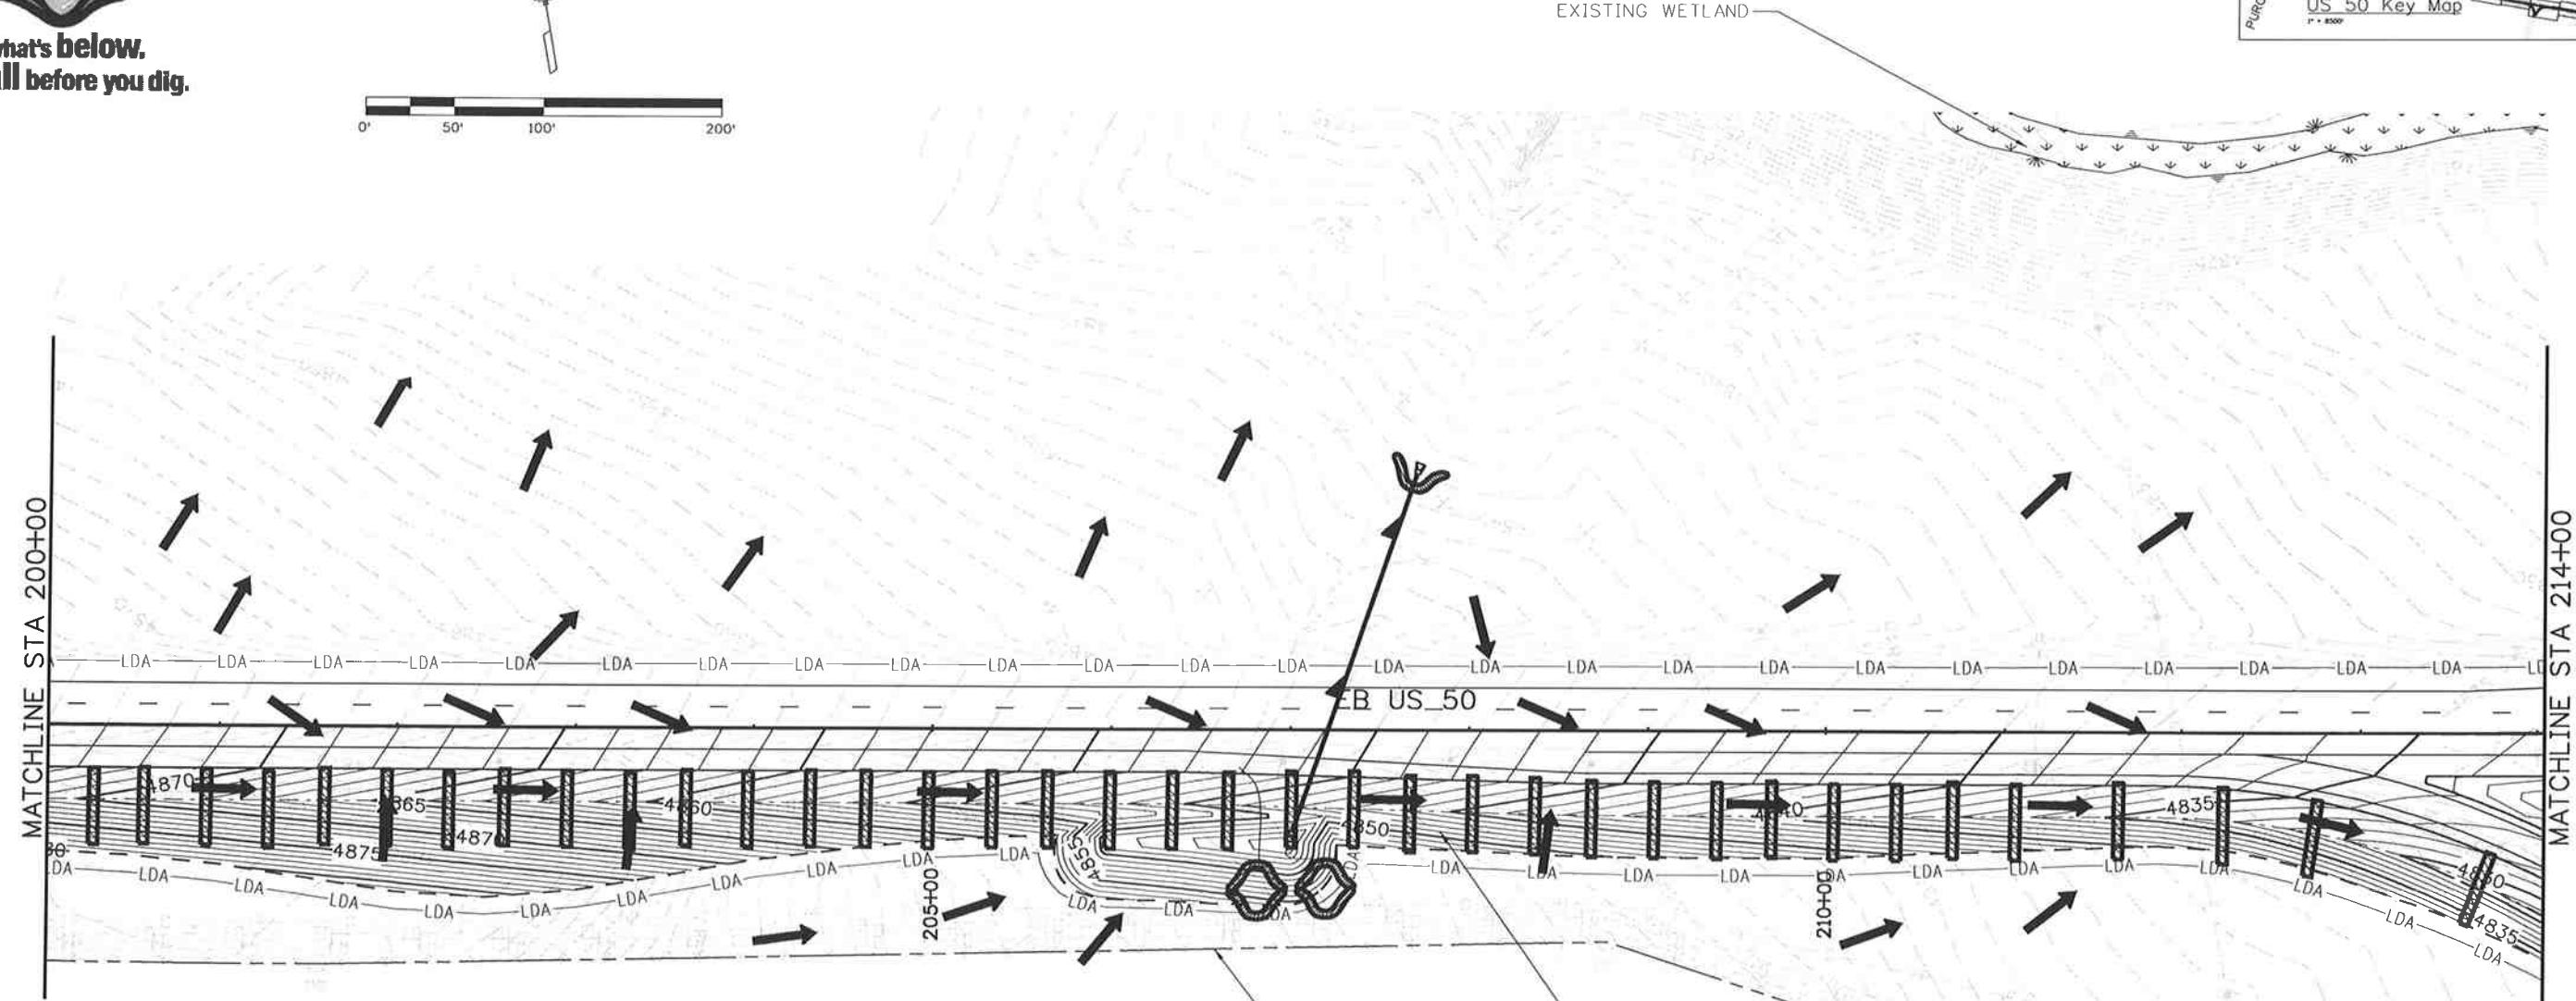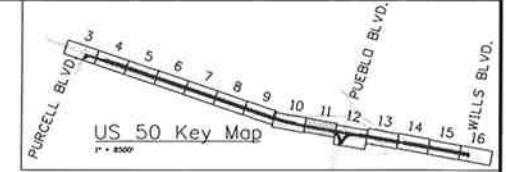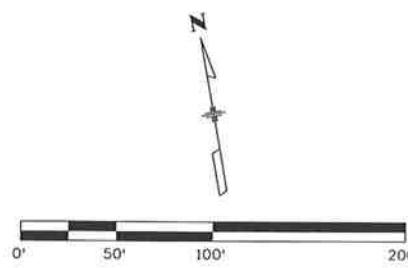File Name: 19056DES_SWMP_11_Plan.dgn

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Revised:

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US 50 WEST
 PURCELL BLVD. TO WILLS BLVD.
 EROSION CONTROL PLAN-INITIAL

Project No./Code


FSA 0503-081

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Sheet Number 215



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Print Date: 10/28/2014

File Name: I9056DES_SWMP_12_Plan.dgn
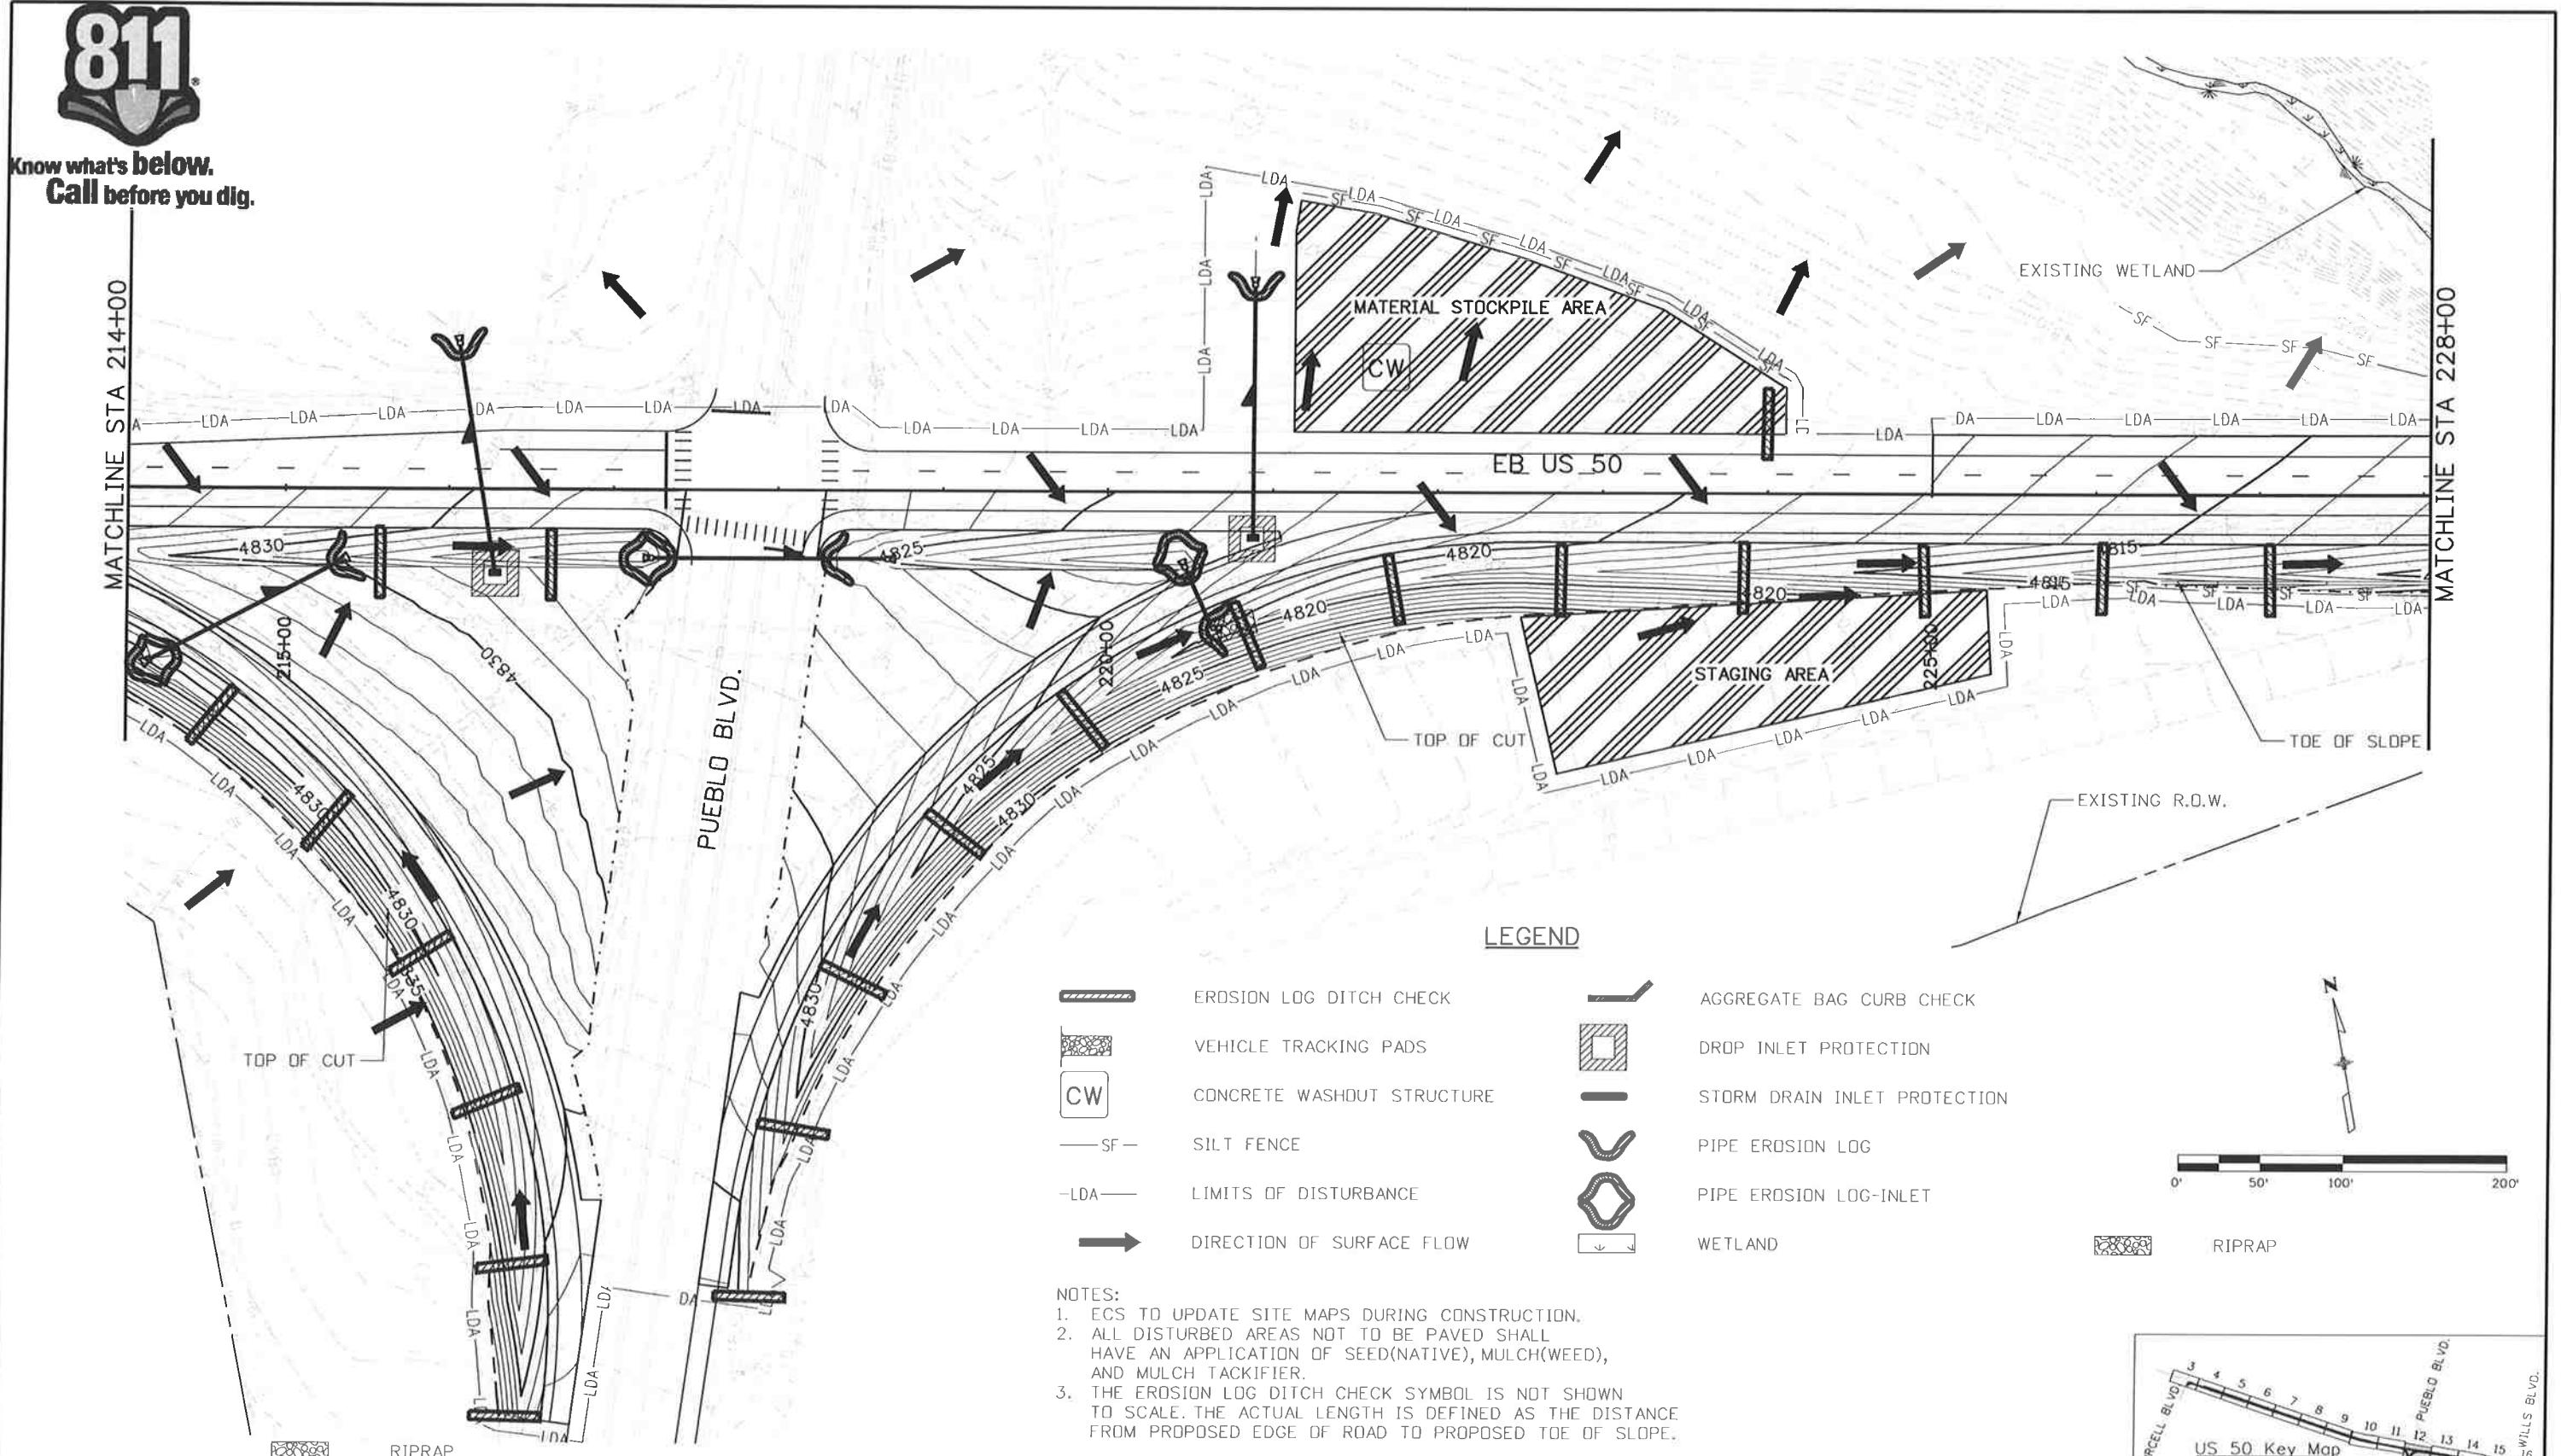
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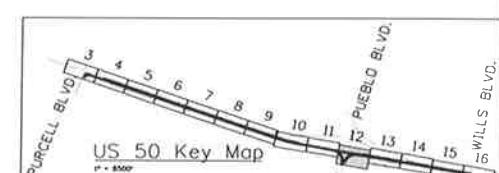
US 50 WEST:
PURCELL BLVD. TO WILLS BLVD.
EROSION CONTROL PLAN-INITIAL

Project No./Code

FSA 0503-081



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Sheet Number 216





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LEGEND

	EROSION LOG DITCH CHECK
	VEHICLE TRACKING PADS
	CONCRETE WASHOUT STRUCTURE
	SILT FENCE
	LIMITS OF DISTURBANCE
	DIRECTION OF SURFACE FLOW
	AGGREGATE BAG CURB CHECK
	DROP INLET PROTECTION
	STORM DRAIN INLET PROTECTION
	PIPE EROSION LOG
	PIPE EROSION LOG-INLET
	WETLAND
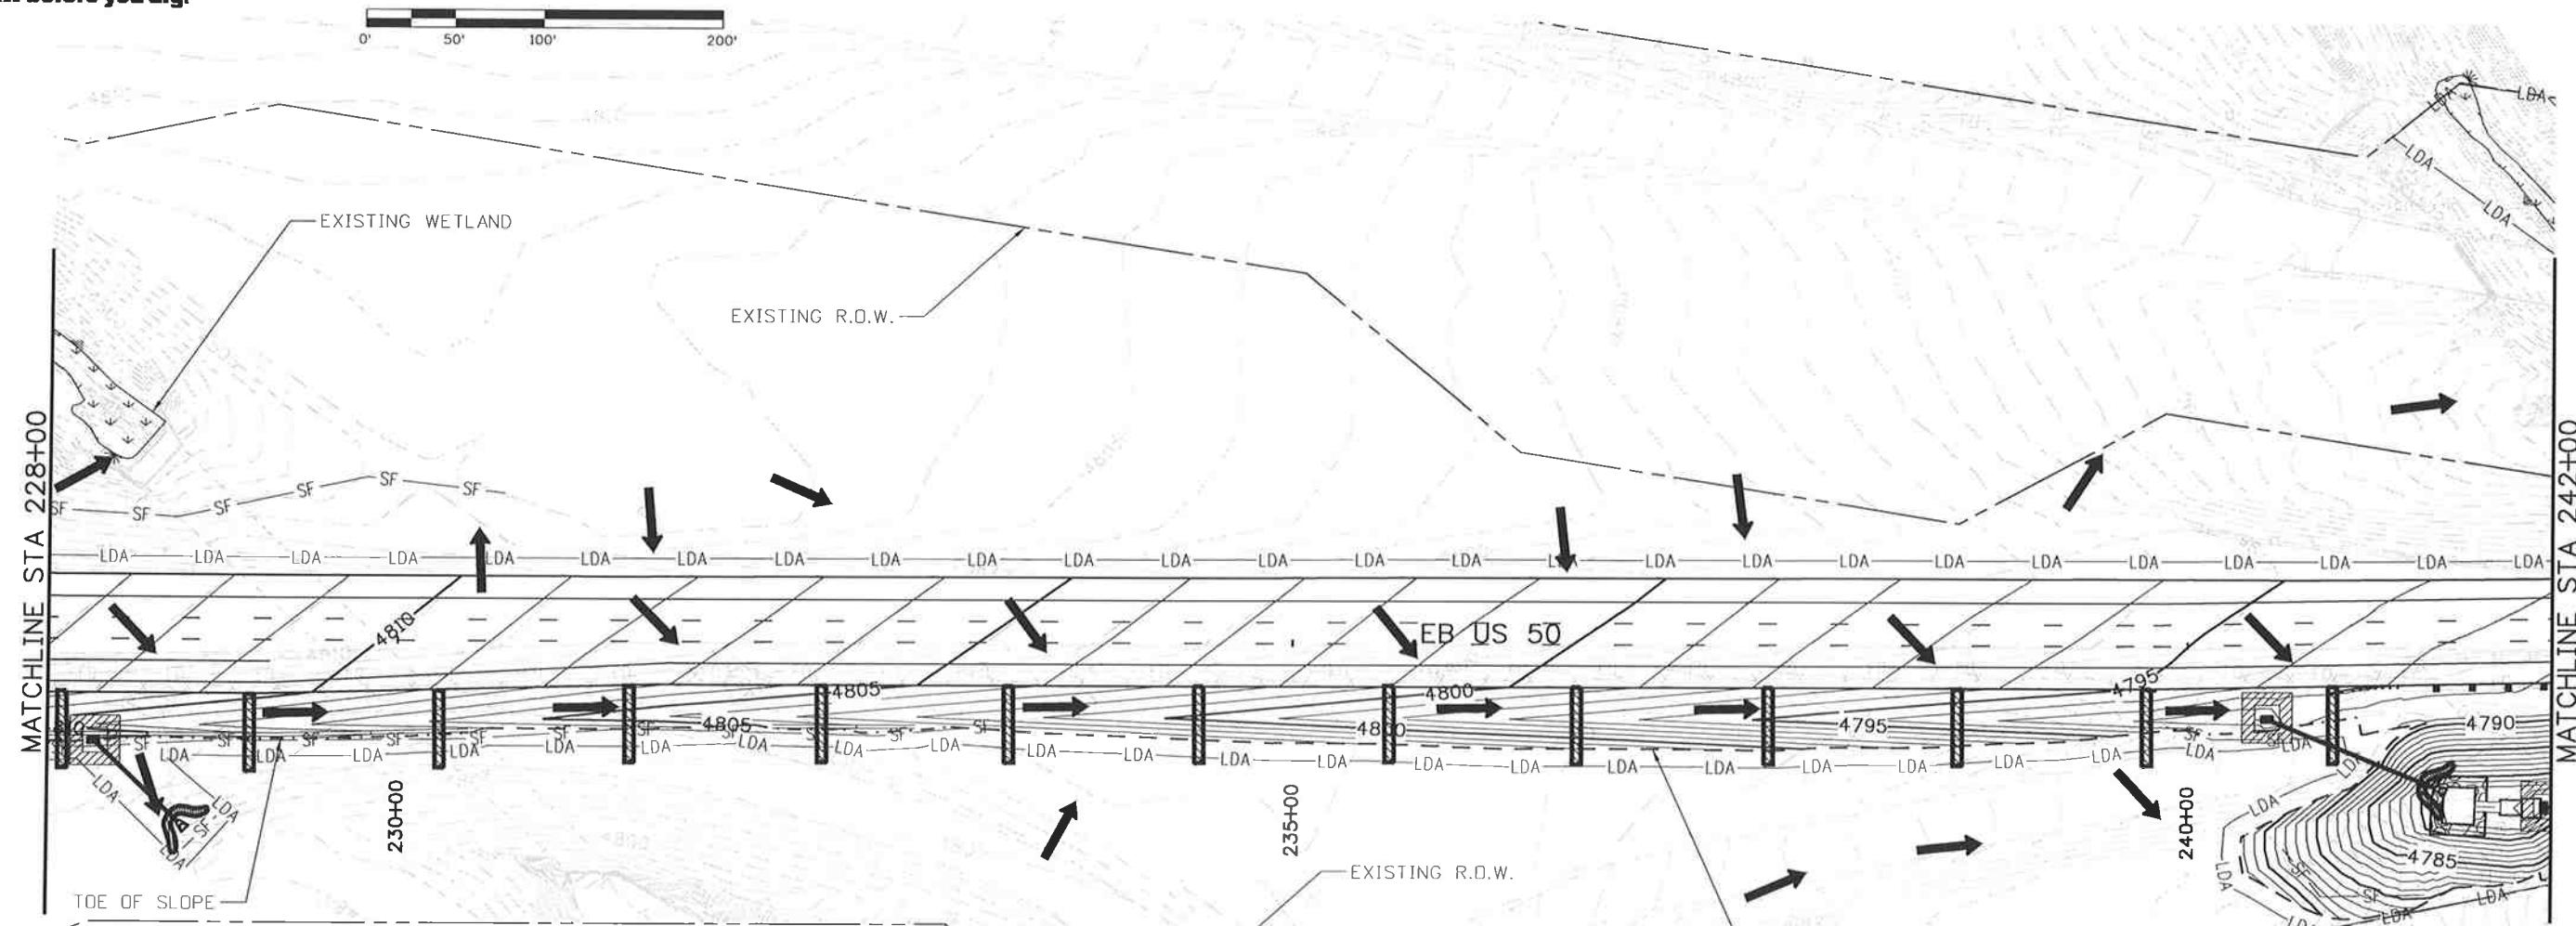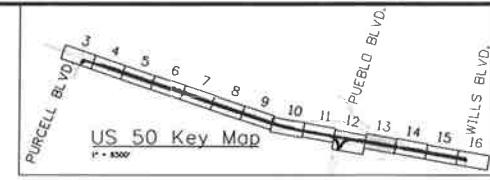
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- NOTES:

 1. ECS TO UPDATE SITE MAPS DURING CONSTRUCTION.
 2. ALL DISTURBED AREAS NOT TO BE PAVED SHALL HAVE AN APPLICATION OF SEED(NATIVE), MULCH(WEEED), AND MULCH TACKIFIER.
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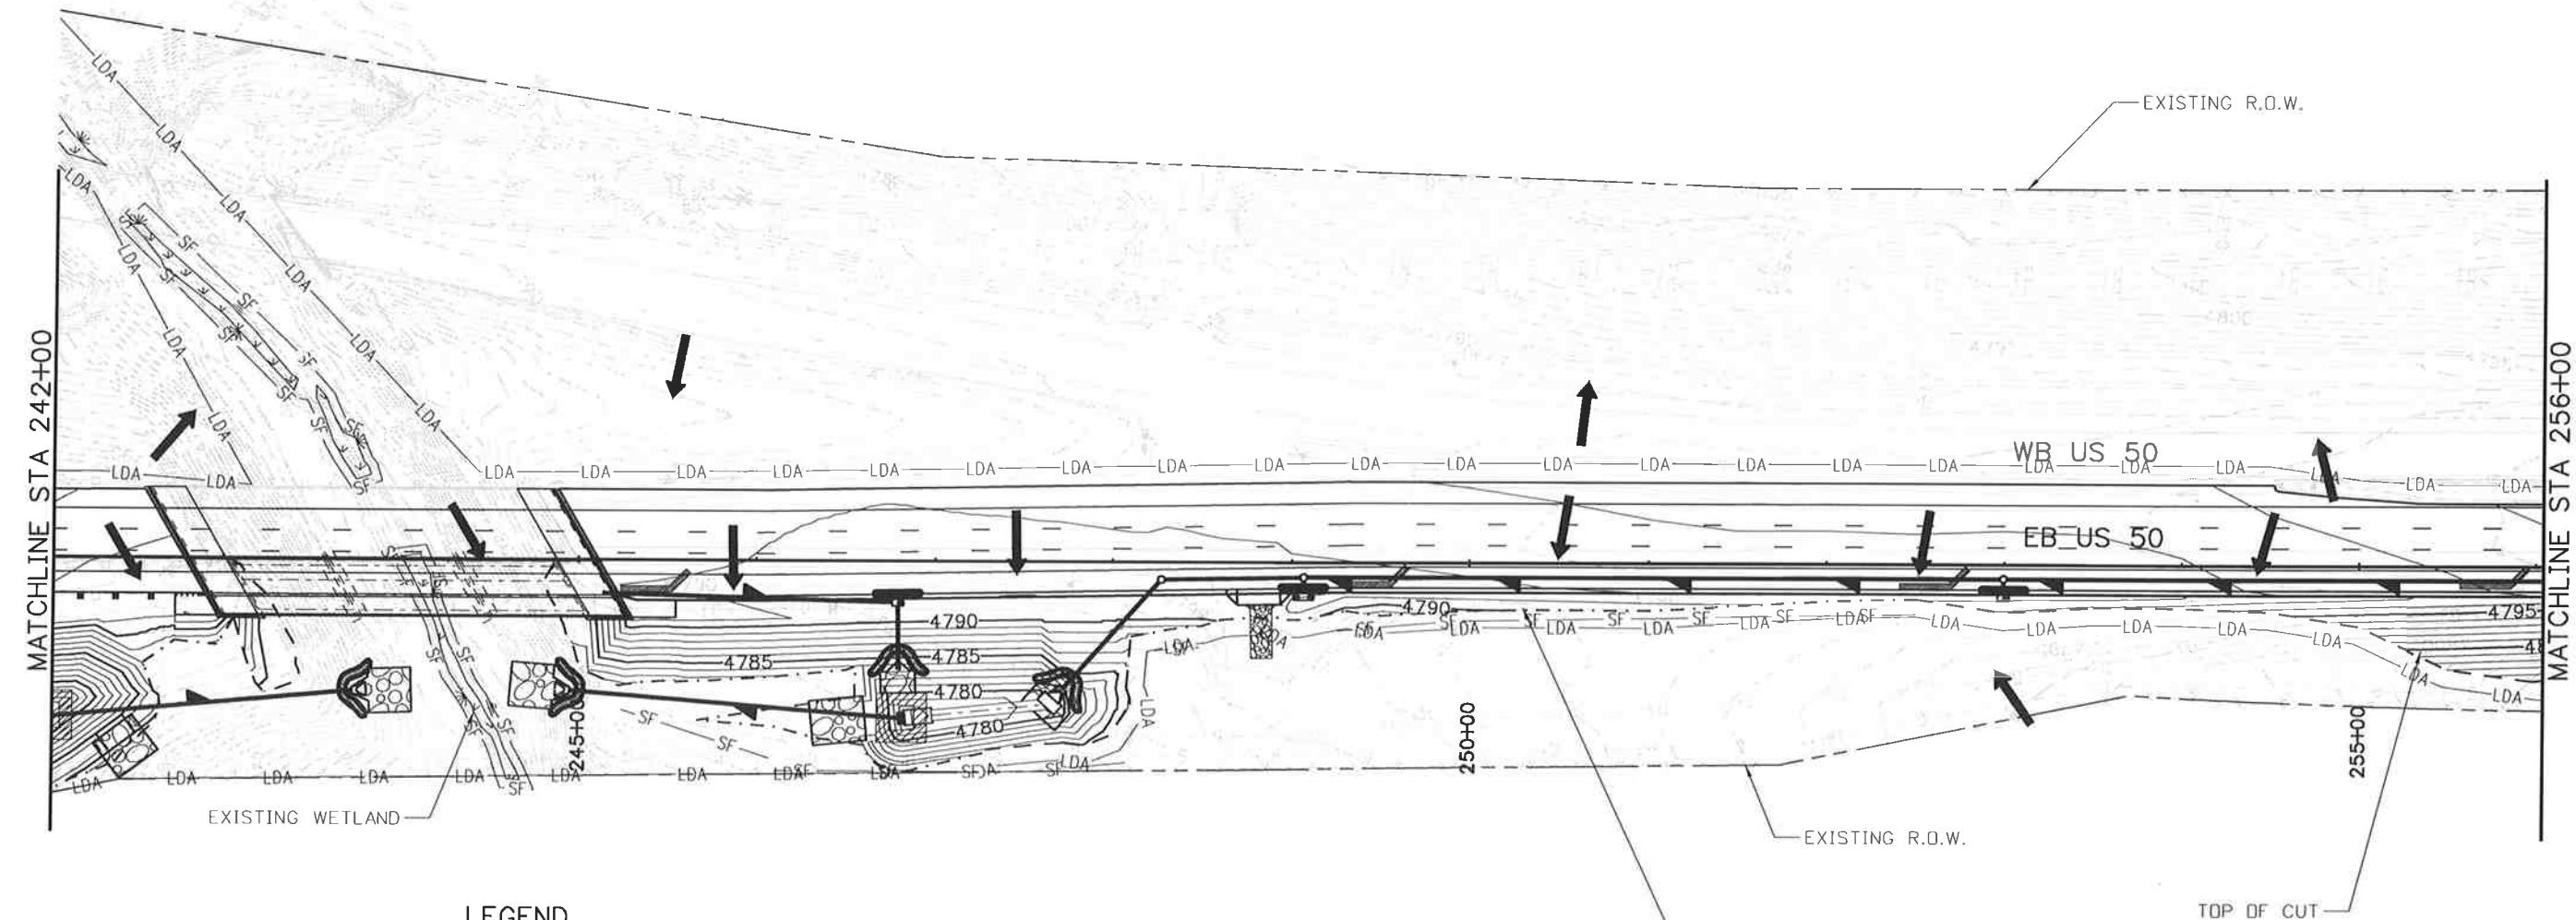
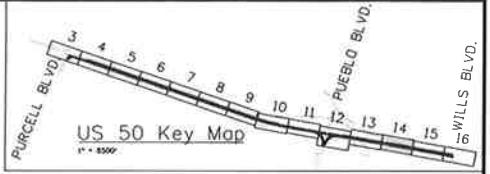
Print Date: 10/28/2014	 Region 2	Sheet Revisions			<p>Colorado Department of Transportation</p> <p>902 Erie Avenue Pueblo, CO 81001 Phone: 719-562-5509 FAX: 719-546-5702</p> <p>Region 2</p> <p>DTD</p>	As Constructed		US 50 WEST		<p>Project No./Code</p> <p>FSA 0503-081</p> <p>19751</p> <p>Sheet Number 217</p>
Date:		Comments	Init.	No Revisions:				PURCELL BLVD. TO WILLS BLVD.		
				Revised:		Designer:	AB	Structure		
				Detailer:		AB	Numbers			
				Void:		Subset:	EC	Subset Sheets: EC13 of 16		



**Know what's below.
Call before you dig.**

0' 50' 100' 200'

N



LEGEND

	EROSION LOG DITCH CHECK
	VEHICLE TRACKING PADS
	CONCRETE WASHOUT STRUCTURE
	SILT FENCE
	LIMITS OF DISTURBANCE
	DIRECTION OF SURFACE FLOW
	AGGREGATE BAG CURB CHECK
	DROP INLET PROTECTION
	STORM DRAIN INLET PROTECTION
	PIPE EROSION LOG
	PIPE EROSION LOG-INLET
	WETLAND
	RIPRAP

- NOTES:
1. ECS TO UPDATE SITE MAPS DURING CONSTRUCTION.
 2. ALL DISTURBED AREAS NOT TO BE PAVED SHALL HAVE AN APPLICATION OF SEED(NATIVE), MULCH(WEEED), AND MULCH TACKIFIER.
 3. THE EROSION LOG DITCH CHECK SYMBOL IS NOT SHOWN TO SCALE. THE ACTUAL LENGTH IS DEFINED AS THE DISTANCE FROM PROPOSED EDGE OF ROAD TO PROPOSED TOE OF SLOPE.

Print Date: 10/28/2014

File Name: 19056DES_SWMP_14_Plan.dgn

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No Revisions:

Revised:

Void:

US 50 WEST
PURCELL BLVD. TO WILLS BLVD.
EROSION CONTROL PLAN-INITIAL

Project No./Code

FSA 0503-081

19751

Sheet Number

218

DTD

EC

Subset:


EC

Subset Sheets:

EC14 of 16



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LEGEND

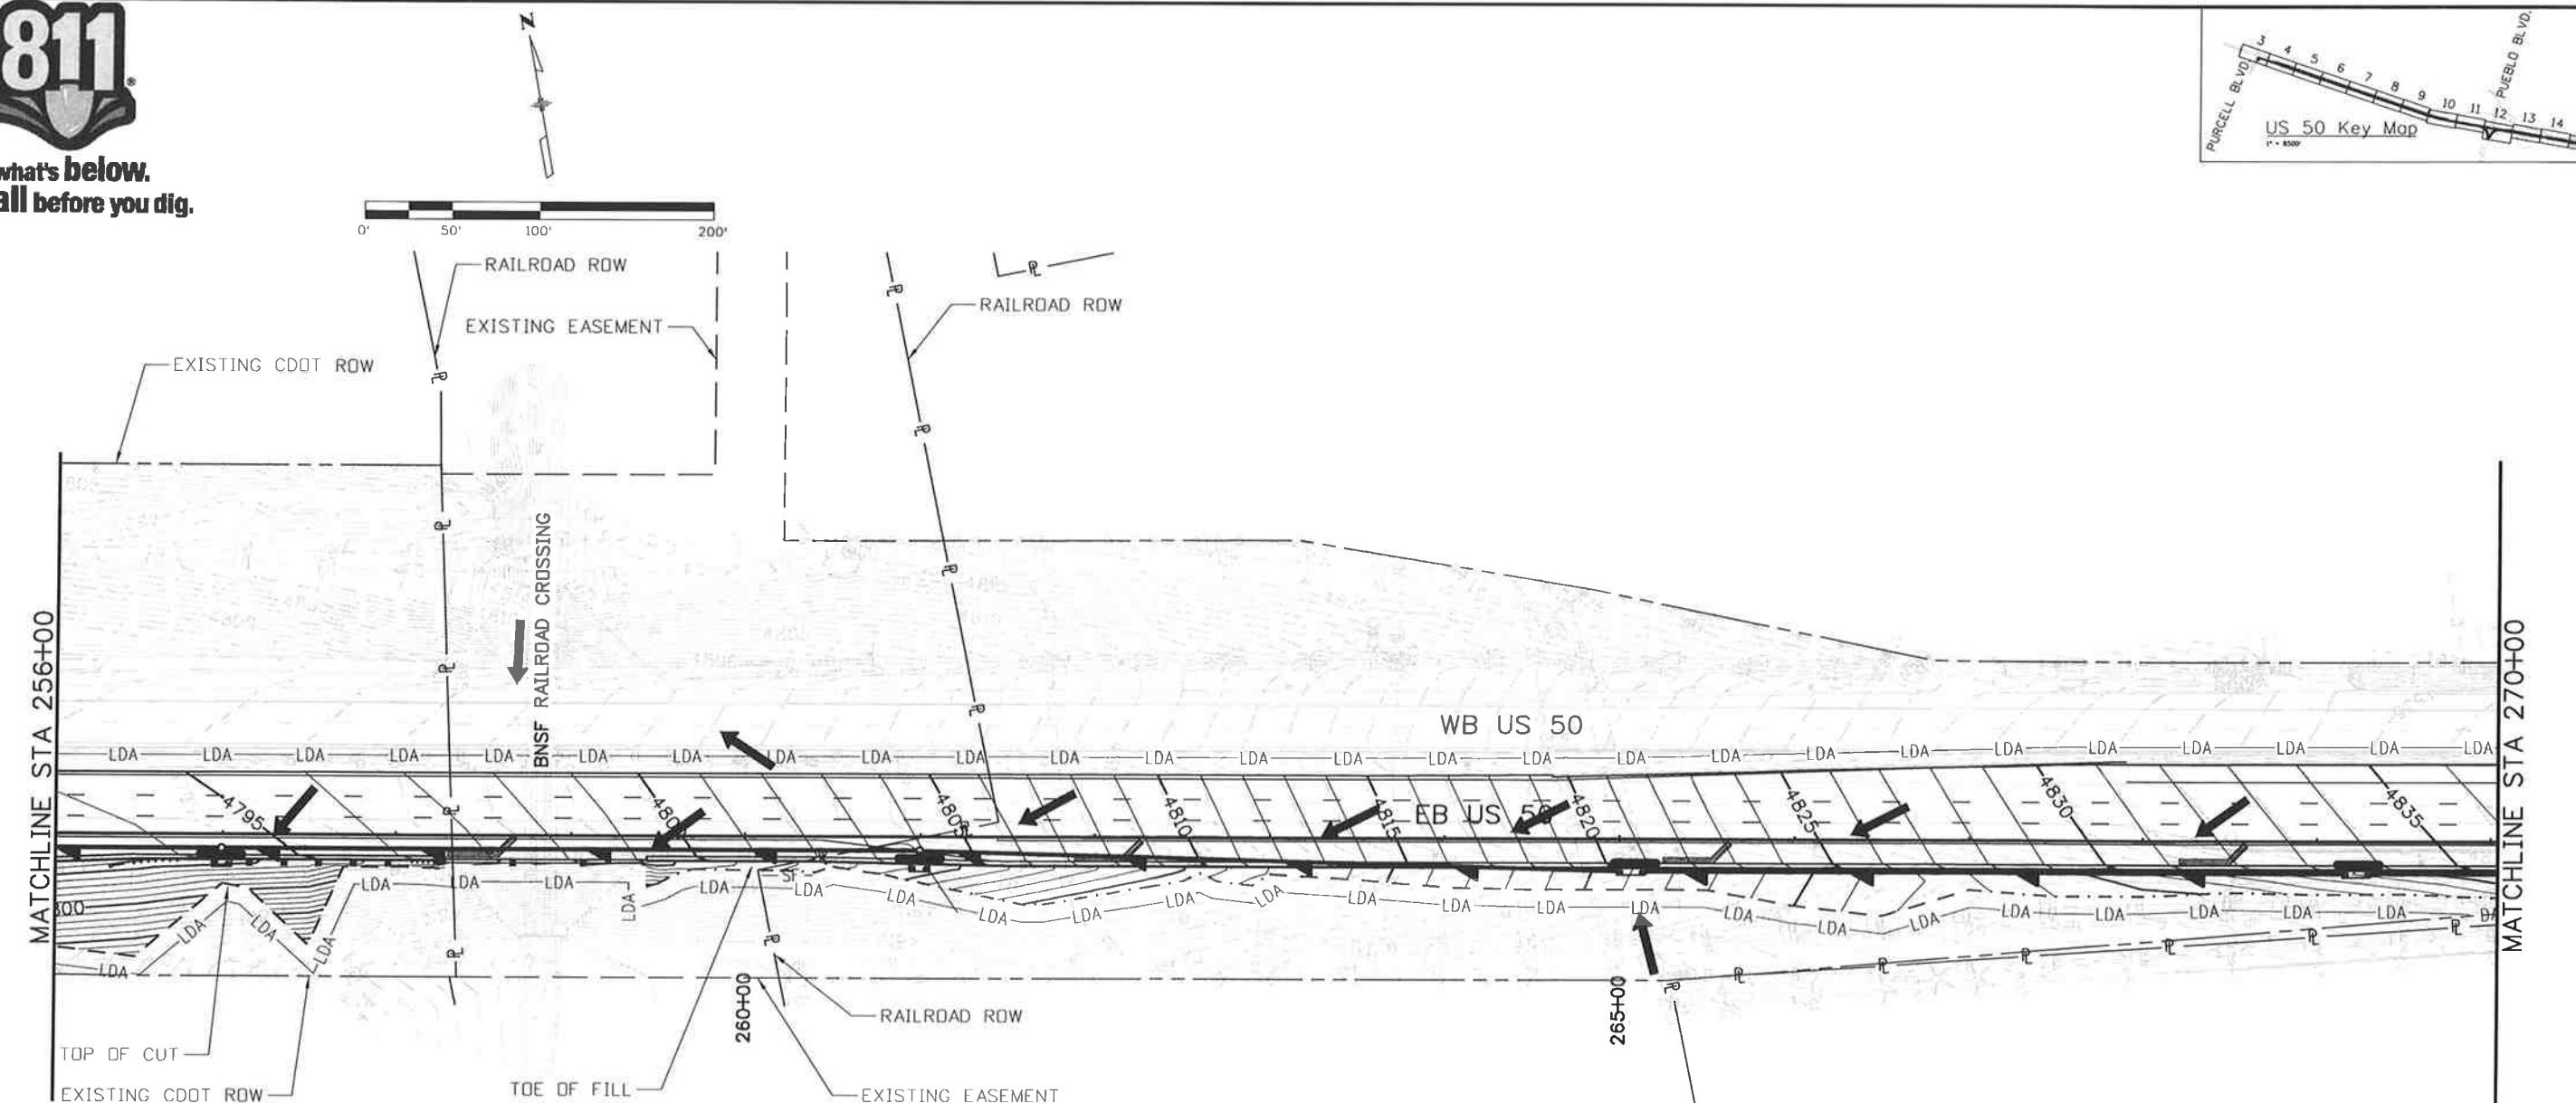	EROSION LOG DITCH CHECK		AGGREGATE BAG CURB CHECK
	VEHICLE TRACKING PADS		DROP INLET PROTECTION
	CONCRETE WASHOUT STRUCTURE		STORM DRAIN INLET PROTECTION
	SILT FENCE		PIPE EROSION LOG
	LIMITS OF DISTURBANCE		PIPE EROSION LOG-INLET
	DIRECTION OF SURFACE FLOW		WETLAND
			RIPRAP

- NOTES:
1. ECS TO UPDATE SITE MAPS DURING CONSTRUCTION.
 2. ALL DISTURBED AREAS NOT TO BE PAVED SHALL HAVE AN APPLICATION OF SEED(NATIVE), MULCH(WEEED), AND MULCH TACKIFIER.
 3. THE EROSION LOG DITCH CHECK SYMBOL IS NOT SHOWN TO SCALE. THE ACTUAL LENGTH IS DEFINED AS THE DISTANCE FROM PROPOSED EDGE OF ROAD TO PROPOSED TOE OF SLOPE.

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Void:

US 50 WEST
PURCELL BLVD. TO WILLS BLVD.
EROSION CONTROL PLAN-INITIAL

Project No./Code

FSA 0503-081

19751




Sheet Number 219

DTD

Designer: AB
Detailer: AB
Subset: EC
Structure Numbers
Subsel Sheets: EC15 of 16



**Know what's below.
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LEGEND

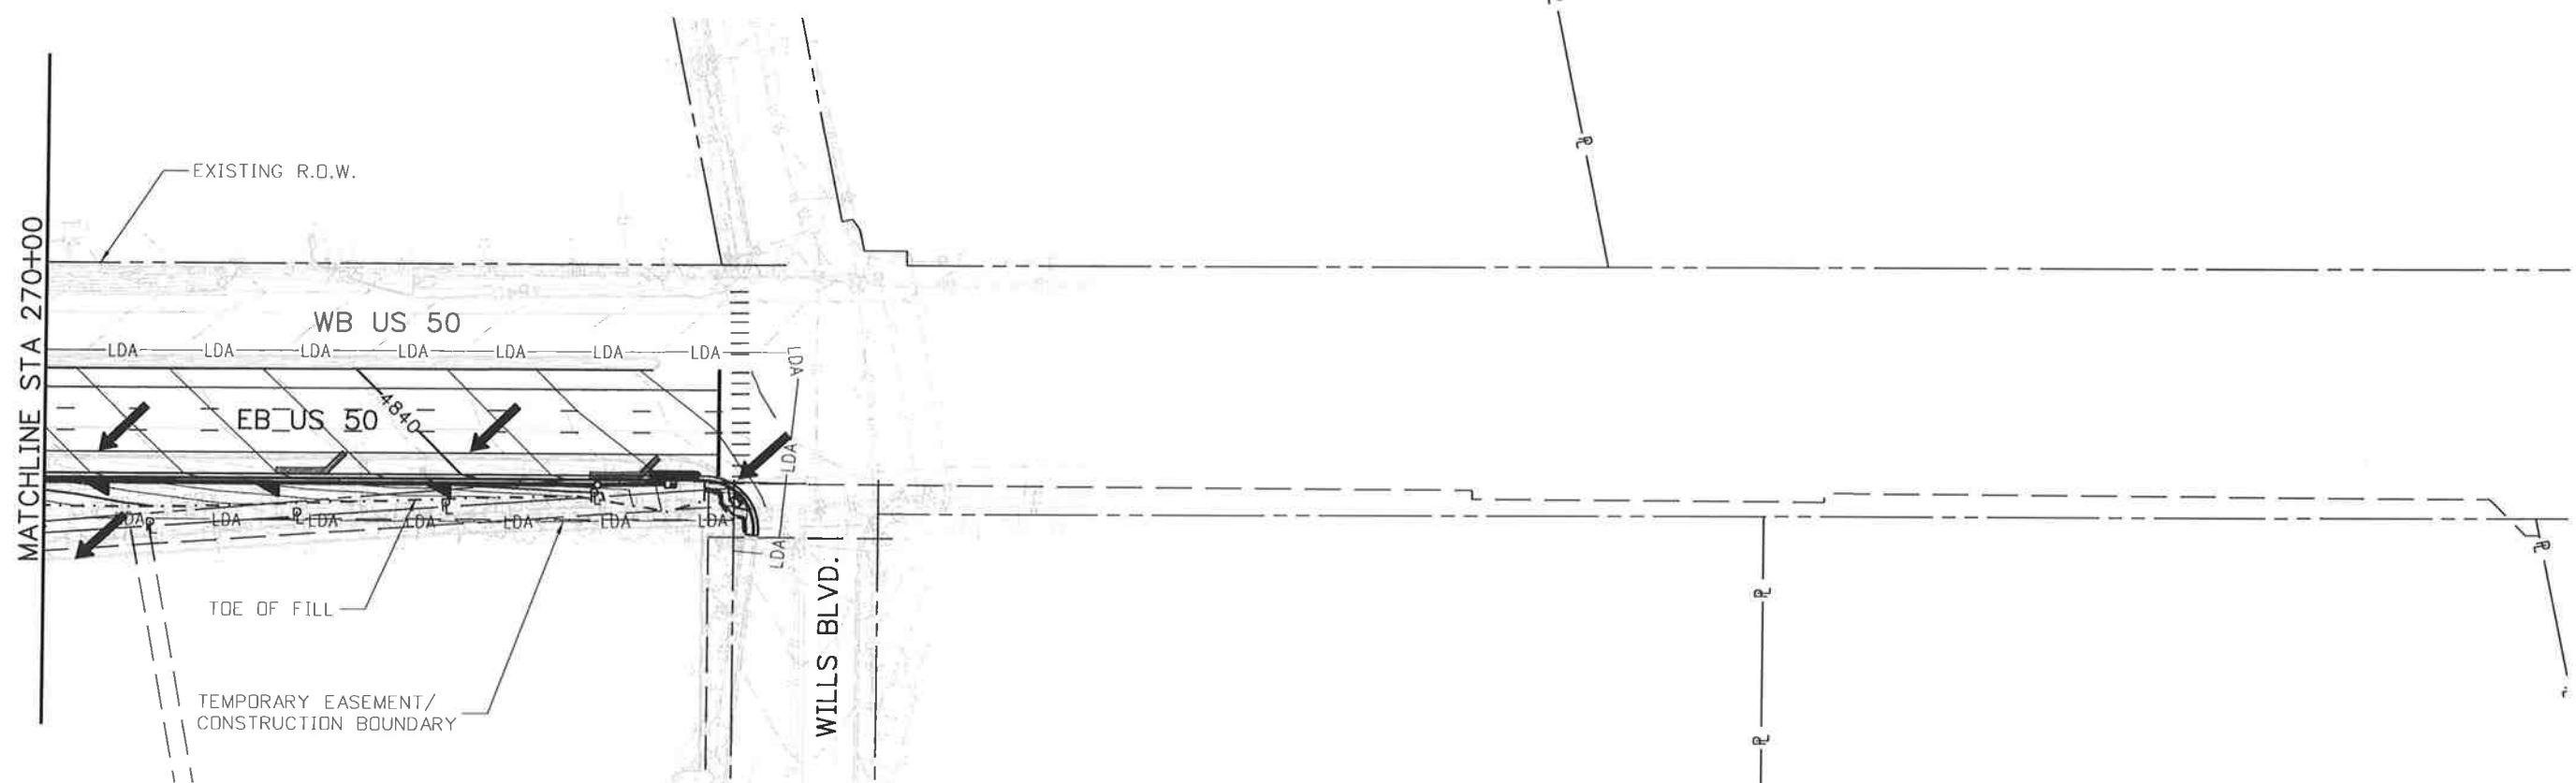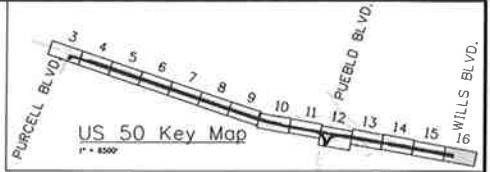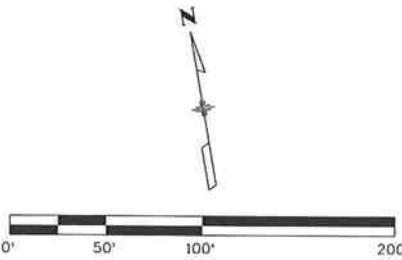	EROSION LOG DITCH CHECK
	VEHICLE TRACKING PADS
	CONCRETE WASHOUT STRUCTURE
	SILT FENCE
	LIMITS OF DISTURBANCE
	DIRECTION OF SURFACE FLOW
	AGGREGATE BAG CURB CHECK
	DROP INLET PROTECTION
	STORM DRAIN INLET PROTECTION
	PIPE EROSION LOG
	PIPE EROSION LOG-INLET
	WETLAND
	RIPRAP

- NOTES:
1. ECS TO UPDATE SITE MAPS DURING CONSTRUCTION.
 2. ALL DISTURBED AREAS NOT TO BE PAVED SHALL HAVE AN APPLICATION OF SEED(NATIVE), MULCH(WEEED), AND MULCH TACKIFIER.
 3. THE EROSION LOG DITCH CHECK SYMBOL IS NOT SHOWN TO SCALE. THE ACTUAL LENGTH IS DEFINED AS THE DISTANCE FROM PROPOSED EDGE OF ROAD TO PROPOSED TOE OF SLOPE.

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US 50 WEST PURCELL BLVD. TO WILLS BLVD. EROSION CONTROL PLAN-INITIAL

Designer: AB Structure Numbers

Detailer: AB

Subset: EC Subset Sheets: EC16 of 16

Project No./Code

FSA 0503-081


19751

Sheet Number 220



**Know what's below.
Call before you dig.**

0' 50' 100' 200'

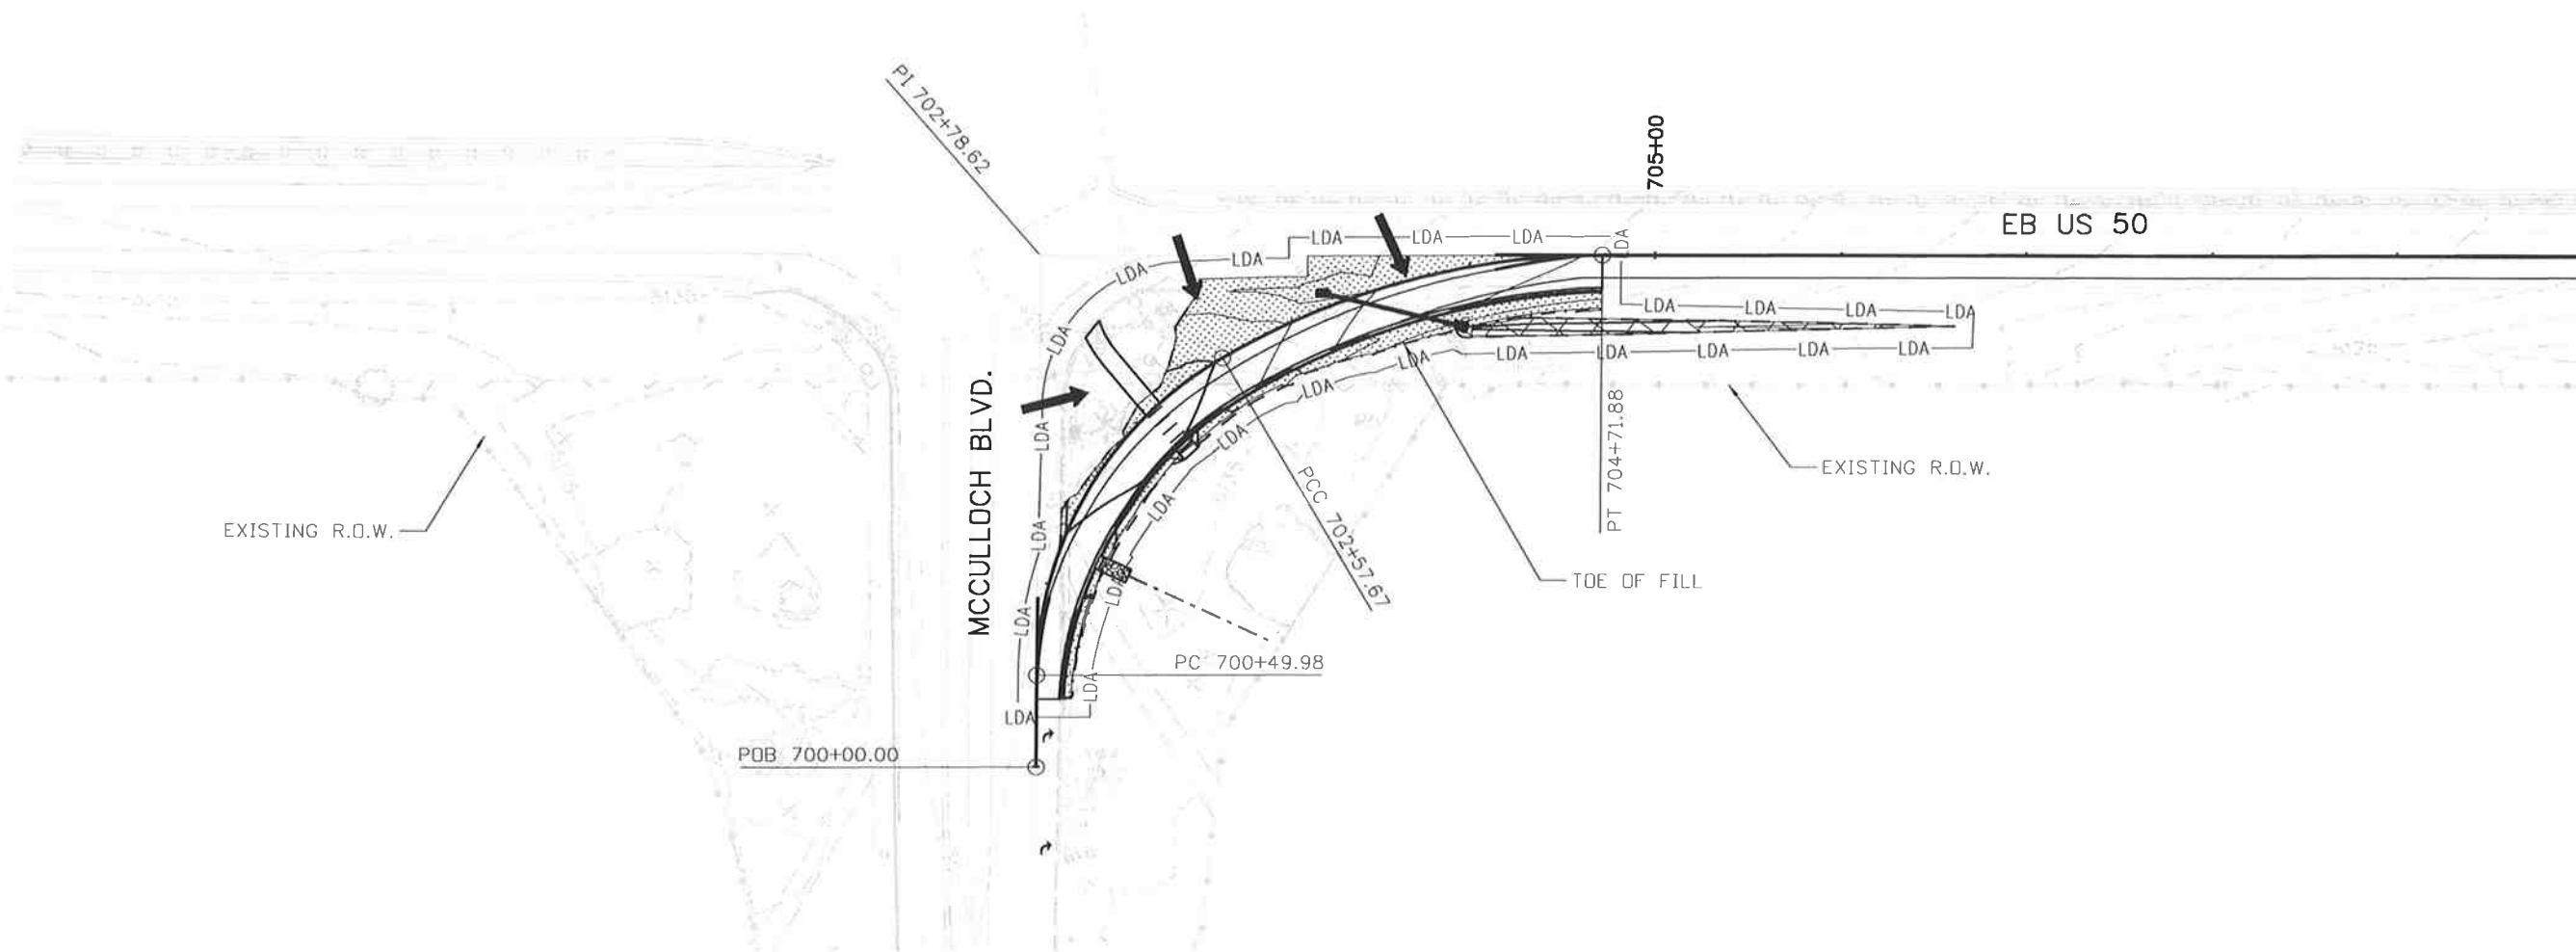

LEGEND

-LDA	LIMITS OF DISTURBANCE	AGGREGATE BAG CURB CHECK
→	DIRECTION OF SURFACE FLOW	DROP INLET PROTECTION
□	SOIL RETENTION BLANKETS	STORM DRAIN INLET PROTECTION
■	SEEDING	PIPE EROSION LOG
□	EXISTING WETLAND	PIPE EROSION LOG-INLET

NOTES:
1. ECS TO UPDATE SITE MAPS DURING CONSTRUCTION.
2. INTERMEDIATE BMP'S TO BE REMOVED ARE SHOWN AS SCREENED ON "FINAL EROSION CONTROL PLANS"

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Void:

US 50 WEST MCCULLOCH BLVD. EROSION CONTROL PLAN- FINAL

Project No./Code



FSA 0503-081

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Sheet Number 221



**Know what's below.
Call before you dig.**

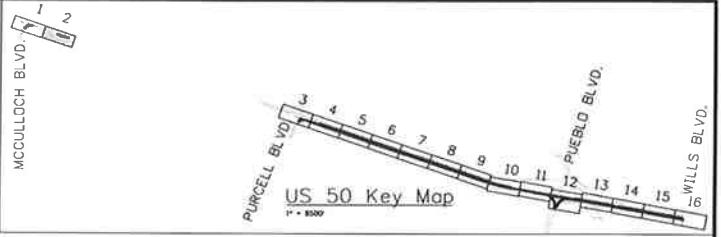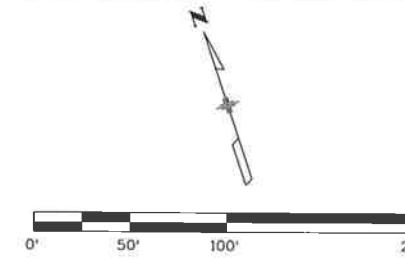

MATCHLINE STA 710+00

715+00

EB US 50

720+00

PDE 722+68.60

EXISTING R.O.W.

LEGEND

-LDA—	LIMITS OF DISTURBANCE		AGGREGATE BAG CURB CHECK
→	DIRECTION OF SURFACE FLOW		DROP INLET PROTECTION
	SOIL RETENTION BLANKETS		STORM DRAIN INLET PROTECTION
	SEEDING		PIPE EROSION LOG
	EXISTING WETLAND		PIPE EROSION LOG-INLET

NOTES:

1. ECS TO UPDATE SITE MAPS DURING CONSTRUCTION.
2. INTERMEDIATE BMP'S TO BE REMOVED ARE SHOWN AS SCREENED ON "FINAL EROSION CONTROL PLANS"

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File Name: 19056DES_SWMP_02_Plan.dgn

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Project No./Code

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Sheet Number 222

Subset: EF Subset Sheets: ECO2 of 16

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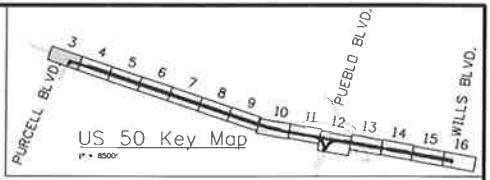


Know what's below.
Call before you dig.

0' 50' 100' 200'

EXISTING R.O.W.

EXISTING R.O.W.



WB US 50


EB US 50

EXISTING R.O.W.

LEGEND

- LDA— LIMITS OF DISTURBANCE
- DIRECTION OF SURFACE FLOW
- SOIL RETENTION BLANKETS
- SEEDING
- EXISTING WETLAND

- AGGREGATE BAG CURB CHECK
- DROP INLET PROTECTION
- STORM DRAIN INLET PROTECTION
- PIPE EROSION LOG
- PIPE EROSION LOG-INLET

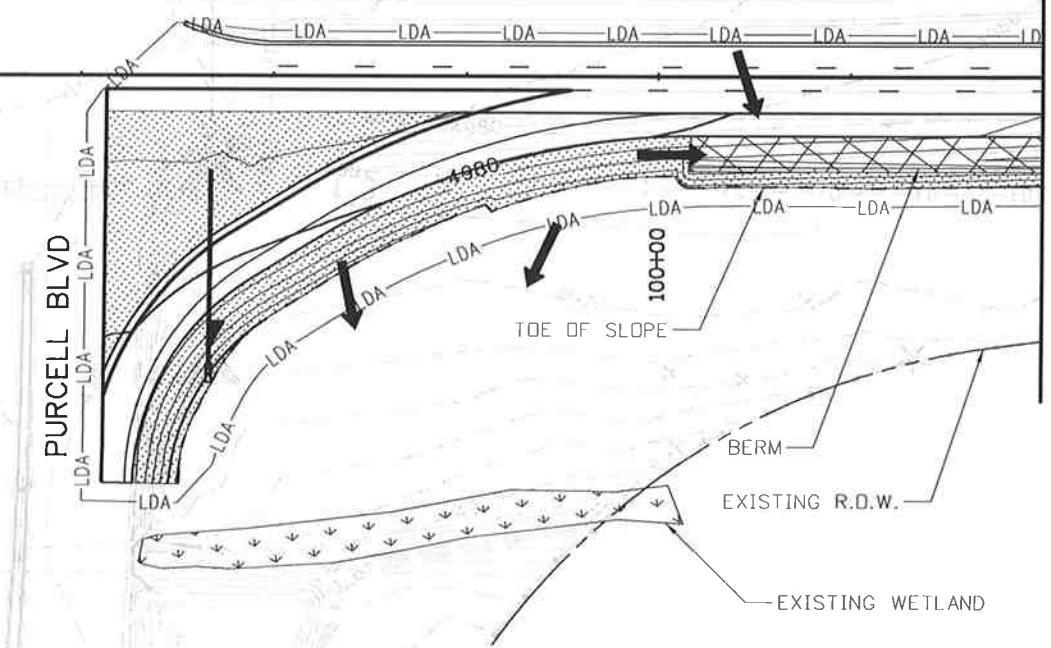

NOTES:
1. ECS TO UPDATE SITE MAPS DURING CONSTRUCTION.
2. INTERMEDIATE BMP'S TO BE REMOVED ARE SHOWN AS SCREENED ON "FINAL EROSION CONTROL PLANS"

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File Name: 19056DES_SWMP_03_Plan.dgn

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Project No./Code

FSA 0503-081



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Sheet Number 223



**Know what's below.
Call before you dig.**

0' 50' 100' 200'

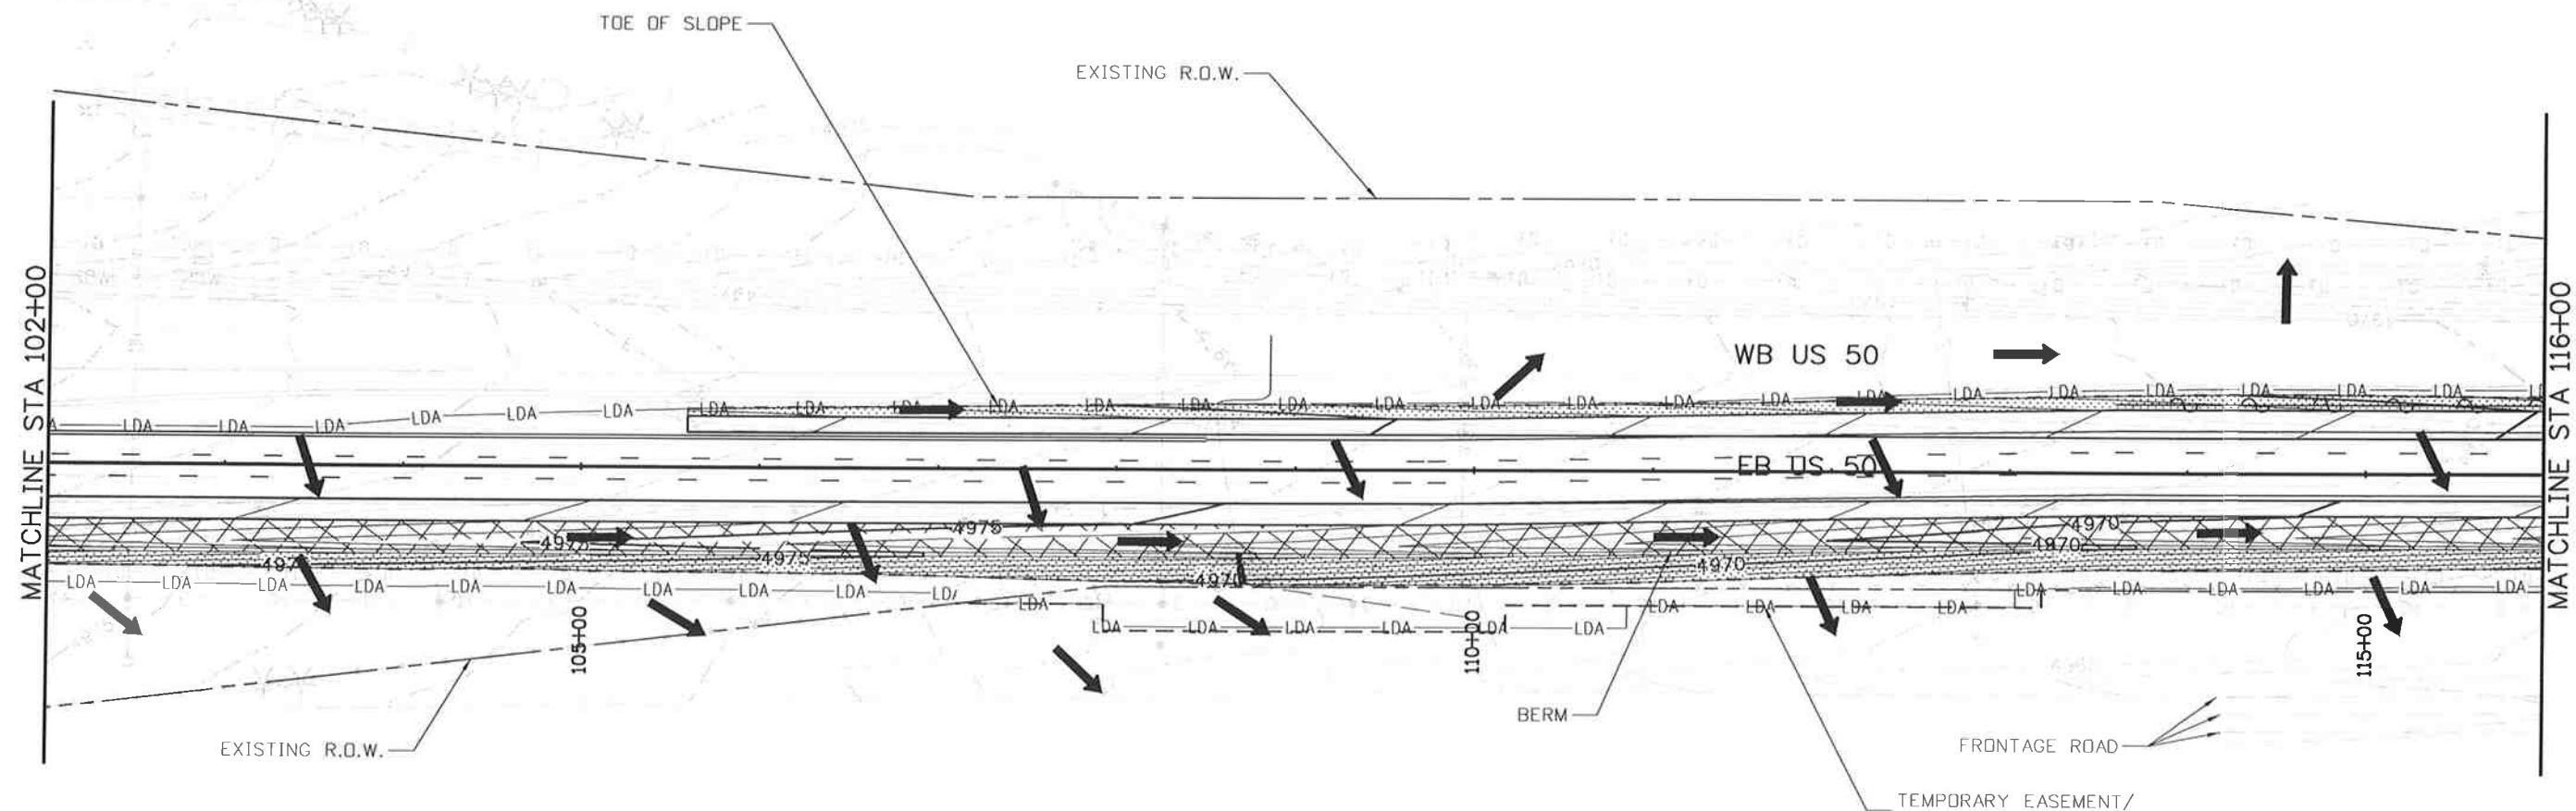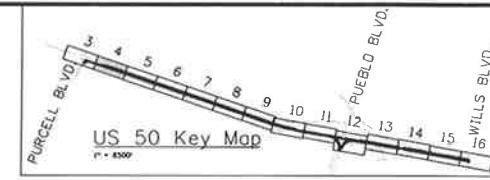

LEGEND

- | | | |
|------|---------------------------|------------------------------|
| -LDA | LIMITS OF DISTURBANCE | AGGREGATE BAG CURB CHECK |
| → | DIRECTION OF SURFACE FLOW | DROP INLET PROTECTION |
| □ | SOIL RETENTION BLANKETS | STORM DRAIN INLET PROTECTION |
| ■ | SEEDING | PIPE EROSION LOG |
| □ | EXISTING WETLAND | PIPE EROSION LOG-INLET |

- NOTES:
1. ECS TO UPDATE SITE MAPS DURING CONSTRUCTION.
 2. INTERMEDIATE BMP'S TO BE REMOVED ARE SHOWN AS SCREENED ON "FINAL EROSION CONTROL PLANS"

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File Name: I9056DES_SWMP_04_Plan.dgn

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Void:

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PURCELL BLVD. TO WILLS BLVD.
EROSION CONTROL PLAN-FINAL

Project No./Code

FSA 0503-081

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Sheet Number 224



Designer:	AB	Structure Numbers
Detailer:	AB	
Subset:	EF	Subsel Sheets: EF04 of 16



**Know what's below.
Call before you dig.**



0' 50' 100' 200'

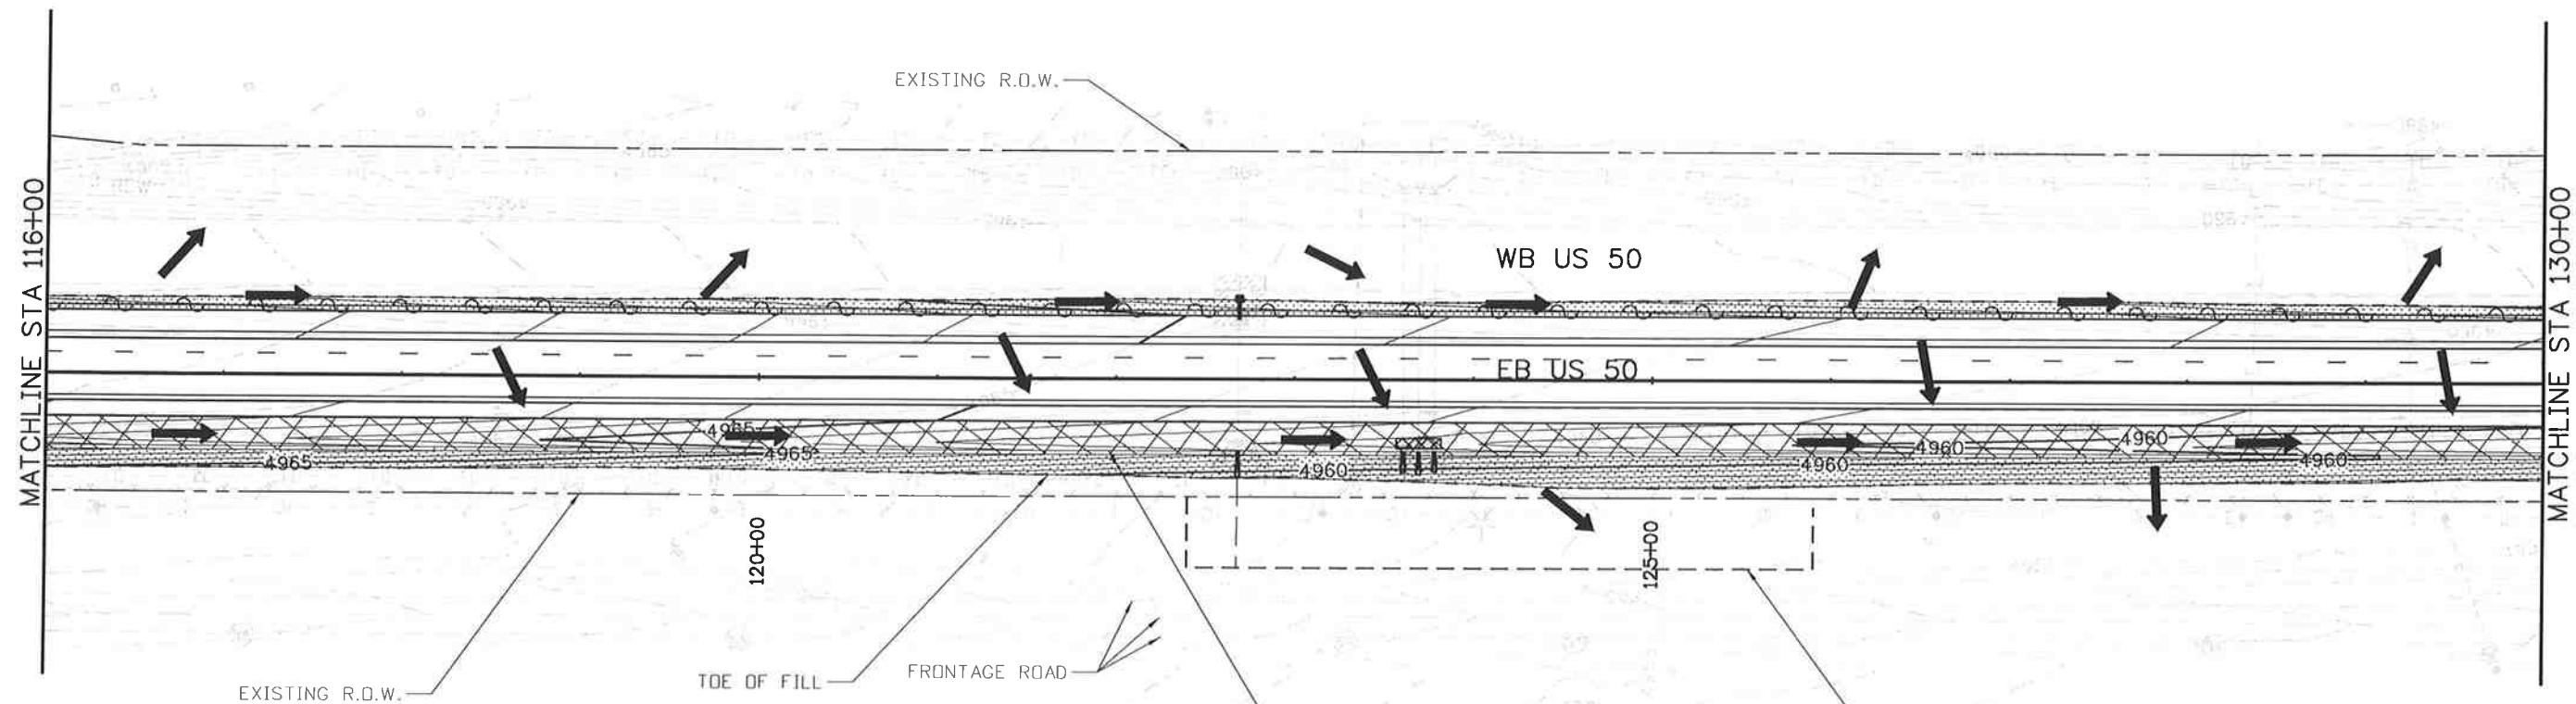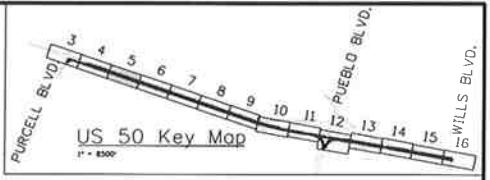

LEGEND

-LDA	LIMITS OF DISTURBANCE
→	DIRECTION OF SURFACE FLOW
□	SOIL RETENTION BLANKETS
■	SEEDING
□	EXISTING WETLAND
○	AGGREGATE BAG CURB CHECK
○	DROP INLET PROTECTION
○	STORM DRAIN INLET PROTECTION
○	PIPE EROSION LOG
○	PIPE EROSION LOG-INLET

NOTES:
 1. ECS TO UPDATE SITE MAPS DURING CONSTRUCTION.
 2. INTERMEDIATE BMP'S TO BE REMOVED ARE SHOWN AS SCREENED ON "FINAL EROSION CONTROL PLANS"

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File Name: 19056DES_SWMP_05_Plan.dgn

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Project No./Code

FSA 0503-081




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Sheet Number 225

Designer:	AB	Structure Numbers
Detailer:	AB	
Subset:	EF	Subset Sheets: EF05 of 16



**Know what's below.
Call before you dig.**

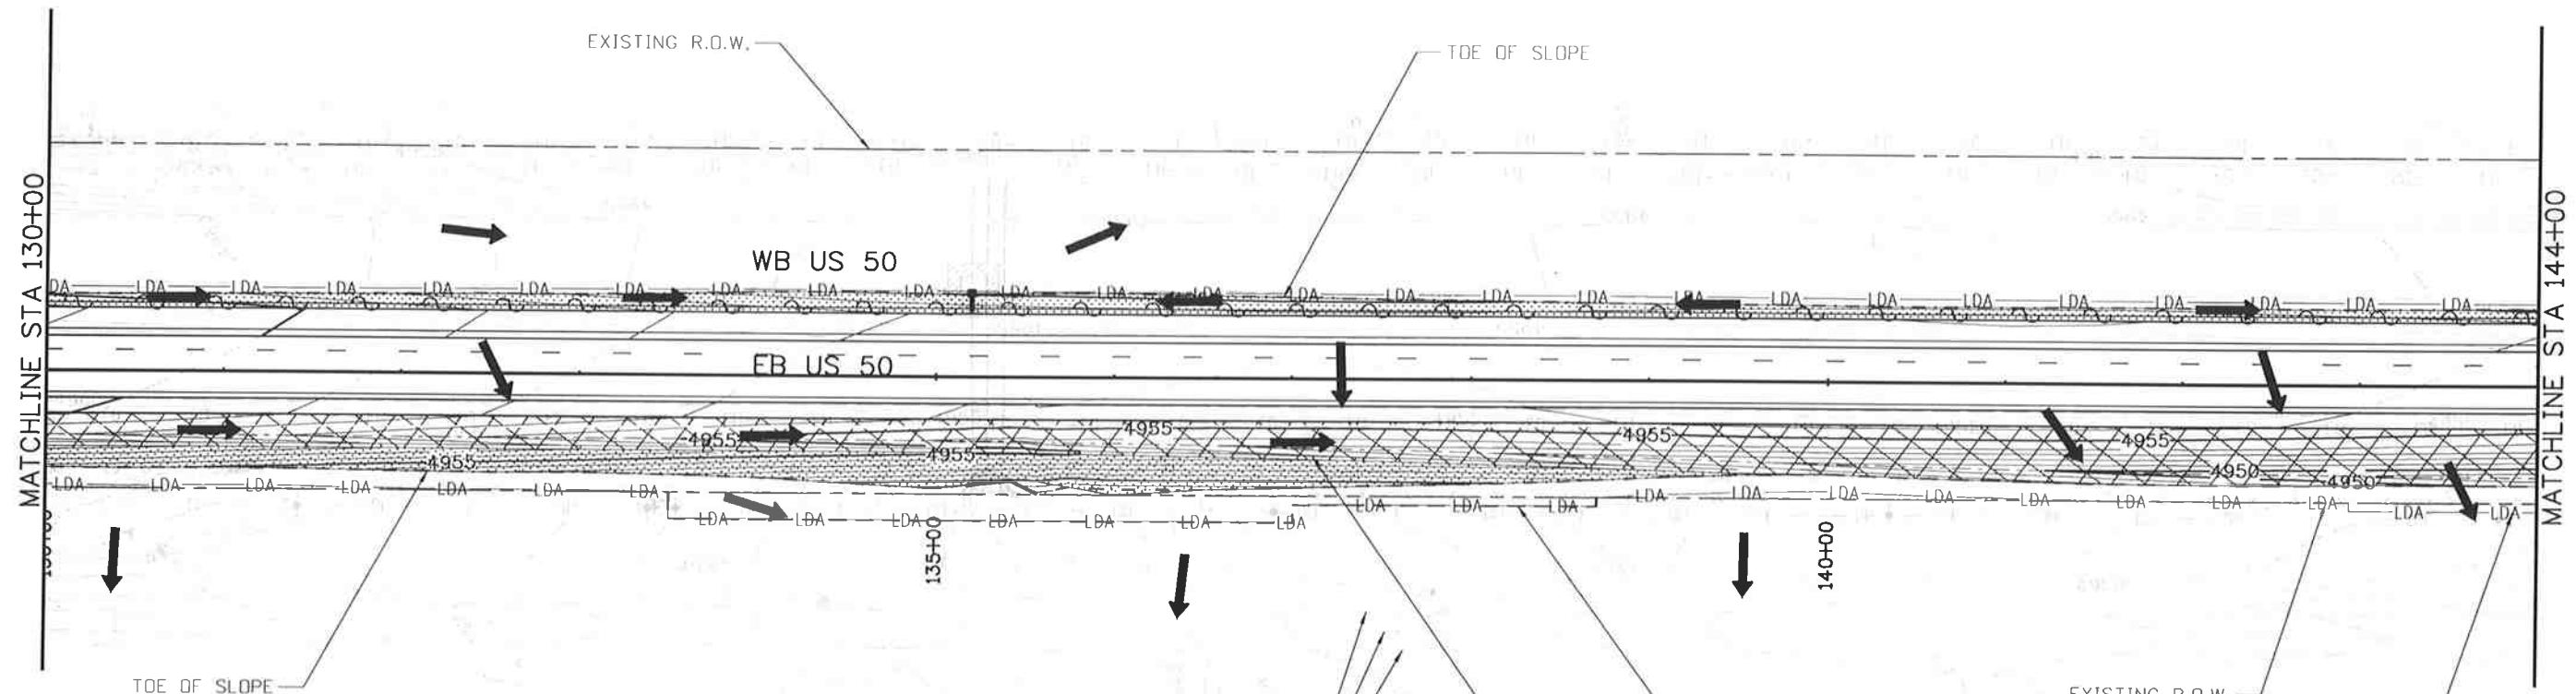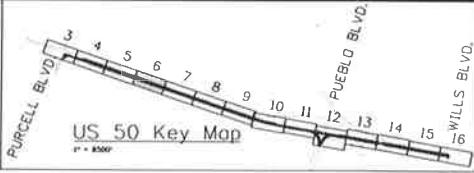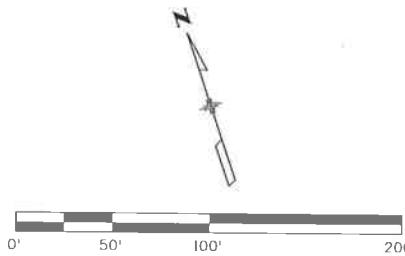

LEGEND

-LDA—	LIMITS OF DISTURBANCE
→	DIRECTION OF SURFACE FLOW
▨	SOIL RETENTION BLANKETS
▨▨	SEEDING
▨▨▨	EXISTING WETLAND
▨	AGGREGATE BAG CURB CHECK
▨	DROP INLET PROTECTION
▨	STORM DRAIN INLET PROTECTION
▨	PIPE EROSION LOG
▨	PIPE EROSION LOG-INLET

NOTES:
 1. ECS TO UPDATE SITE MAPS DURING CONSTRUCTION.
 2. INTERMEDIATE BMP'S TO BE REMOVED ARE SHOWN AS SCREENED ON "FINAL EROSION CONTROL PLANS"

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Designer: AB
 Detailer: AB
 Subset: EF

Structure Numbers
 Subset Sheets: EF06 of 16

Project No./Code




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Sheet Number 226



**Know what's below.
Call before you dig.**



LEGEND

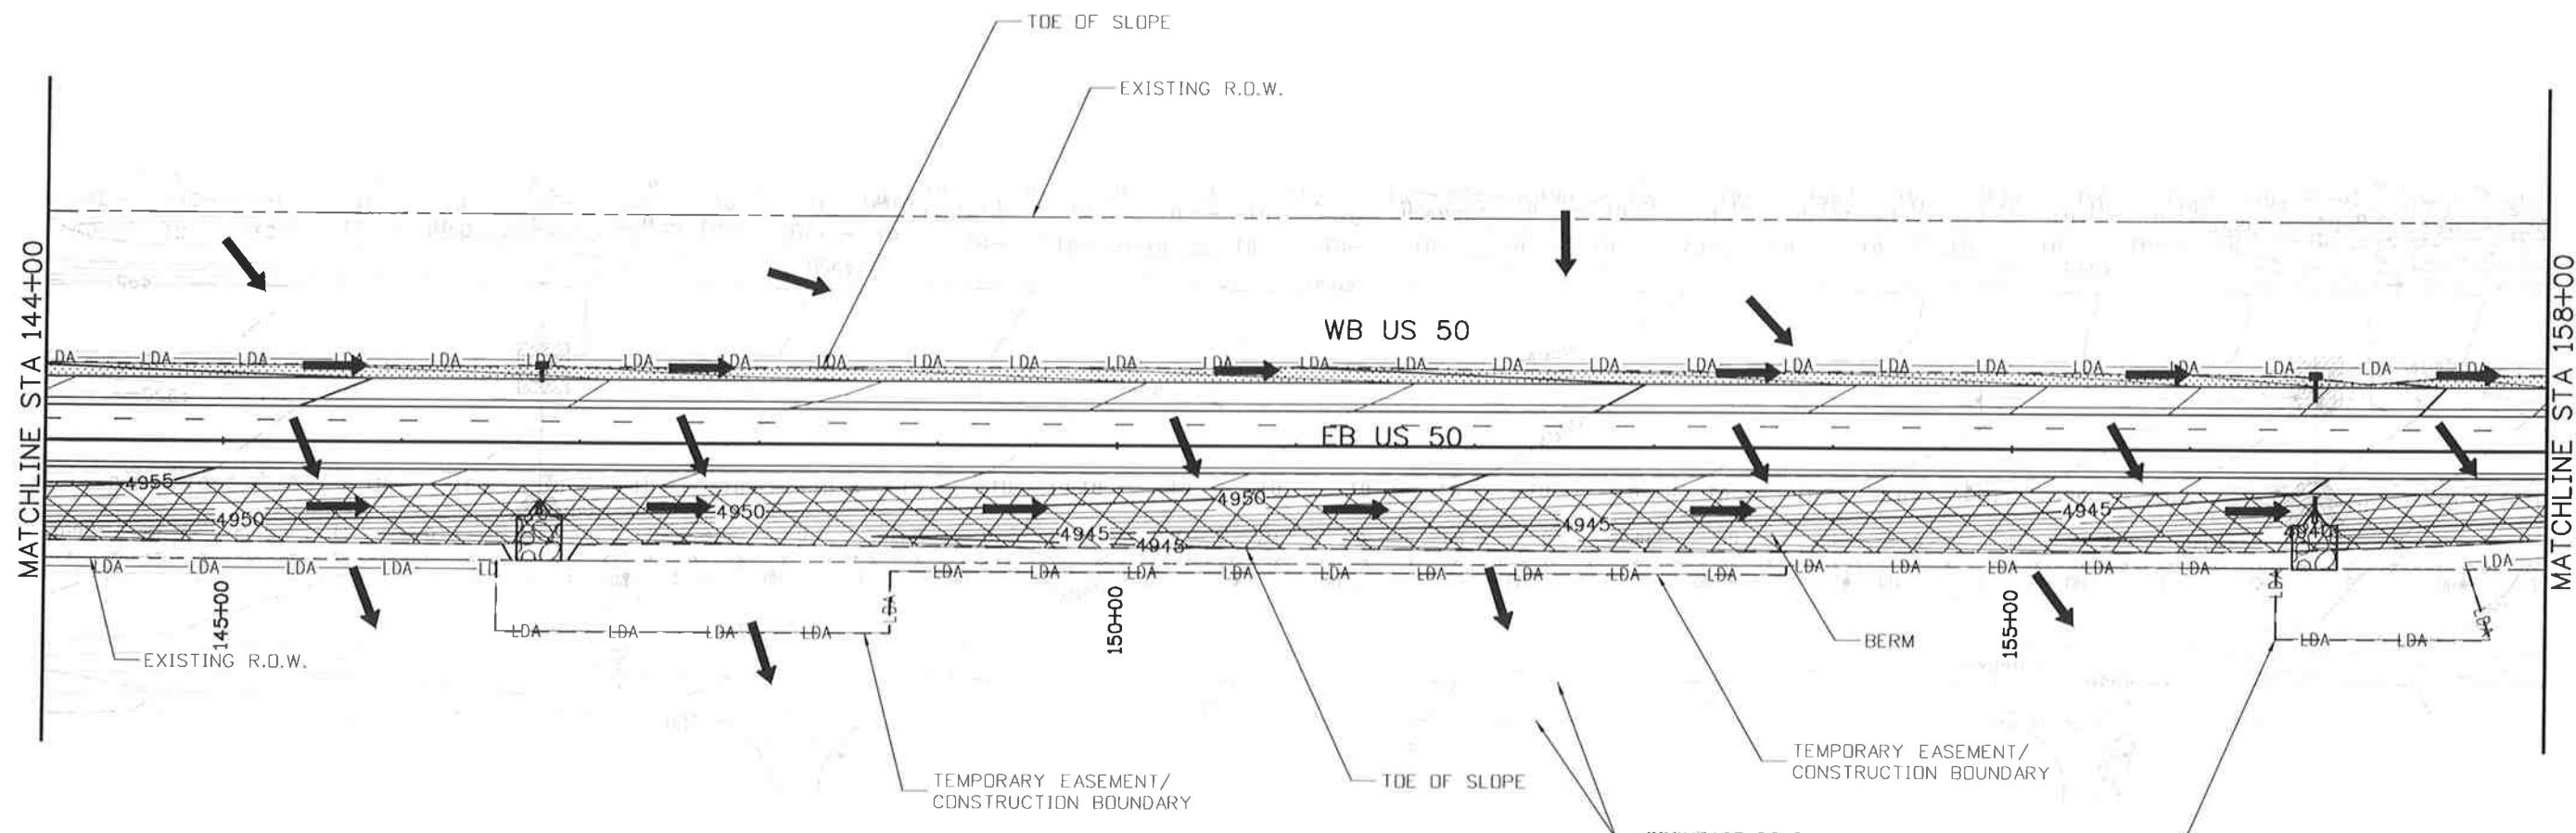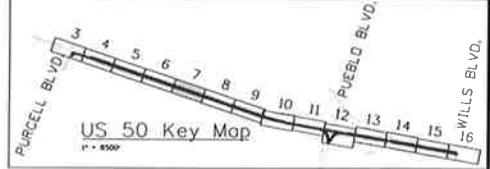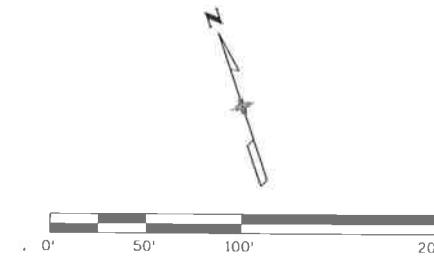- | | | |
|------|---------------------------|------------------------------|
| -LDA | LIMITS OF DISTURBANCE | AGGREGATE BAG CURB CHECK |
| → | DIRECTION OF SURFACE FLOW | DROP INLET PROTECTION |
| ▨ | SOIL RETENTION BLANKETS | STORM DRAIN INLET PROTECTION |
| ■ | SEEDING | PIPE EROSION LOG |
| ▨ | EXISTING WETLAND | PIPE EROSION LOG-INLET |

NOTES:
 1. ECS TO UPDATE SITE MAPS DURING CONSTRUCTION.
 2. INTERMEDIATE BMP'S TO BE REMOVED ARE SHOWN AS SCREENED ON "FINAL EROSION CONTROL PLANS"

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File Name: 19056DES_SWMP_07_Plan.dgn

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Project No./Code

FSA 0503-081




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Sheet Number 227

Designer: AB	Structure Numbers
Detailer: AB	Subset: EF
Subsel Sheets: EF07 of 16	



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Call before you dig.**

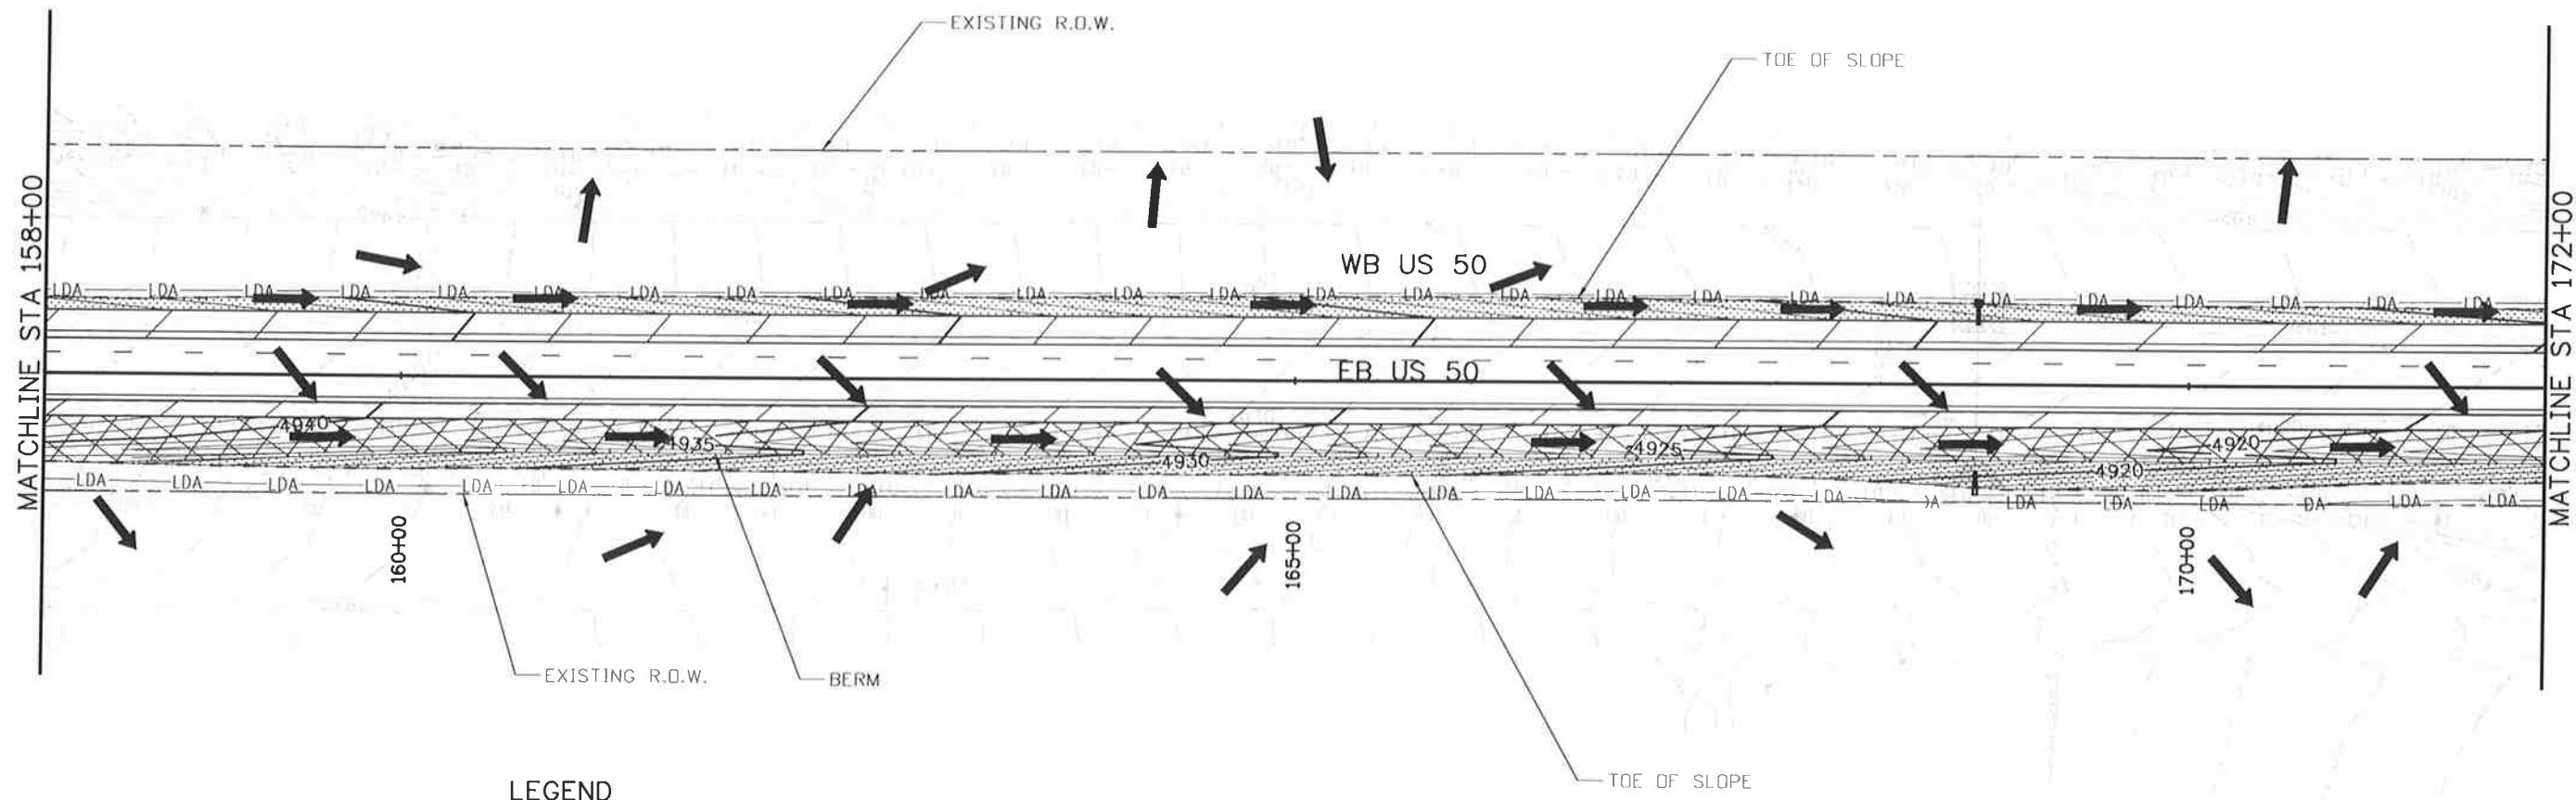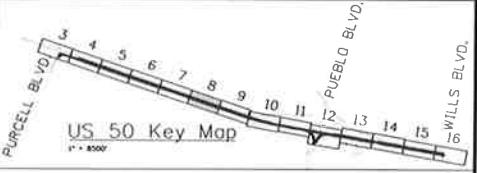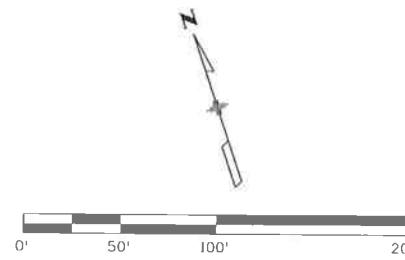

LEGEND

- | | | |
|------|---------------------------|------------------------------|
| -LDA | LIMITS OF DISTURBANCE | Aggregate Bag Curb Check |
| → | DIRECTION OF SURFACE FLOW | Drop Inlet Protection |
| ▨ | Soil Retention Blankets | Storm Drain Inlet Protection |
| ▨▨ | Seeding | Pipe Erosion Log |
| ▨▨▨ | Existing Wetland | Pipe Erosion Log-Inlet |

- NOTES:
1. ECS TO UPDATE SITE MAPS DURING CONSTRUCTION.
 2. INTERMEDIATE BMP'S TO BE REMOVED ARE SHOWN AS SCREENED ON "FINAL EROSION CONTROL PLANS"

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File Name: 19056DES_SWMP_08_Plan.dgn

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Revised:

Void:

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Project No./Code

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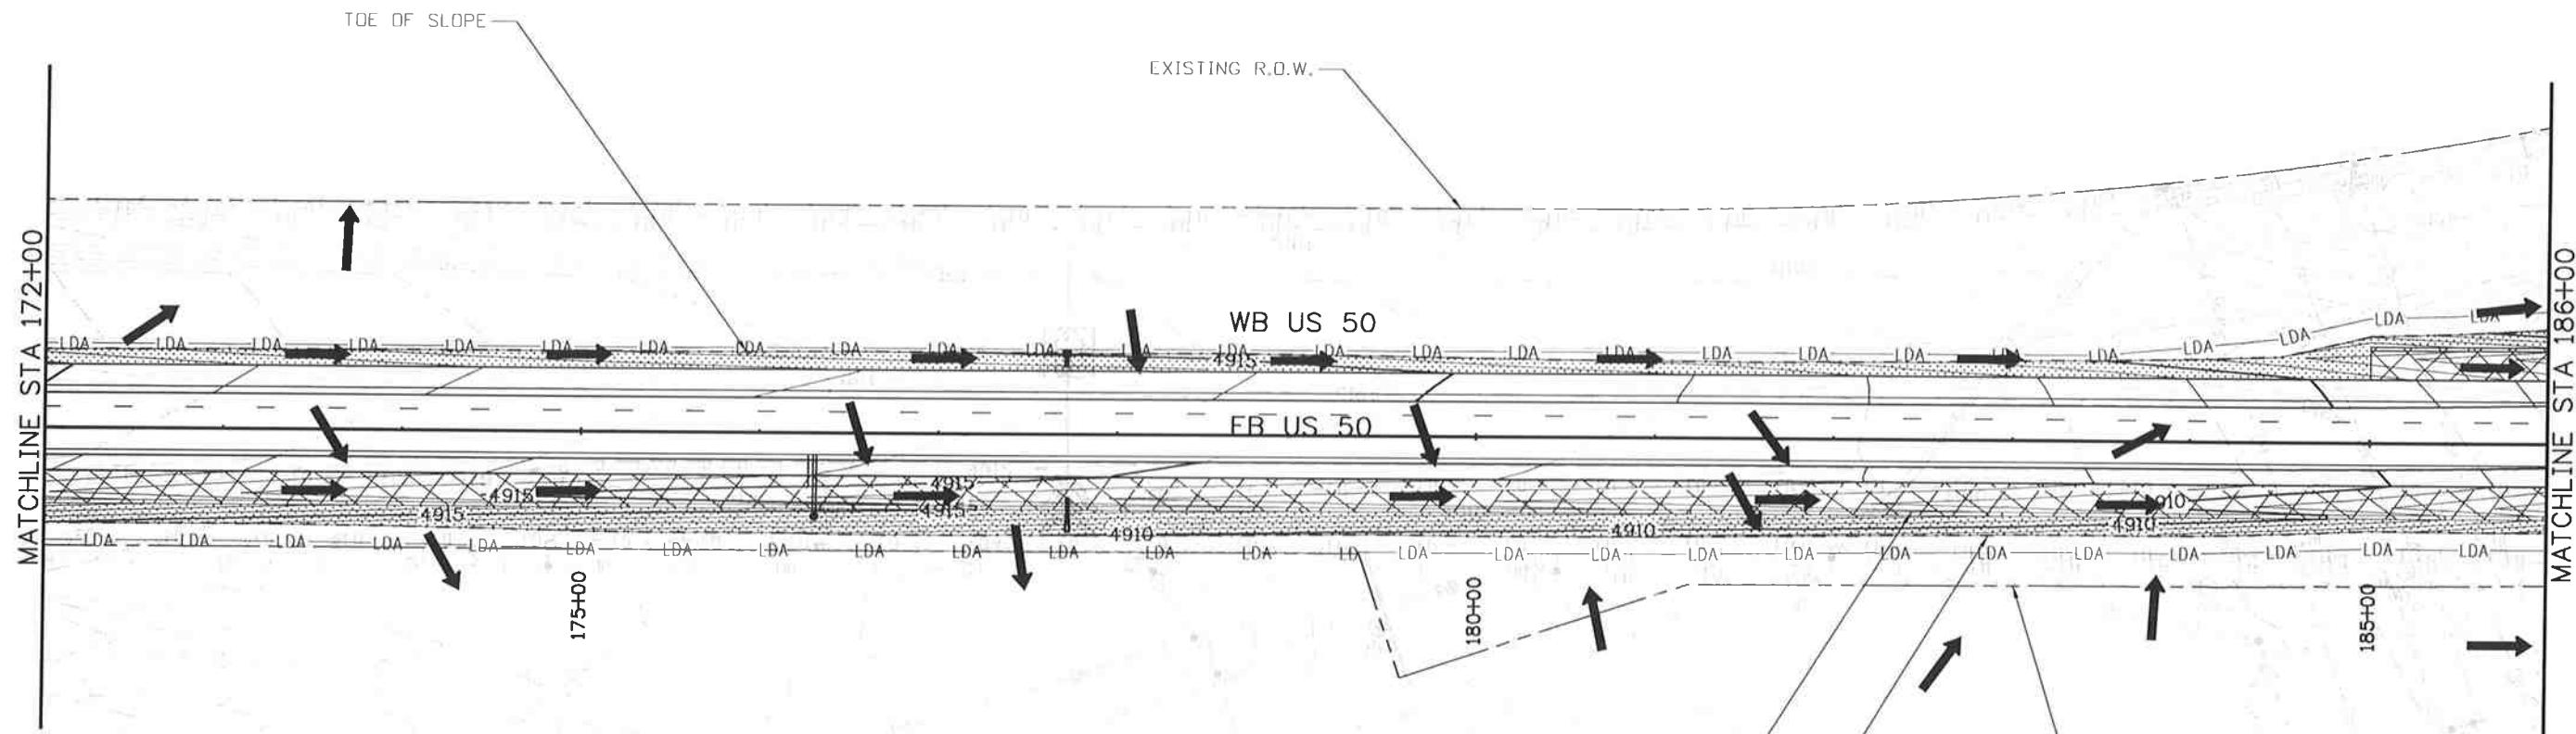
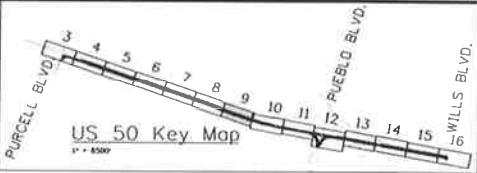
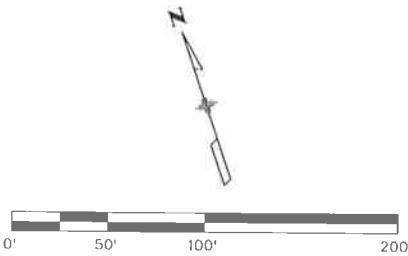
19751

Sheet Number 228

Designer: AB Structure Numbers
Detailer: AB
Subset: EF Subset Sheets: EF08 of 16



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Call before you dig.**



LEGEND

-LDA-	LIMITS OF DISTURBANCE	AGGREGATE BAG CURB CHECK
→	DIRECTION OF SURFACE FLOW	DROP INLET PROTECTION
▨	SOIL RETENTION BLANKETS	STORM DRAIN INLET PROTECTION
▨	SEEDING	PIPE EROSION LOG
▨	EXISTING WETLAND	PIPE EROSION LOG-INLET

TOE OF SLOPE

NOTES:
1. ECS TO UPDATE SITE MAPS DURING CONSTRUCTION.
2. INTERMEDIATE BMP'S TO BE REMOVED ARE SHOWN AS SCREENED ON "FINAL EROSION CONTROL PLANS"

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Designer: AB	Structure Numbers
Detailer: AB	
Subset: EF	Subset Sheets: EF09 of 16

Project No./Code



FSA 0503-081

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Sheet Number 229



**Know what's below.
Call before you dig.**

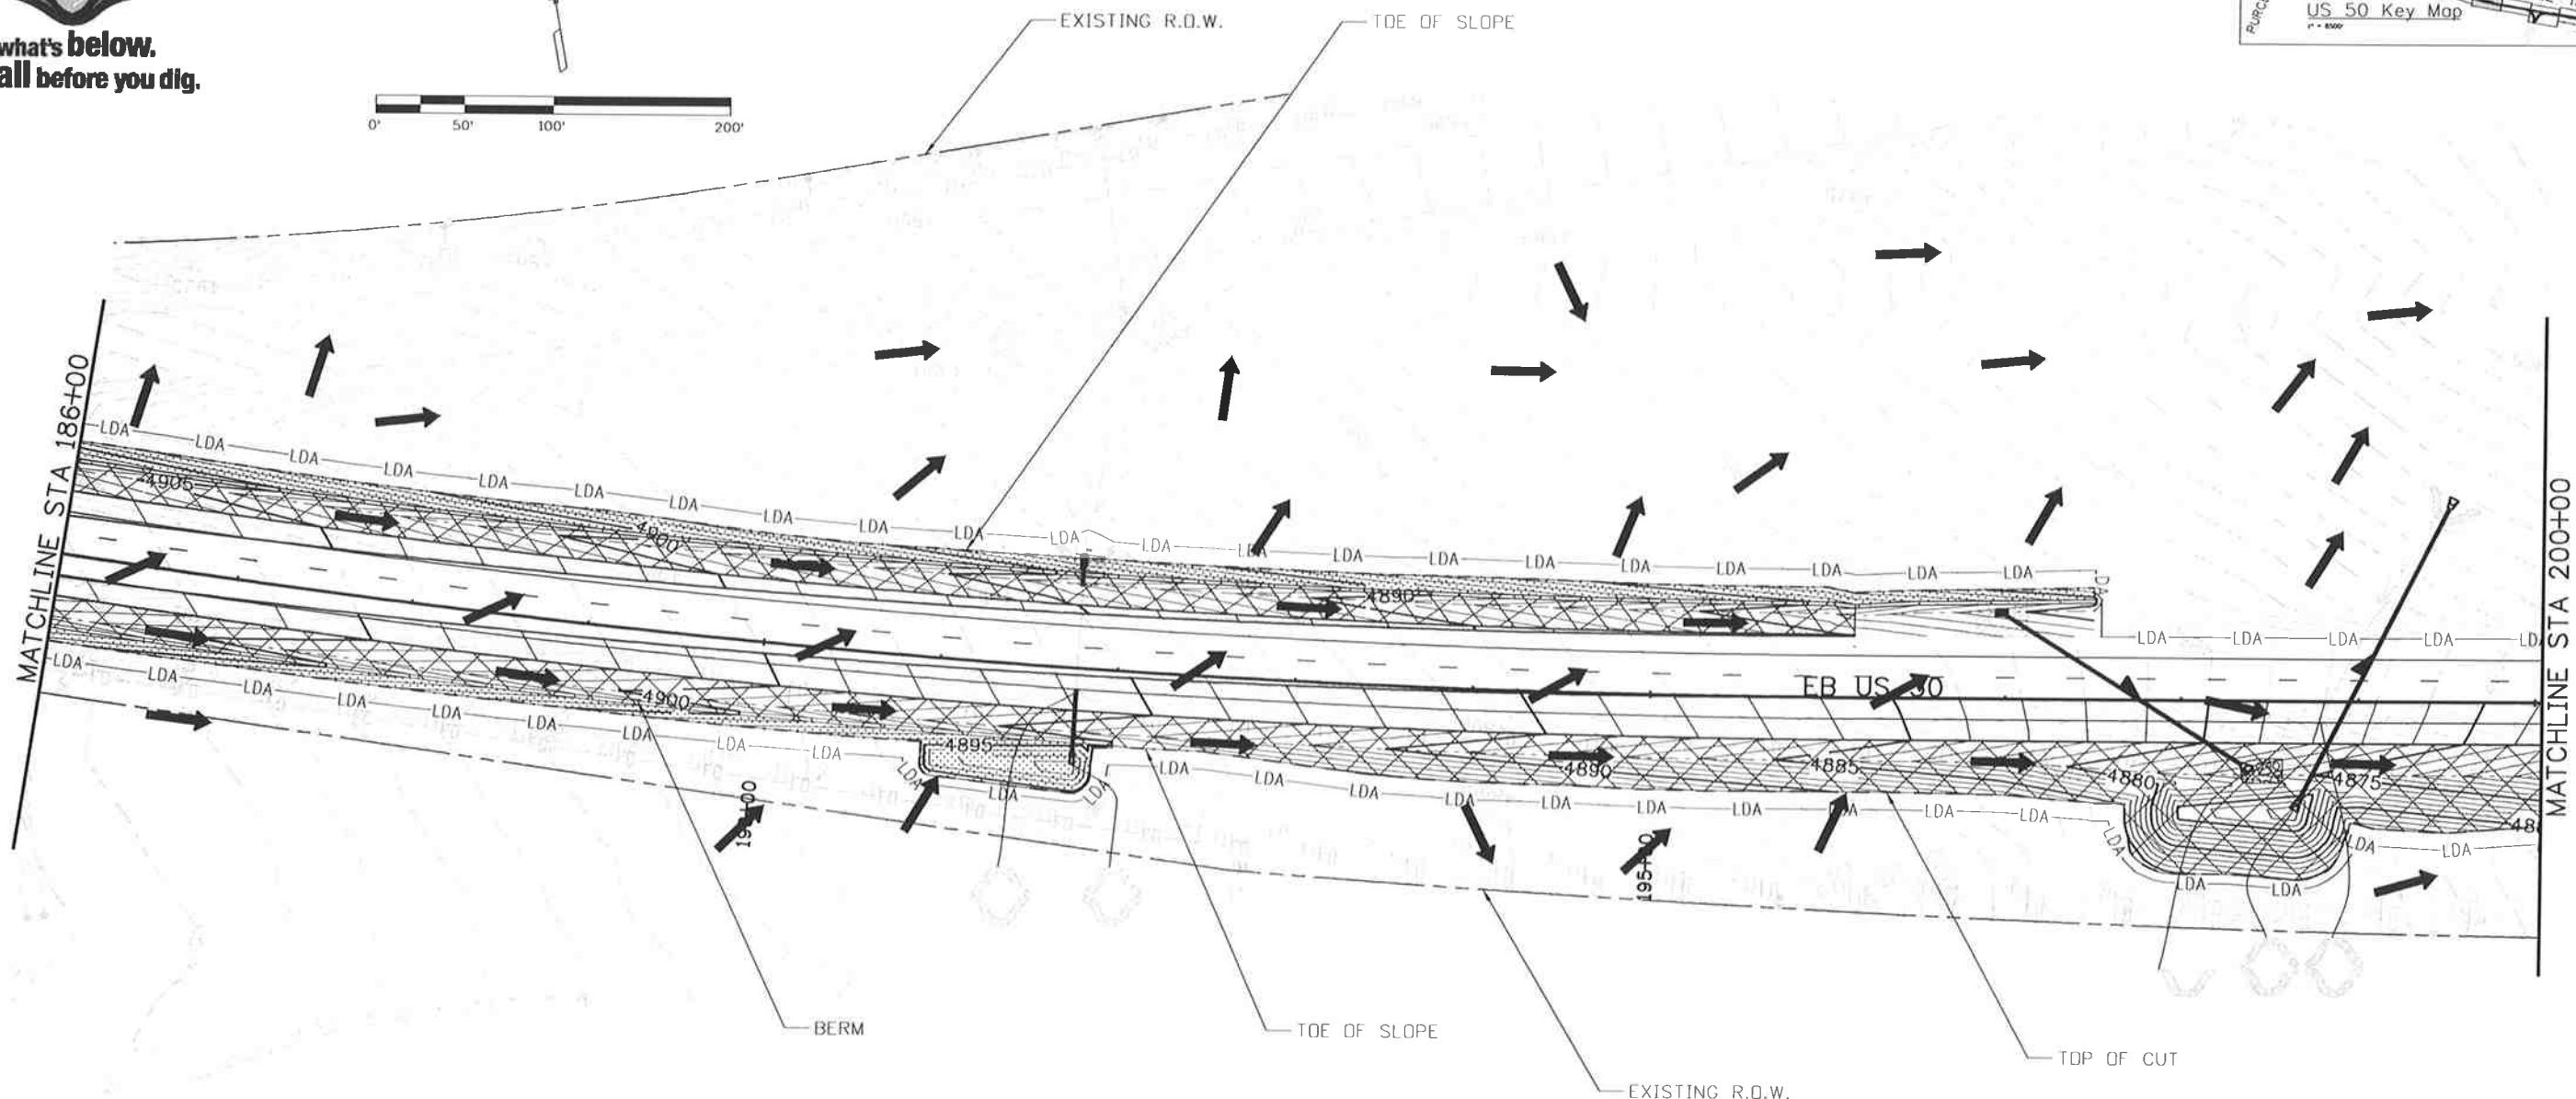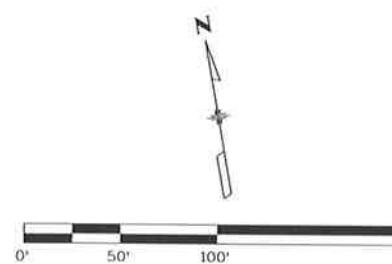

LEGEND

-LDA-	LIMITS OF DISTURBANCE
→	DIRECTION OF SURFACE FLOW
□	SOIL RETENTION BLANKETS
■	SEEDING
□	EXISTING WETLAND
○	AGGREGATE BAG CURB CHECK
○	DROP INLET PROTECTION
○	STORM DRAIN INLET PROTECTION
○	PIPE EROSION LOG
○	PIPE EROSION LOG-INLET

NOTES:
 1. ECS TO UPDATE SITE MAPS DURING CONSTRUCTION.
 2. INTERMEDIATE BMP'S TO BE REMOVED ARE SHOWN
 AS SCREENED ON "FINAL EROSION CONTROL PLANS"

Print Date: 10/28/2014

File Name: 19056DES_SWMP_10_Plan.dgn

Horiz. Scale: 1:100 Vert. Scale: As Noted



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US 50 WEST PURCELL BLVD. TO WILLS BLVD. EROSION CONTROL PLAN-FINAL


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Detailer: AB	
Subset: EF	Subset Sheets: EF10 of 16

Project No./Code

FSA 0503-081


19751

Sheet Number 230


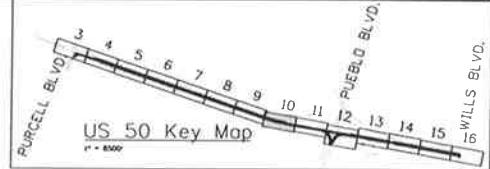




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EXISTING WETLAND

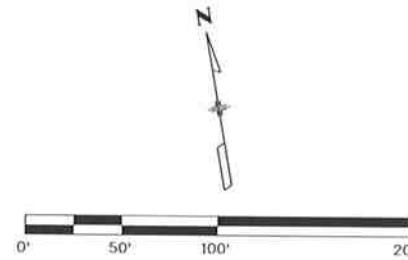

LEGEND

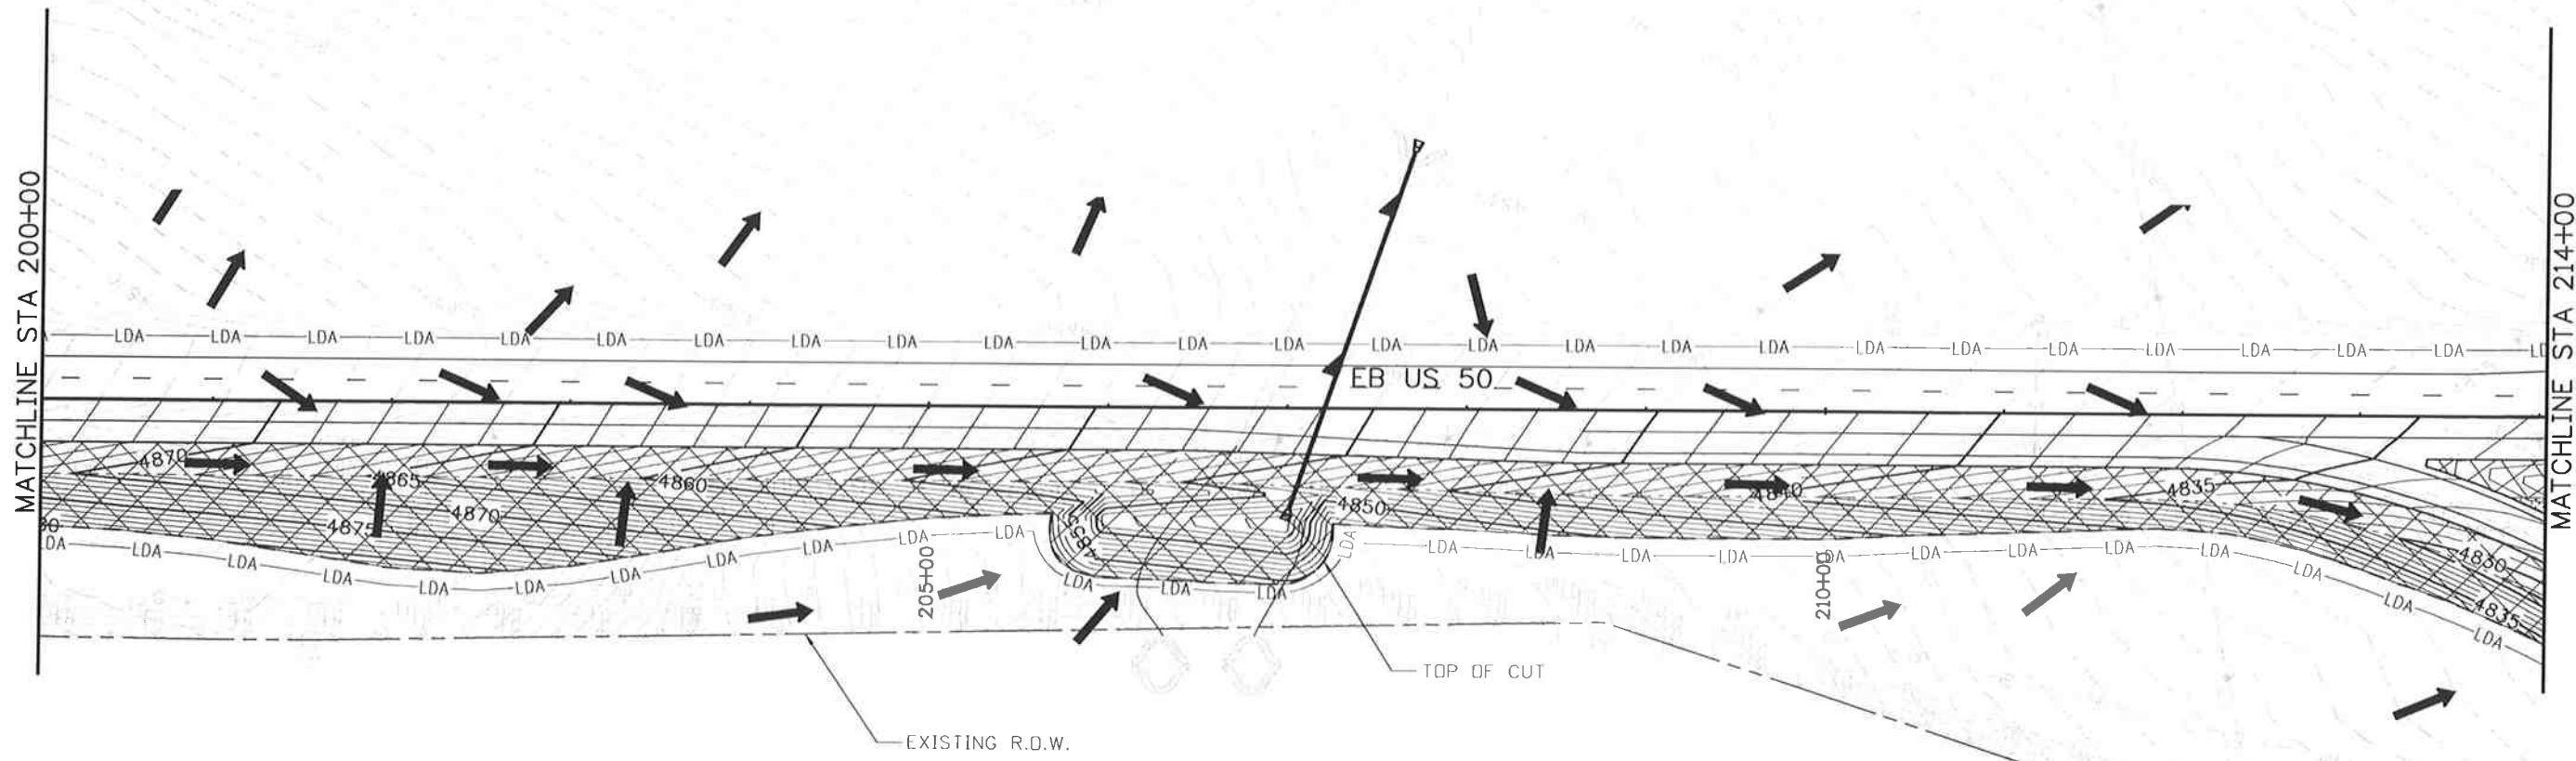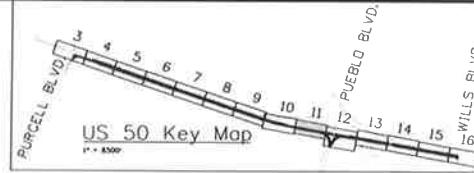-LDA	LIMITS OF DISTURBANCE	Aggregate Bag Curb Check
→	DIRECTION OF SURFACE FLOW	Drop Inlet Protection
□	SOIL RETENTION BLANKETS	Storm Drain Inlet Protection
■	SEEDING	Pipe Erosion Log
□	EXISTING WETLAND	Pipe Erosion Log-Inlet

NOTES:
 1. ECS TO UPDATE SITE MAPS DURING CONSTRUCTION.
 2. INTERMEDIATE BMP'S TO BE REMOVED ARE SHOWN AS SCREENED ON "FINAL EROSION CONTROL PLANS"

Print Date: 10/28/2014

File Name: 19056DES_SWMP_II_Plan.dgn

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Void:

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Project No./Code


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Sheet Number 231



**Know what's below.
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Print Date: 10/28/2014

File Name: 19056DES_SWMP_12_Plan.dgn

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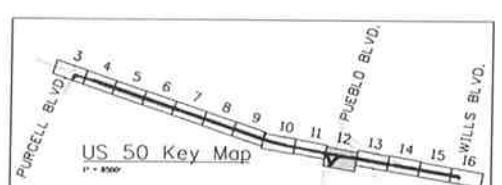
US 50 WEST PURCELL BLVD. TO WILLS BLVD. EROSION CONTROL PLAN-FINAL

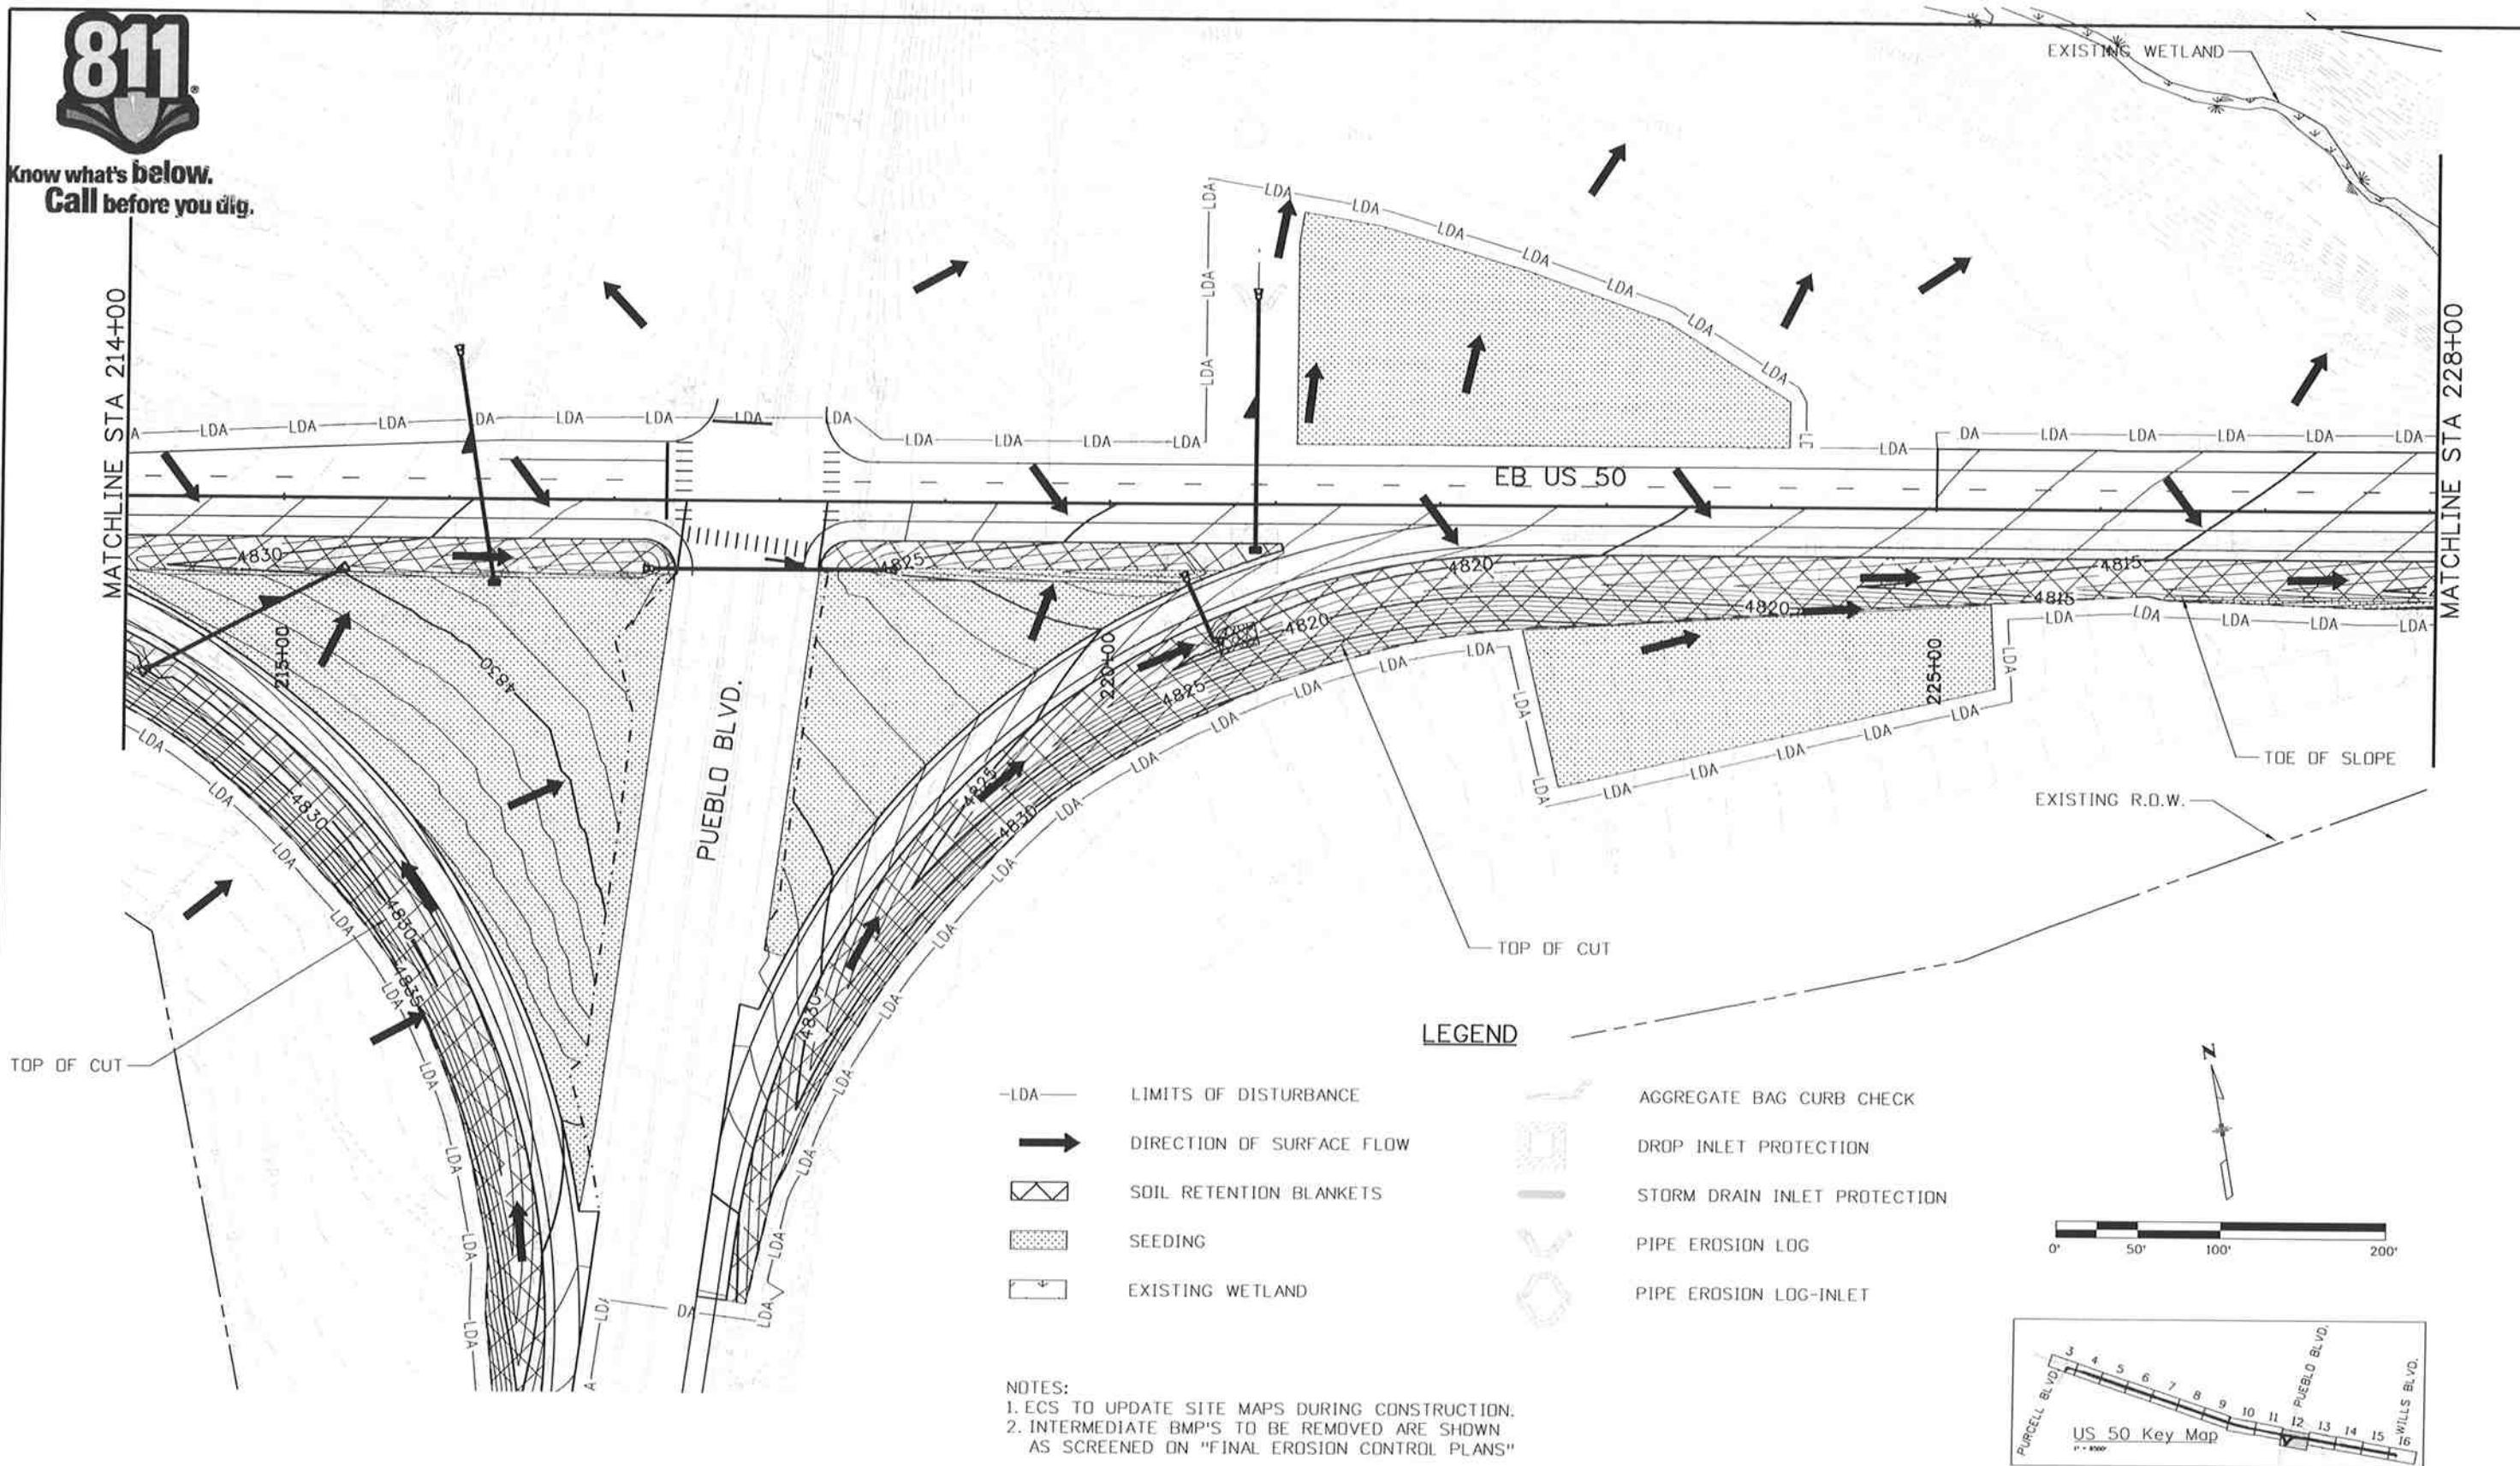Project No./Code

FSA 0503-081



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Sheet Number 232





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LEGEND

NOTES:

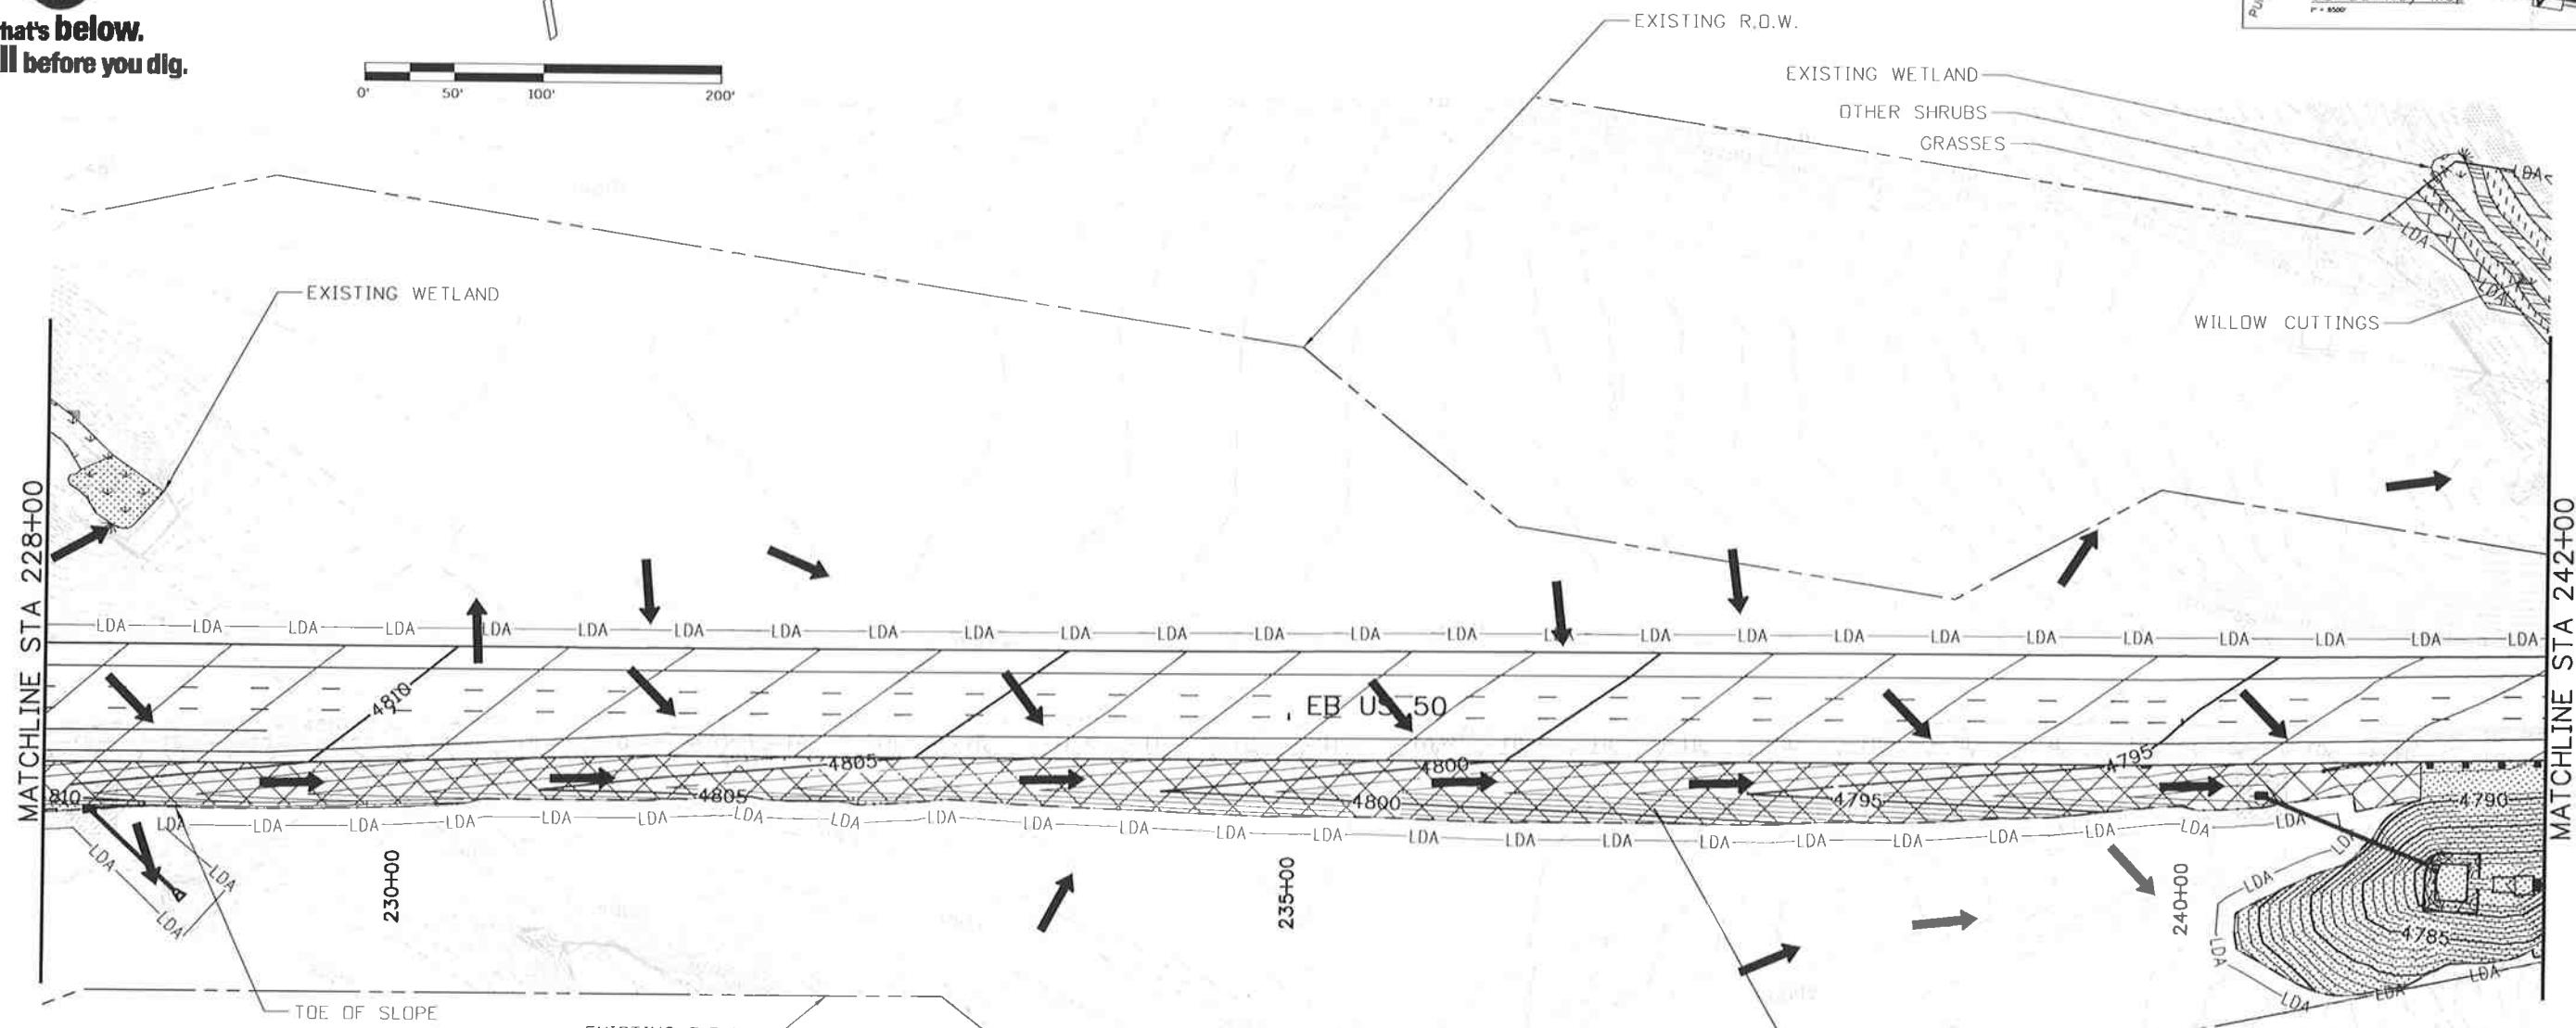
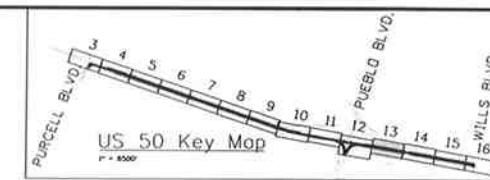
1. ECS TO UPDATE SITE MAPS DURING CONSTRUCTION.
2. INTERMEDIATE BMP'S TO BE REMOVED ARE SHOWN AS SCREENED ON "FINAL EROSION CONTROL PLANS"



**Know what's below.
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N

0' 50' 100' 200'

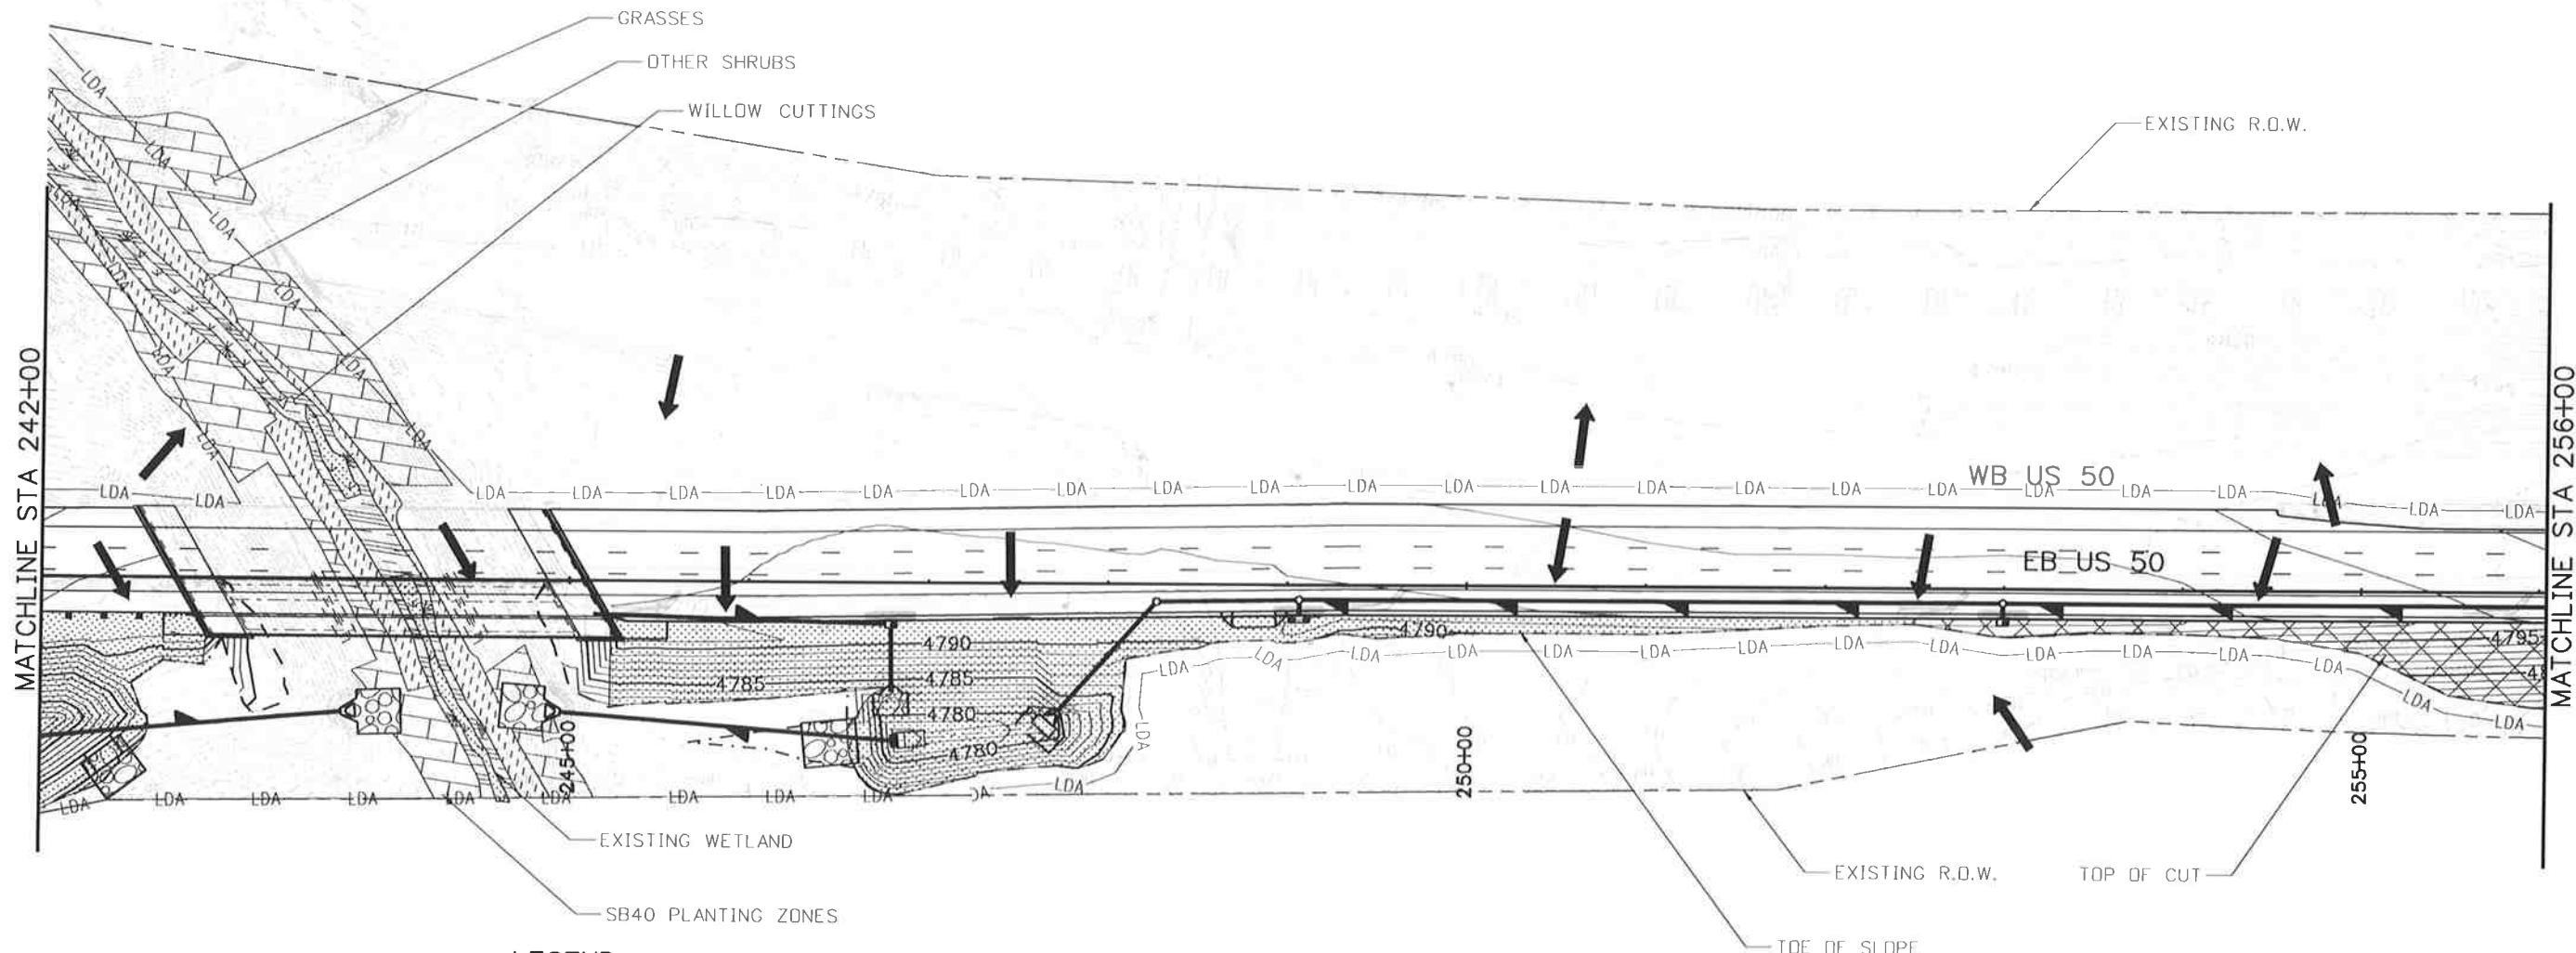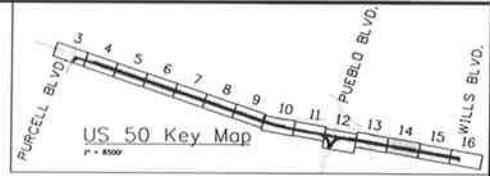

LEGEND

-LDA—	LIMITS OF DISTURBANCE	Aggregate Bag Curb Check
→	DIRECTION OF SURFACE FLOW	Drop Inlet Protection
□/□	SOIL RETENTION BLANKETS	Storm Drain Inlet Protection
■/■	SEEDING	Willow Cuttings
□/□	EXISTING WETLAND	Grasses
□/□	SB40 PLANTING ZONES	Other Shrubs
□/□	EXISTING WETLAND	PIPE EROSION LOG-INLET
□/□	EXISTING WETLAND	PIPE EROSION LOG

NOTES:
1. ECS TO UPDATE SITE MAPS DURING CONSTRUCTION.
2. INTERMEDIATE BMP'S TO BE REMOVED ARE SHOWN AS SCREENED ON "FINAL EROSION CONTROL PLANS"

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No Revisions:

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Void:

US 50 WEST PURCELL BLVD. TO WILLS BLVD. EROSION CONTROL PLAN

Project No./Code

FSA 0503-081

Designer: AB Structure

Detailer: AB Numbers



Subset: EF Subset Sheets: EF14 of 16

19751

Sheet Number 234



**Know what's below.
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LEGEND

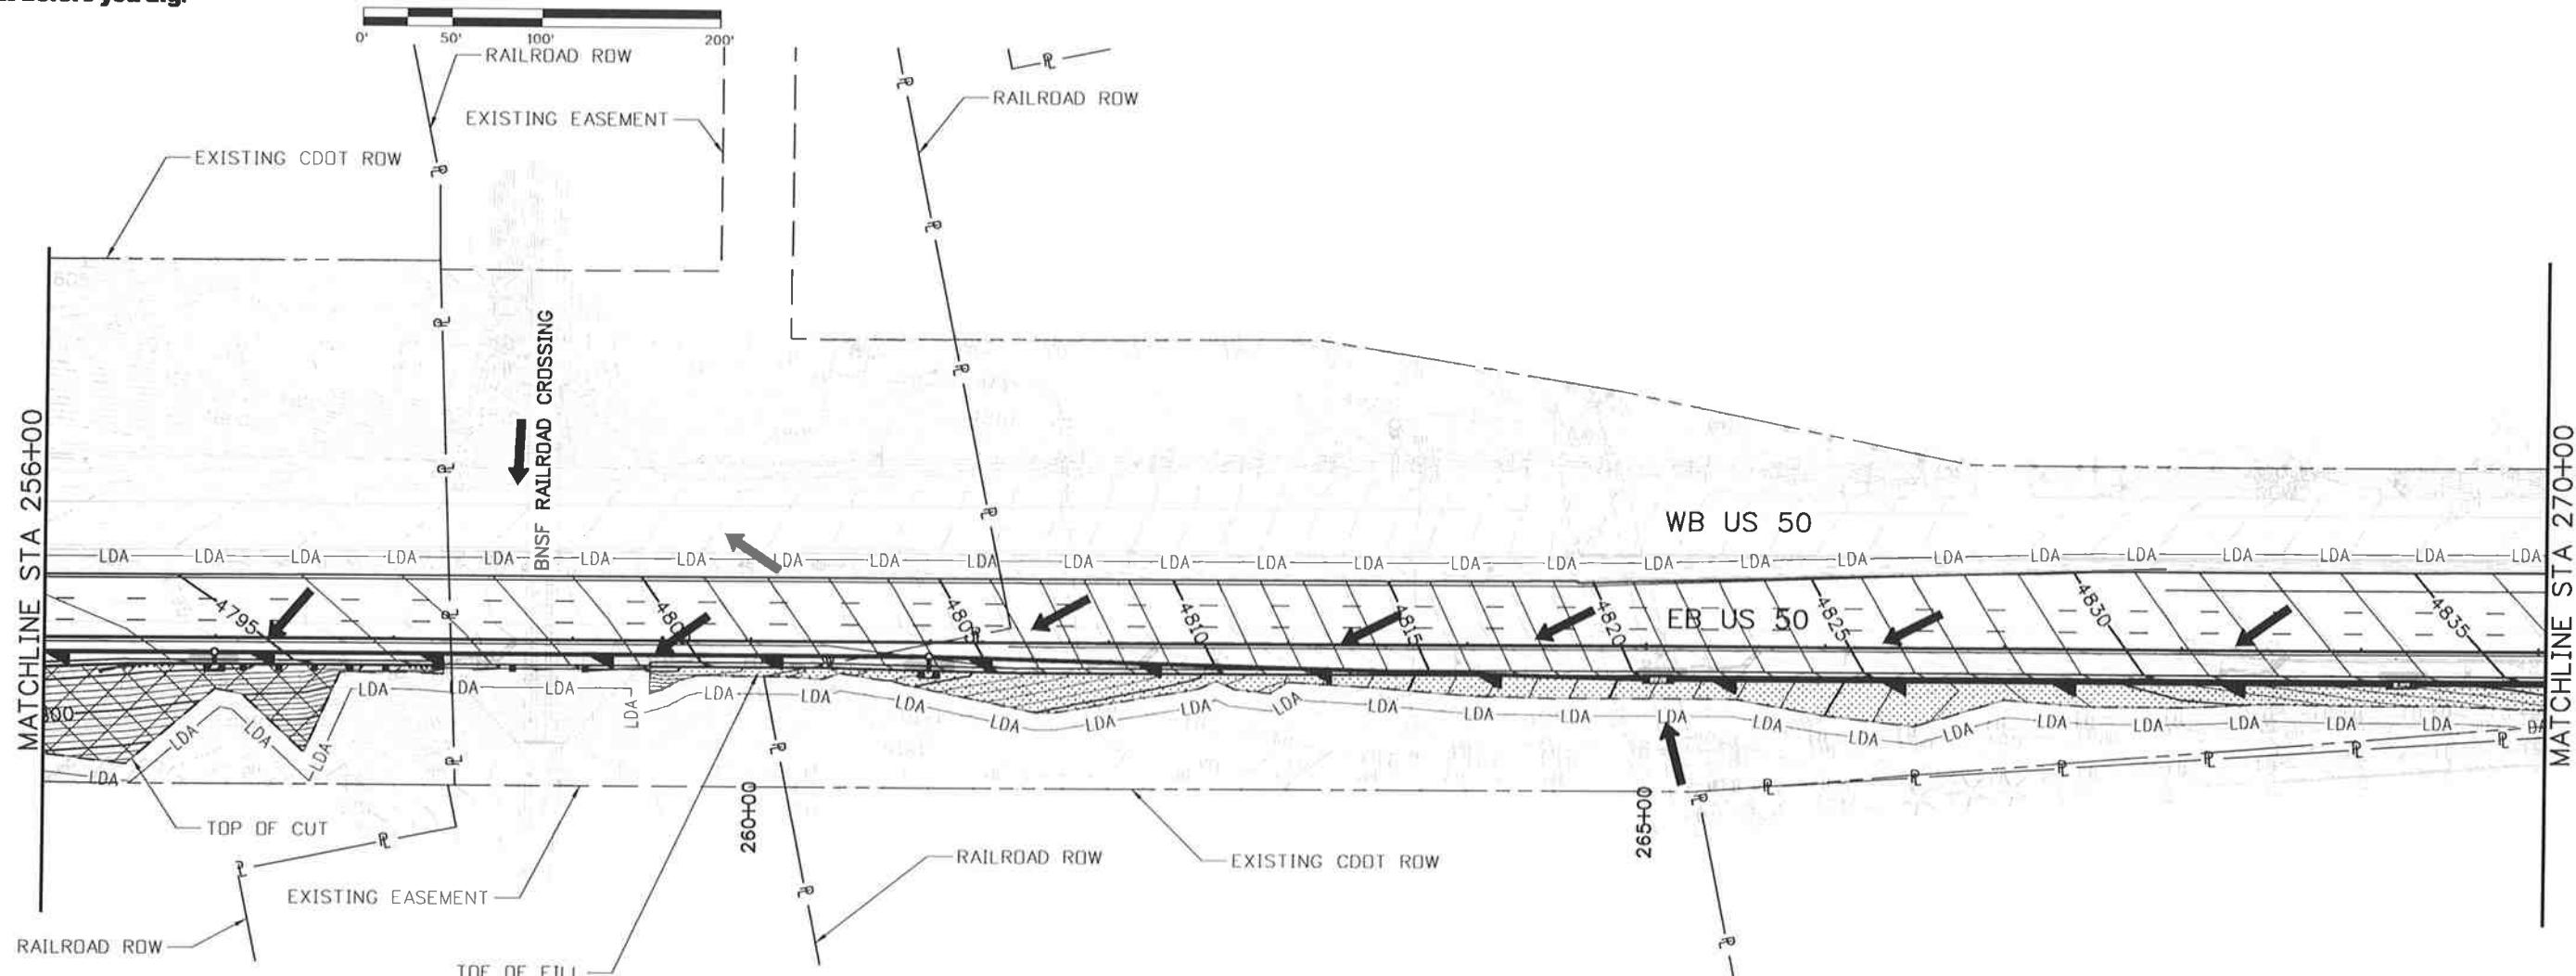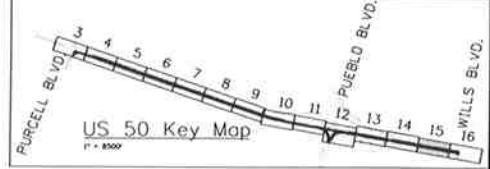- | | | |
|-----|---------------------------|------------------------------|
| LDA | LIMITS OF DISTURBANCE | AGGREGATE BAG CURB CHECK |
| → | DIRECTION OF SURFACE FLOW | DROP INLET PROTECTION |
| △ | SOIL RETENTION BLANKETS | STORM DRAIN INLET PROTECTION |
| ■ | SEEDING | PIPE EROSION LOG |
| □ | EXISTING WETLAND | PIPE EROSION LOG-INLET |

NOTES:
 1. ECS TO UPDATE SITE MAPS DURING CONSTRUCTION.
 2. INTERMEDIATE BMP'S TO BE REMOVED ARE SHOWN AS SCREENED ON "FINAL EROSION CONTROL PLANS"

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File Name: 19056DES_SWMP_15_Plan.dgn

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Project No./Code

FSA 0503-081




19751

Sheet Number 235

Designer: AB	Structure Numbers
Detailer: AB	
Subset: EF	Subsel Sheets: EF15 of 16



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NOTES:
1. ECS TO UPDATE SITE MAPS DURING CONSTRUCTION.
2. INTERMEDIATE BMP'S TO BE REMOVED ARE SHOWN AS SCREENED ON "FINAL EROSION CONTROL PLANS"
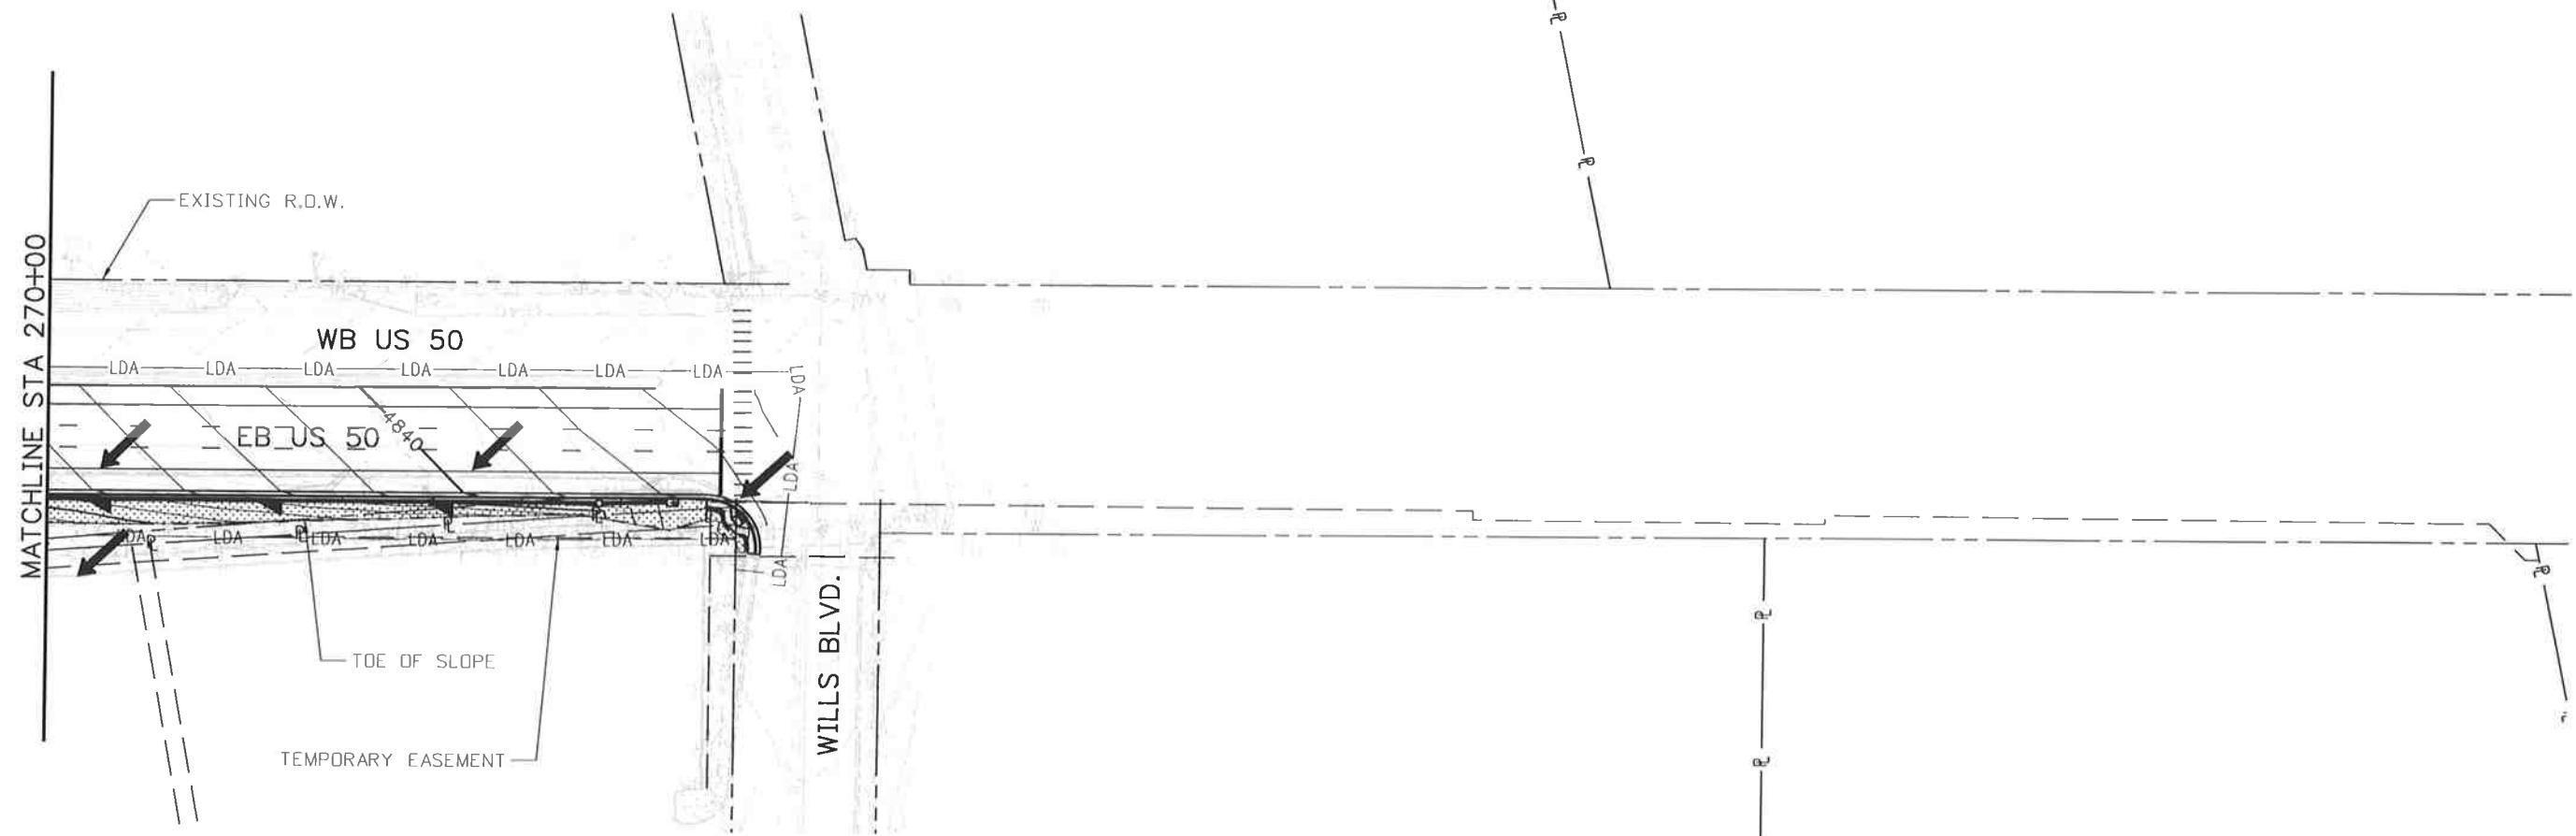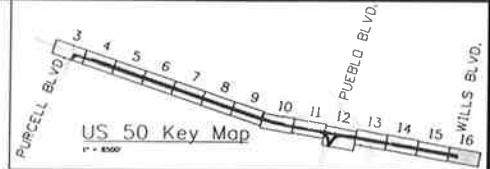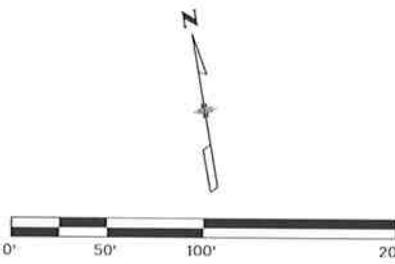
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File Name: 19056DES_SWMP_16_Plan.dgn

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No Revisions:

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Void:

US 50 WEST PURCELL BLVD. TO WILLS BLVD. EROSION CONTROL PLAN-FINAL

Designer: AB	Structure Numbers	FSA 0503-081
Detailer: AB		19751
Subset: EF	Subset Sheets: EF16 of 16	Sheet Number 236

TABULATION OF TRAFFIC ENGINEERING ITEMS

ITEM NUMBER	ITEM DESCRIPTION	UNIT	PROJECT TOTALS
202-00040	REMOVAL OF ELECTRICAL CONDUIT *	LF	30
202-00250	REMOVAL OF PAVEMENT MARKING *	SF	12,700
202-00720	REMOVAL OF CCTV CAMERA	EA	1
202-00750	REMOVAL OF LUMINAIRE	EA	4
202-00805	REMOVAL OF OVERHEAD SIGN STRUCTURE *	EA	1
202-00810	REMOVE OF GROUND SIGN	EA	46
202-00825	REMOVAL OF FLASING BEACON	EA	2
202-00827	REMOVAL OF PULL BOX *	EA	6
202-00831	REMOVAL OF TRAFFIC SIGNAL HEAD	EA	2
202-00840	REMOVAL OF TRAFFIC SIGNAL POLE	EA	3
202-00858	REMOVAL OF PEDESTAL POLE	EA	1
202-00860	REMOVAL OF PEDESTRIAN PUSH BUTTON	EA	2
210-00476	RESET MICROWAVE VEHICLE RADAR DETECTOR (MVRD)	EA	3
210-00750	RESET LIGHT STANDARD *	EA	1
210-00815	RESET SIGN PANEL	EA	1
210-00825	RESET FLASHING BEACON	EA	2
210-00858	RESET PEDESTAL POLE	EA	1
210-00890	RESET INTERSECTION DETECTION SYSTEM (CAMERA)	EA	6
503-00012	DRILLED CAISSON (12 INCH)	LF	7
503-00018	DRILLED CAISSON (18 INCH)	LF	4
503-00036	DRILLED CAISSON (36 INCH)	LF	19
503-00048	DRILLED CAISSON (48 INCH)	LF	74
604-39050	MANHOLE (TRAFFIC MANAGEMENT SYSTEM)	EA	4
613-00200	2 INCH ELECTRICAL CONDUIT	LF	90
613-00206	2 INCH ELECTRICAL CONDUIT (BORED)	LF	659
613-00306	3 INCH ELECTRICAL CONDUIT (BORED)	LF	800
613-07023	PULL BOX (24"X36"X24")	EA	8
613-07039	PULL BOX (30"X48"X18")	EA	1
613-10000	WIRING	LS	1
613-13006	LUMINARE (LED) (8500 LUMENS)	EA	4
613-40010	LIGHT STANDARD FOUNDATION *	EA	1
614-00011	SIGN PANEL (CLASS I)	SF	131
614-00012	SIGN PANEL (CLASS II)	SF	335
614-00013	SIGN PANEL (CLASS III)	SF	385
614-00615	STEEL SIGN POST (W 6X15)	LF	128
614-01502	STEEL SIGN SUPPORT (2 IN RD) (POST AND SOCKET)	LF	70
614-01572	STEEL SIGN SUPPORT (2-1/2 IN RD SCH 40) (POST AND SLIP BASE)	LF	290
614-03002	CONCRETE FOOTING (TYPE 2)	EA	8
614-10147	VARIABLE MESSAGE SIGN LED (OVERHEAD)	EA	1
614-32400	MONOTUBE OVERHEAD SIGN CANTILEVER (24 INCH DIAMETER)	EA	1
614-70150	PEDESTRIAN SIGNAL FACE (16) (COUNTDOWN)	EA	8
614-70336	TRAFFIC SIGNAL FACE (12-12-12)	EA	11
614-70448	TRAFFIC SIGNAL FACE (12-12-12-12)	EA	3
614-72860	PEDESTRIAN PUSH BUTTON	EA	7
614-72863	PEDESTRIAN PUSH BUTTON POST ASSEMBLY	EA	1
614-81150	TRAFFIC SIGNAL-LIGHT POLE STEEL (1-50 FOOT MAST ARM)	EA	1
614-81160	TRAFFIC SIGNAL-LIGHT POLE STEEL (1-60 FOOT MAST ARM)	EA	2
614-87011	FIBER OPTIC CABLE (SINGLE MODE) (24 STRAND)	LF	50
614-87524	SPICE FIBER OPTIC CABLE (24 STRAND)	EA	1
621-00450	DETOUR PAVEMENT	SY	611

* FOR INFO ON

NOTE:
SCHEDULE OF TRAFFIC CONTROL DEVICES PROVIDED FOR INFORMATION ONLY

TABULATION OF TRAFFIC ENGINEERING ITEMS

ITEM NUMBER	ITEM DESCRIPTION	UNIT	PROJECT TOTALS
627-00007	EPOXY PAVEMENT MARKING (SPECIAL)	GAL	179
627-00011	PAVEMENT MARKING PAINT (WATERBORNE)	GAL	400
627-30405	PREFORMED THERMOPLASTIC PAVEMENT MARKING (WORD-SYMBOL)	SF	93
627-30410	PREFORMED THERMOPLASTIC PAVEMENT MARKING (XWALK-STOPLINE)	SF	903
630-00000	FLAGGING	HR	3,808
630-00007	TRAFFIC CONTROL INSPECTION	DAY	127
630-00012	TRAFFIC CONTROL MANAGEMENT	DAY	238
630-80001	FLASHING BEACON (PORTABLE)	EA	10
630-80335	BARRICADE (TYPE 3 M-A) (TEMPORARY)	EA	3
630-80341	CONSTRUCTION TRAFFIC SIGN (PANEL SIZE A)	EA	43
630-80342	CONSTRUCTION TRAFFIC SIGN (PANEL SIZE B)	EA	91
630-80344	CONSTRUCTION TRAFFIC SIGN (SPECIAL)	SF	165
630-80358	ADVANCE WARNING FLASHING OR SEQUENCING ARROW PANEL (C TYPE)	EA	6
630-80359	PORTABLE MESSAGE SIGN	EA	4
630-80363	DRUM CHANNELIZING DEVICE (WITH LIGHT) (FLASHING)	EA	75
630-80370	CONCRETE BARRIER (TEMPORARY)	LF	3,000
630-80380	TRAFFIC CONE	EA	100
630-85011	IMPACT ATTENUATOR (TEMPORARY)	DAY	50

SCHEDULE OF TRAFFIC CONTROL DEVICES

SIGNS						
SIGN CODE	LEGEND	DIMENSION	PANEL SIZE			
			A EA	B EA	Spec SF	
FASTER	COLORADO AT WORK SIGN (SPECIAL)	66X60				165
G20-5	WORK ZONE	36X24	20			
G20-10	XYZ/CONSTRUCTION/THANKS YOU/555-555-5555	48X48		8		
G20-11	ROAD WORK INFORMATION	48X48		7		
M1-4	U.S. ROUTE SIGN	36X36	1			
M1-5A	STATE ROUTE SIGN	36X36	1			
M3-3	CARDINAL DIRECTION	36X18	1			
M3-4	CARDINAL DIRECTION	36X18	1			
M5-1L	ADVANCE TURN ARROW	30X21	2			
R1-2	YIELD	36X36	1			
R2-1	SPEED LIMIT	36X48		21		
R2-6(ap)	FINES/DOUBLE	36X24	6			
R3-7r	MANDATORY MOVEMENT RIGHT	30X30	1			
R4-1	DO NOT PASS	36X48		2		
R11-2	ROAD/CLOSED	48X30		4		
R52-6a	BEGIN FINES DOUBLE IN WORK ZONE	36X48		7		
R52-6b	END FINES DOUBLE IN WORK ZONE	36X48		8		
W1-2l	HORIZONTAL ALIGNMENT LEFT	48X48		2		
W1-4BL	REVERSE CURVE	48X48		2		
W1-4I	REVERSE CURVE	48X48		1		
W1-6r	ONE-DIRECTION LARGE ARROW RIGHT	60X30		2		
W1-9-3a	MIDDLE LANE CLOSED	48X48		2		
W3-3	SIGNAL AHEAD	48X48		2		
W4-1r	MERGE RIGHT	48X48		1		
W5-1	ROAD NARROWS	48X48		2		
W5-2	BRIDGE NARROWS	48X48		2		
W9-2l	LANE ENDS MERGE LEFT	48X48		1		
W12-1	DOUBLE ARROW	36X36	1			
W16-2a	ADVANCE DISTANCE	30X24	8			
W20-1	ROAD WORK	48X48		8		
W21-5	SHOULDER WORK	48X48		2		
W24-1aL	DOUBLE REVERSE CURVE LEFT	48X48		5		
W24-1aR	DOUBLE REVERSE CURVE RIGHT	48X48		2		
PROJECT TOTALS			43	91	165	

Print Date: 10/9/2016

File Name: 19056_Traffic_Engineering_Items.dgn

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Region

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US 50 WEST
McCULLOCH BLVD. TO WILLS BLVD.
TRAFFIC ENGINEERING ITEMS

Project No /Code

FSA 0503-081

19751


Sheet Number 237



Know what's below.
Call before you dig.

NOTE

MAINTAIN 2 LANES ON US 50 EB AT ALL TIMES
PHASE 1:
CONSTRUCT OUTSIDE LANE ON US 50 EB FROM 99+26 TO 116+00
CONSTRUCT NB RIGHT TURN LANE ON PURCELL BLVD.
MAINTAIN 2 LANES ON PURCELL BLVD. NB
PHASE 3:
CONSTRUCT INSIDE LANE ON US 50 EB FROM 105+59 TO 116+00

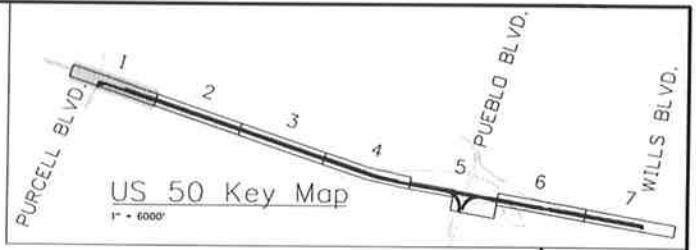

WB US 50

EB US 50

POB 95+00.00

PURCELL BLVD

100+00

MATCHLINE STA 102+00

MATCHLINE STA 102+00

WB US 50

EB US 50

105+00

110+00

115+00

MATCHLINE STA 116+00

Print Date: 10/9/2014

File Name: 19056DES_Construction Phasing_1.dgn

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**US 50 WEST
PURCELL BLVD. TO WILLS BLVD.
PROPOSED CONSTRUCTION PHASING**

Project No./Code

FSA 0503-081

19751

8

Sheet Number 238

	CONSTRUCTION PHASE 1
	CONSTRUCTION PHASE 2A
	CONSTRUCTION PHASE 2B
	CONSTRUCTION PHASE 3
	CONSTRUCTION PHASE 4



Know what's below.
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NOTE

MAINTAIN 2 LANES ON US 50 EB AT ALL TIMES


PHASE 1:

CONSTRUCT OUTSIDE LANE ON US 50 EB FROM 116+00 TO 144+00

COMPLETE PERMANENT EASEMENT GRADING FROM 122+48 TO 125+90

PHASE 3:

CONSTRUCT INSIDE LANE ON US 50 EB FROM 116+00 TO 144+00

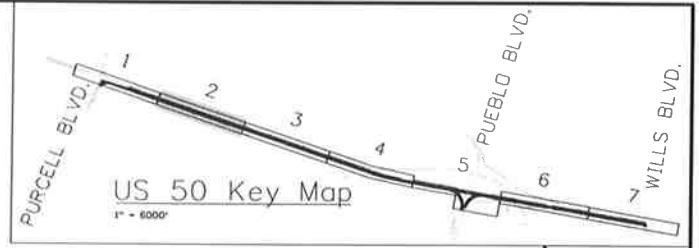

MATCHLINE STA 116+00

WB US 50

FB US 50

120+00

125+00

MATCHLINE STA 130+00

MATCHLINE STA 130+00

WB US 50

FB US 50

135+00

140+00

MATCHLINE STA 144+00

LEGEND

- CONSTRUCTION PHASE 1
- CONSTRUCTION PHASE 2A
- CONSTRUCTION PHASE 2B
- CONSTRUCTION PHASE 3
- CONSTRUCTION PHASE 4

Print Date: 10/9/2014

File Name: 19056DES_Construction Phasing_2.dgn

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**U.S. 50 WEST
PURCELL BLVD. TO WILLS BLVD.
PROPOSED CONSTRUCTION PHASING**

Project No./Code

FSA 0503-081

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Sheet Number 239

DTD

Designer:	AB	Structure

Detailer:	AB	Numbers

Subset:	CP	Subset Sheets: CP02 of 8



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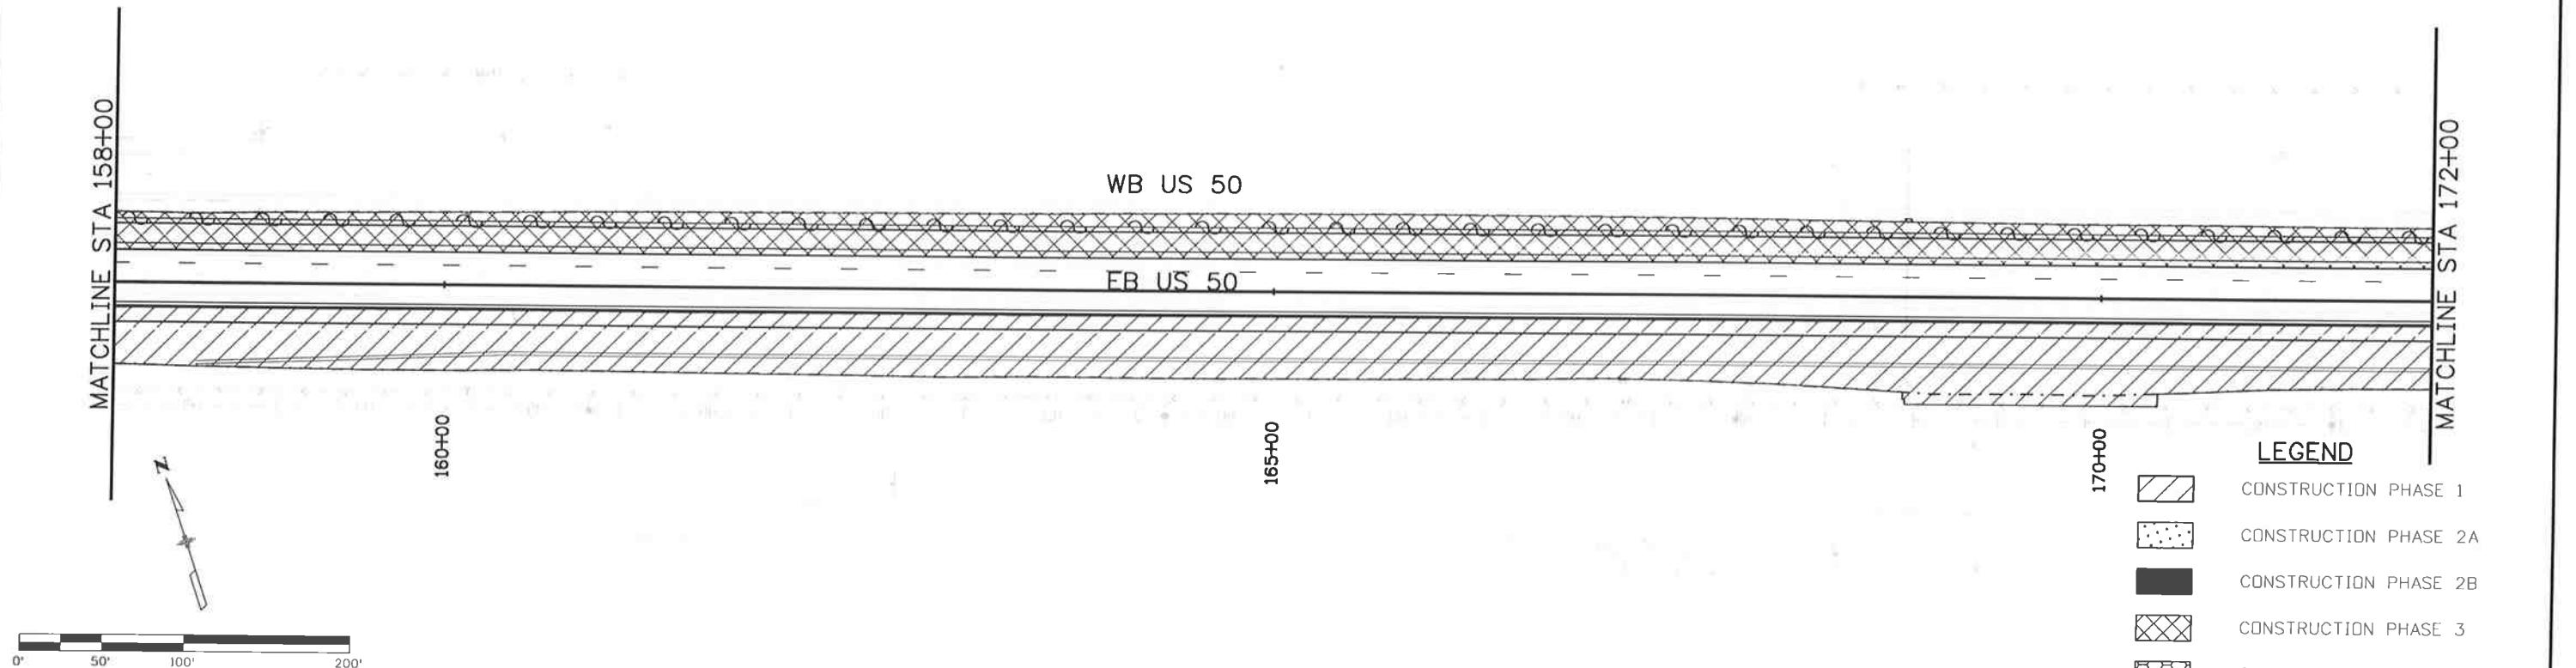
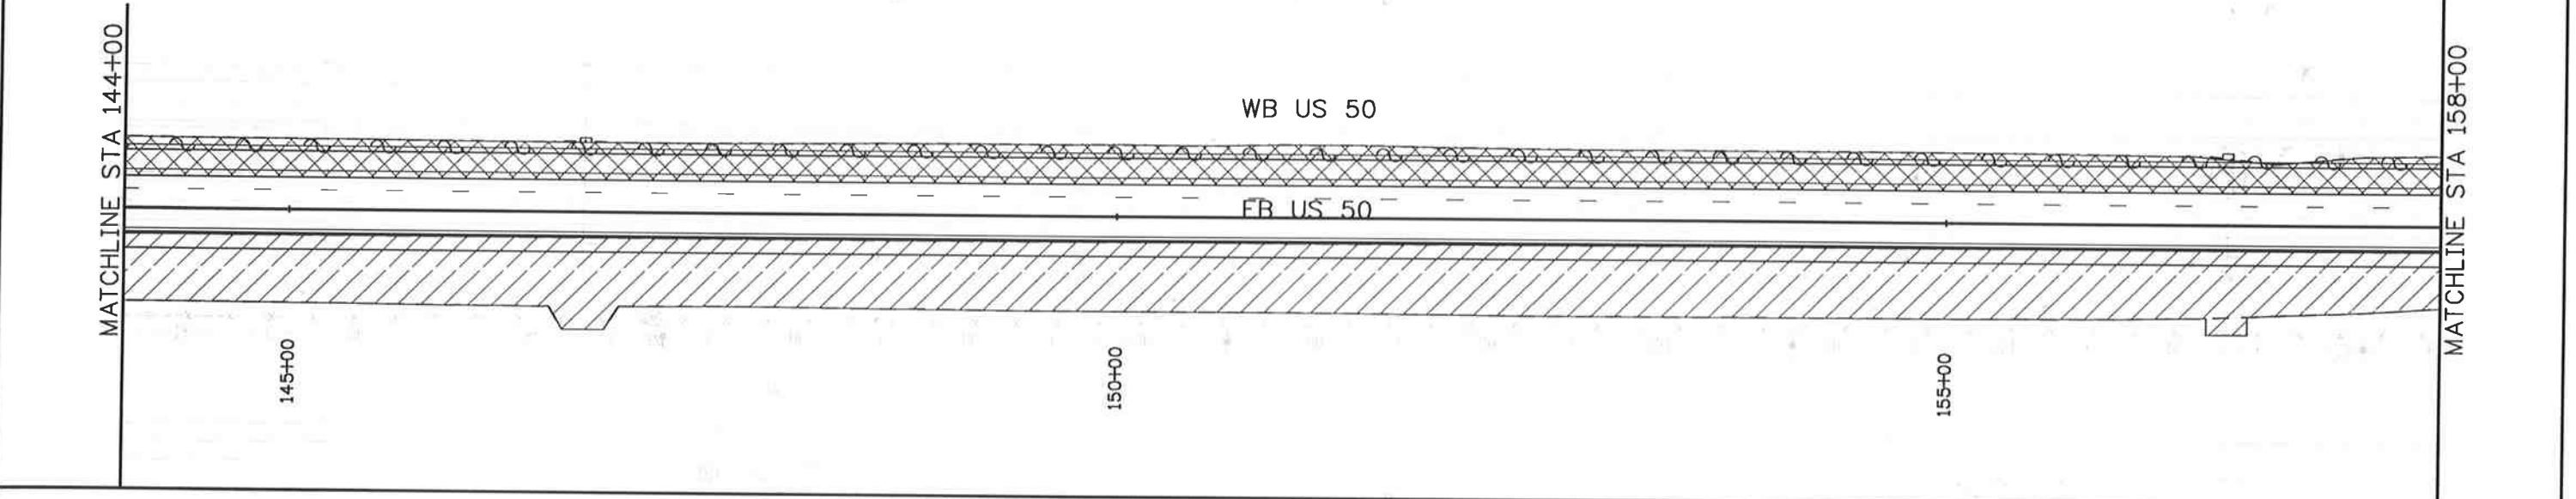
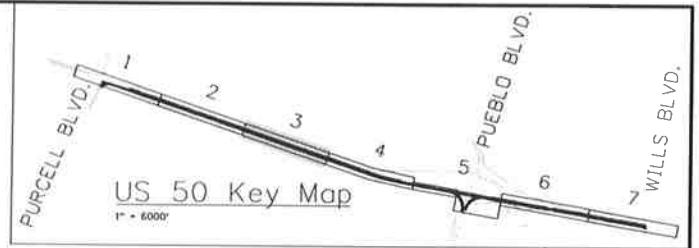
NOTE

MAINTAIN 2 LANES ON US 50 EB AT ALL TIMES
PHASE 1:

CONSTRUCT OUTSIDE LANE ON US 50 EB FROM 144+00 TO 172+00
COMPLETE PERMANENT EASEMENT GRADING FROM 146+58 TO 148+71,
AND 156+49 TO 157+85

PHASE 3:

CONSTRUCT INSIDE LANE ON US 50 EB FROM 144+00 TO 172+00



Print Date: 10/9/2014

File Name: 19056DES_Construction Phasing_3.dgn

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US 50 WEST
PURCELL BLVD. TO WILLS BLVD.
PROPOSED CONSTRUCTION PHASING

Project No./Code

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19751

Sheet Number 240




Subset: CP Subset Sheets: CPO3 of 8



**Know what's below.
Call before you dig.**

NOTE

MAINTAIN 2 LANES ON US 50 EB AT ALL TIMES
 PHASE 1:
 CONSTRUCT OUTSIDE LANE ON US 50 EB FROM 172+00 TO 200+00
 PHASE 3:
 CONSTRUCT INSIDE LANE ON US 50 EB FROM 172+00 TO 197+50

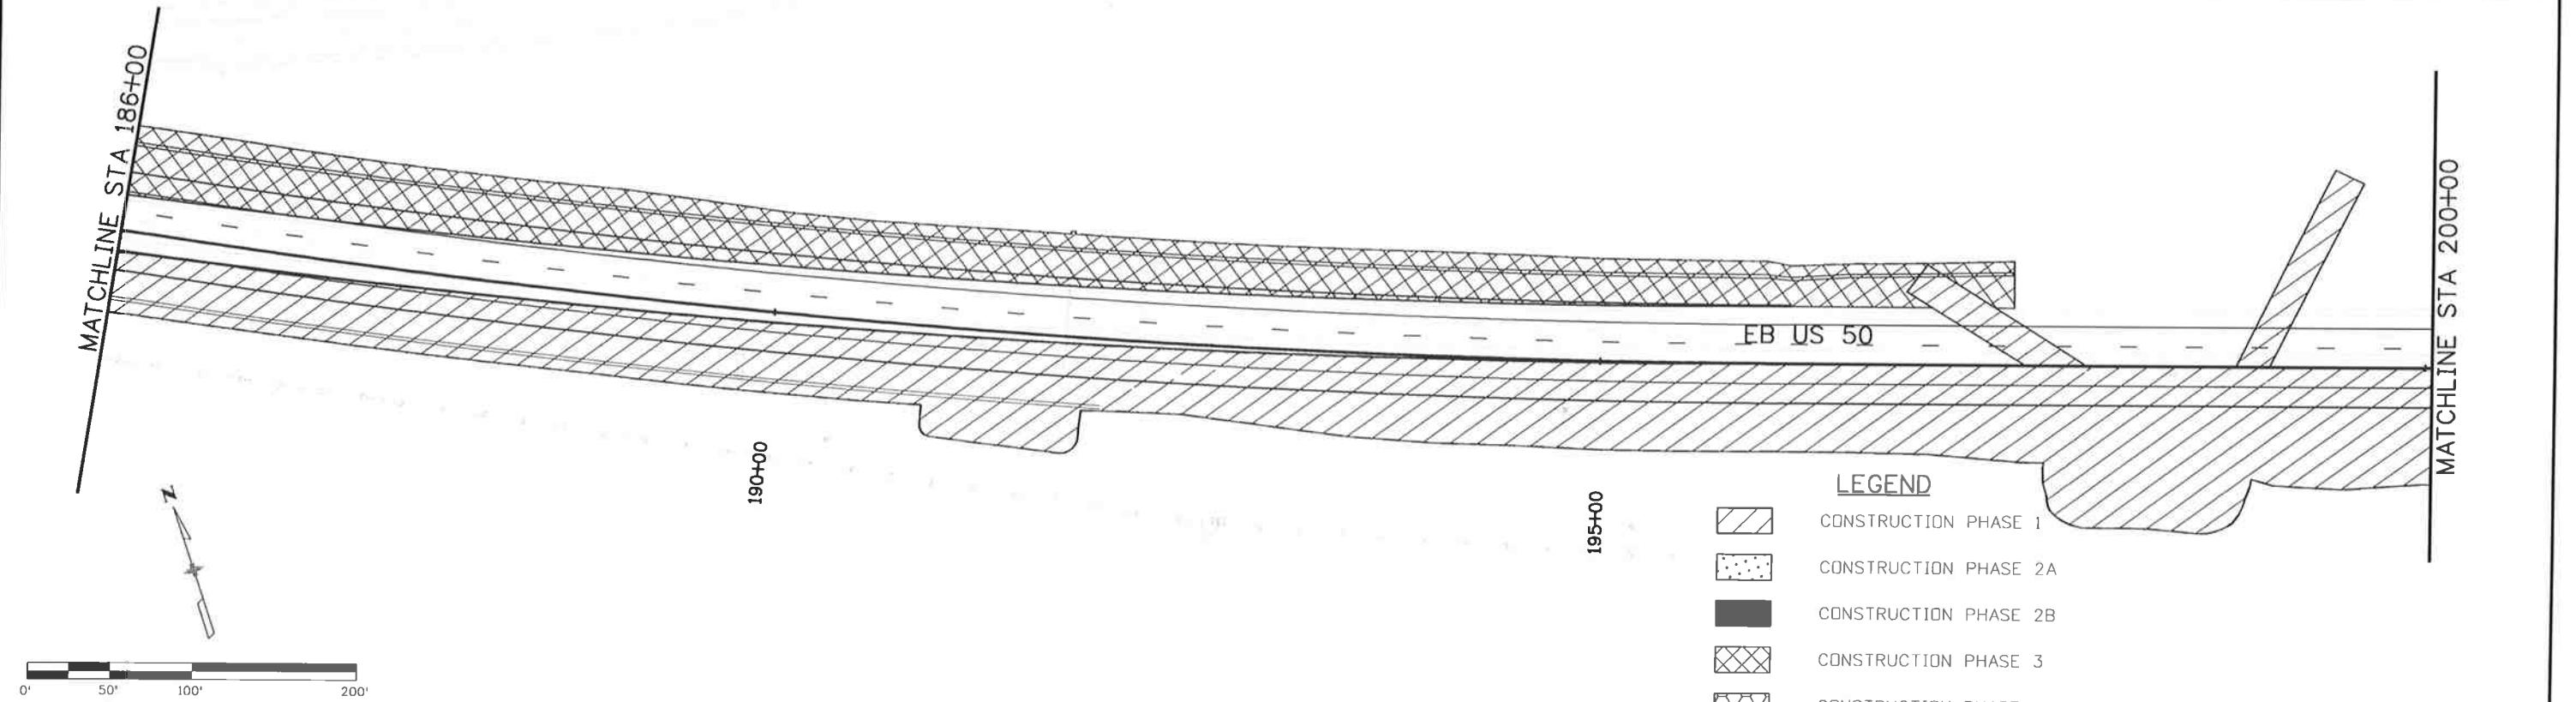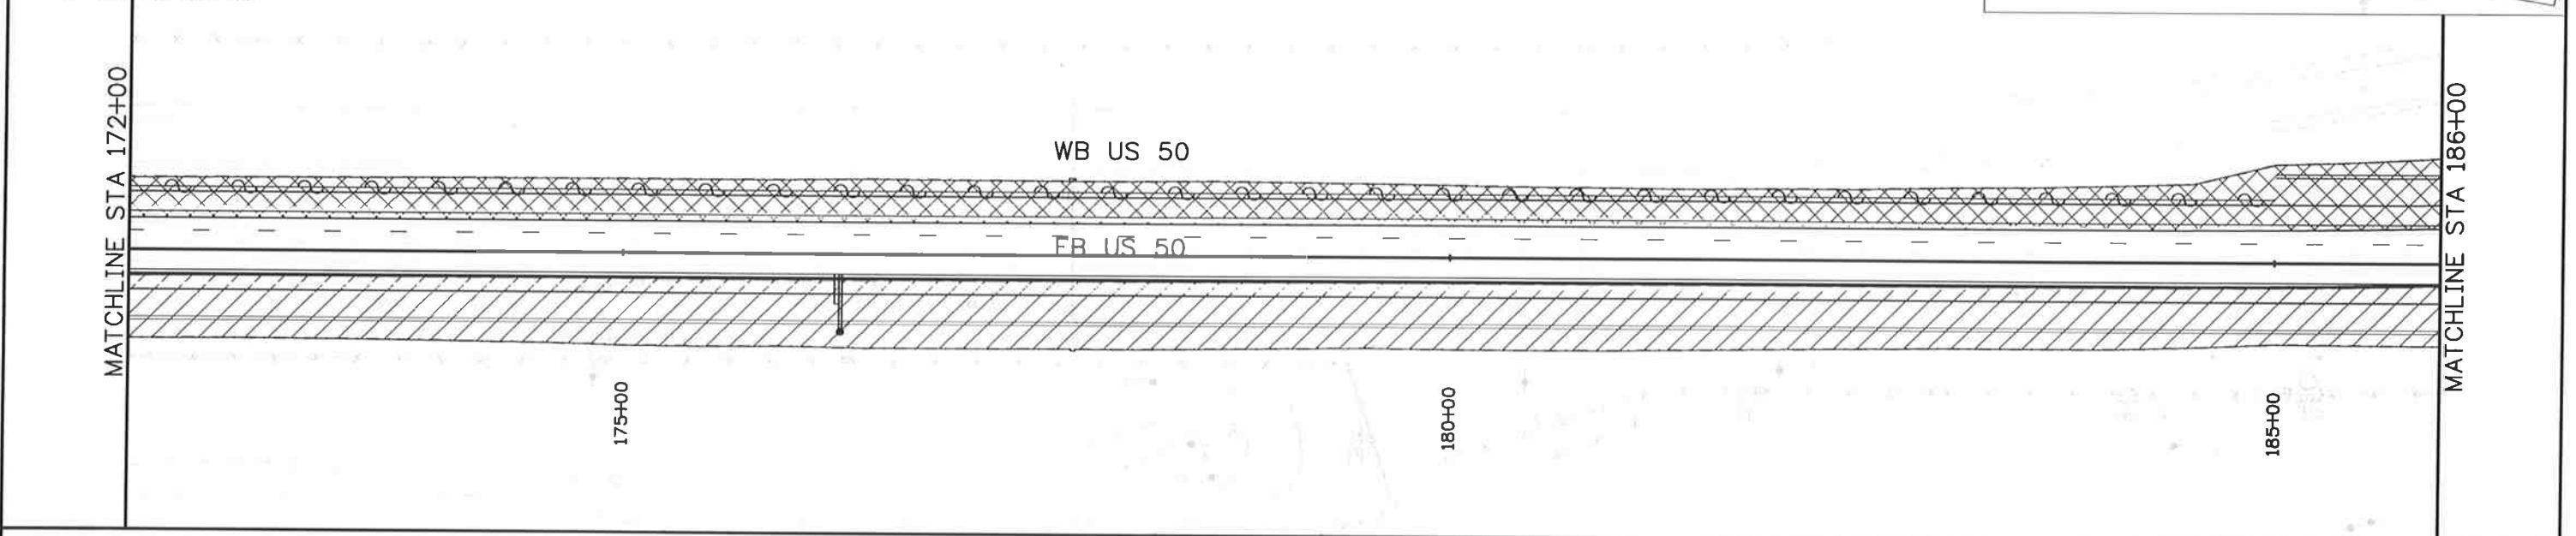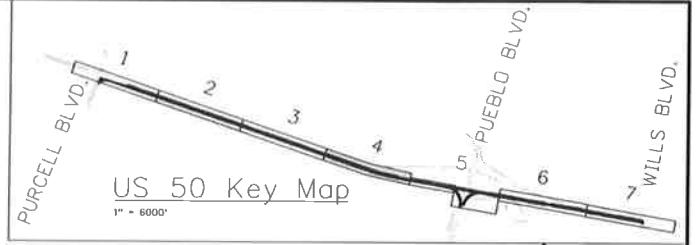

Print Date: 10/9/2014

File Name: 19056DES_Construction Phasing_4.dgn

Horiz. Scale: 1:100 Vert. Scale: As Noted



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DTD

As Constructed

No Revisions:

Revised:

Void:

**US 50 WEST
 PURCELL BLVD. TO WILLS BLVD.
 PROPOSED CONSTRUCTION PHASING**


Project No./Code

FSA 0503-081

19751

Sheet Number 241

Designer:	AB	Structure	
Detailer:	AB	Numbers	
Subset:	CP	Subset Sheets:	CP04 of 8



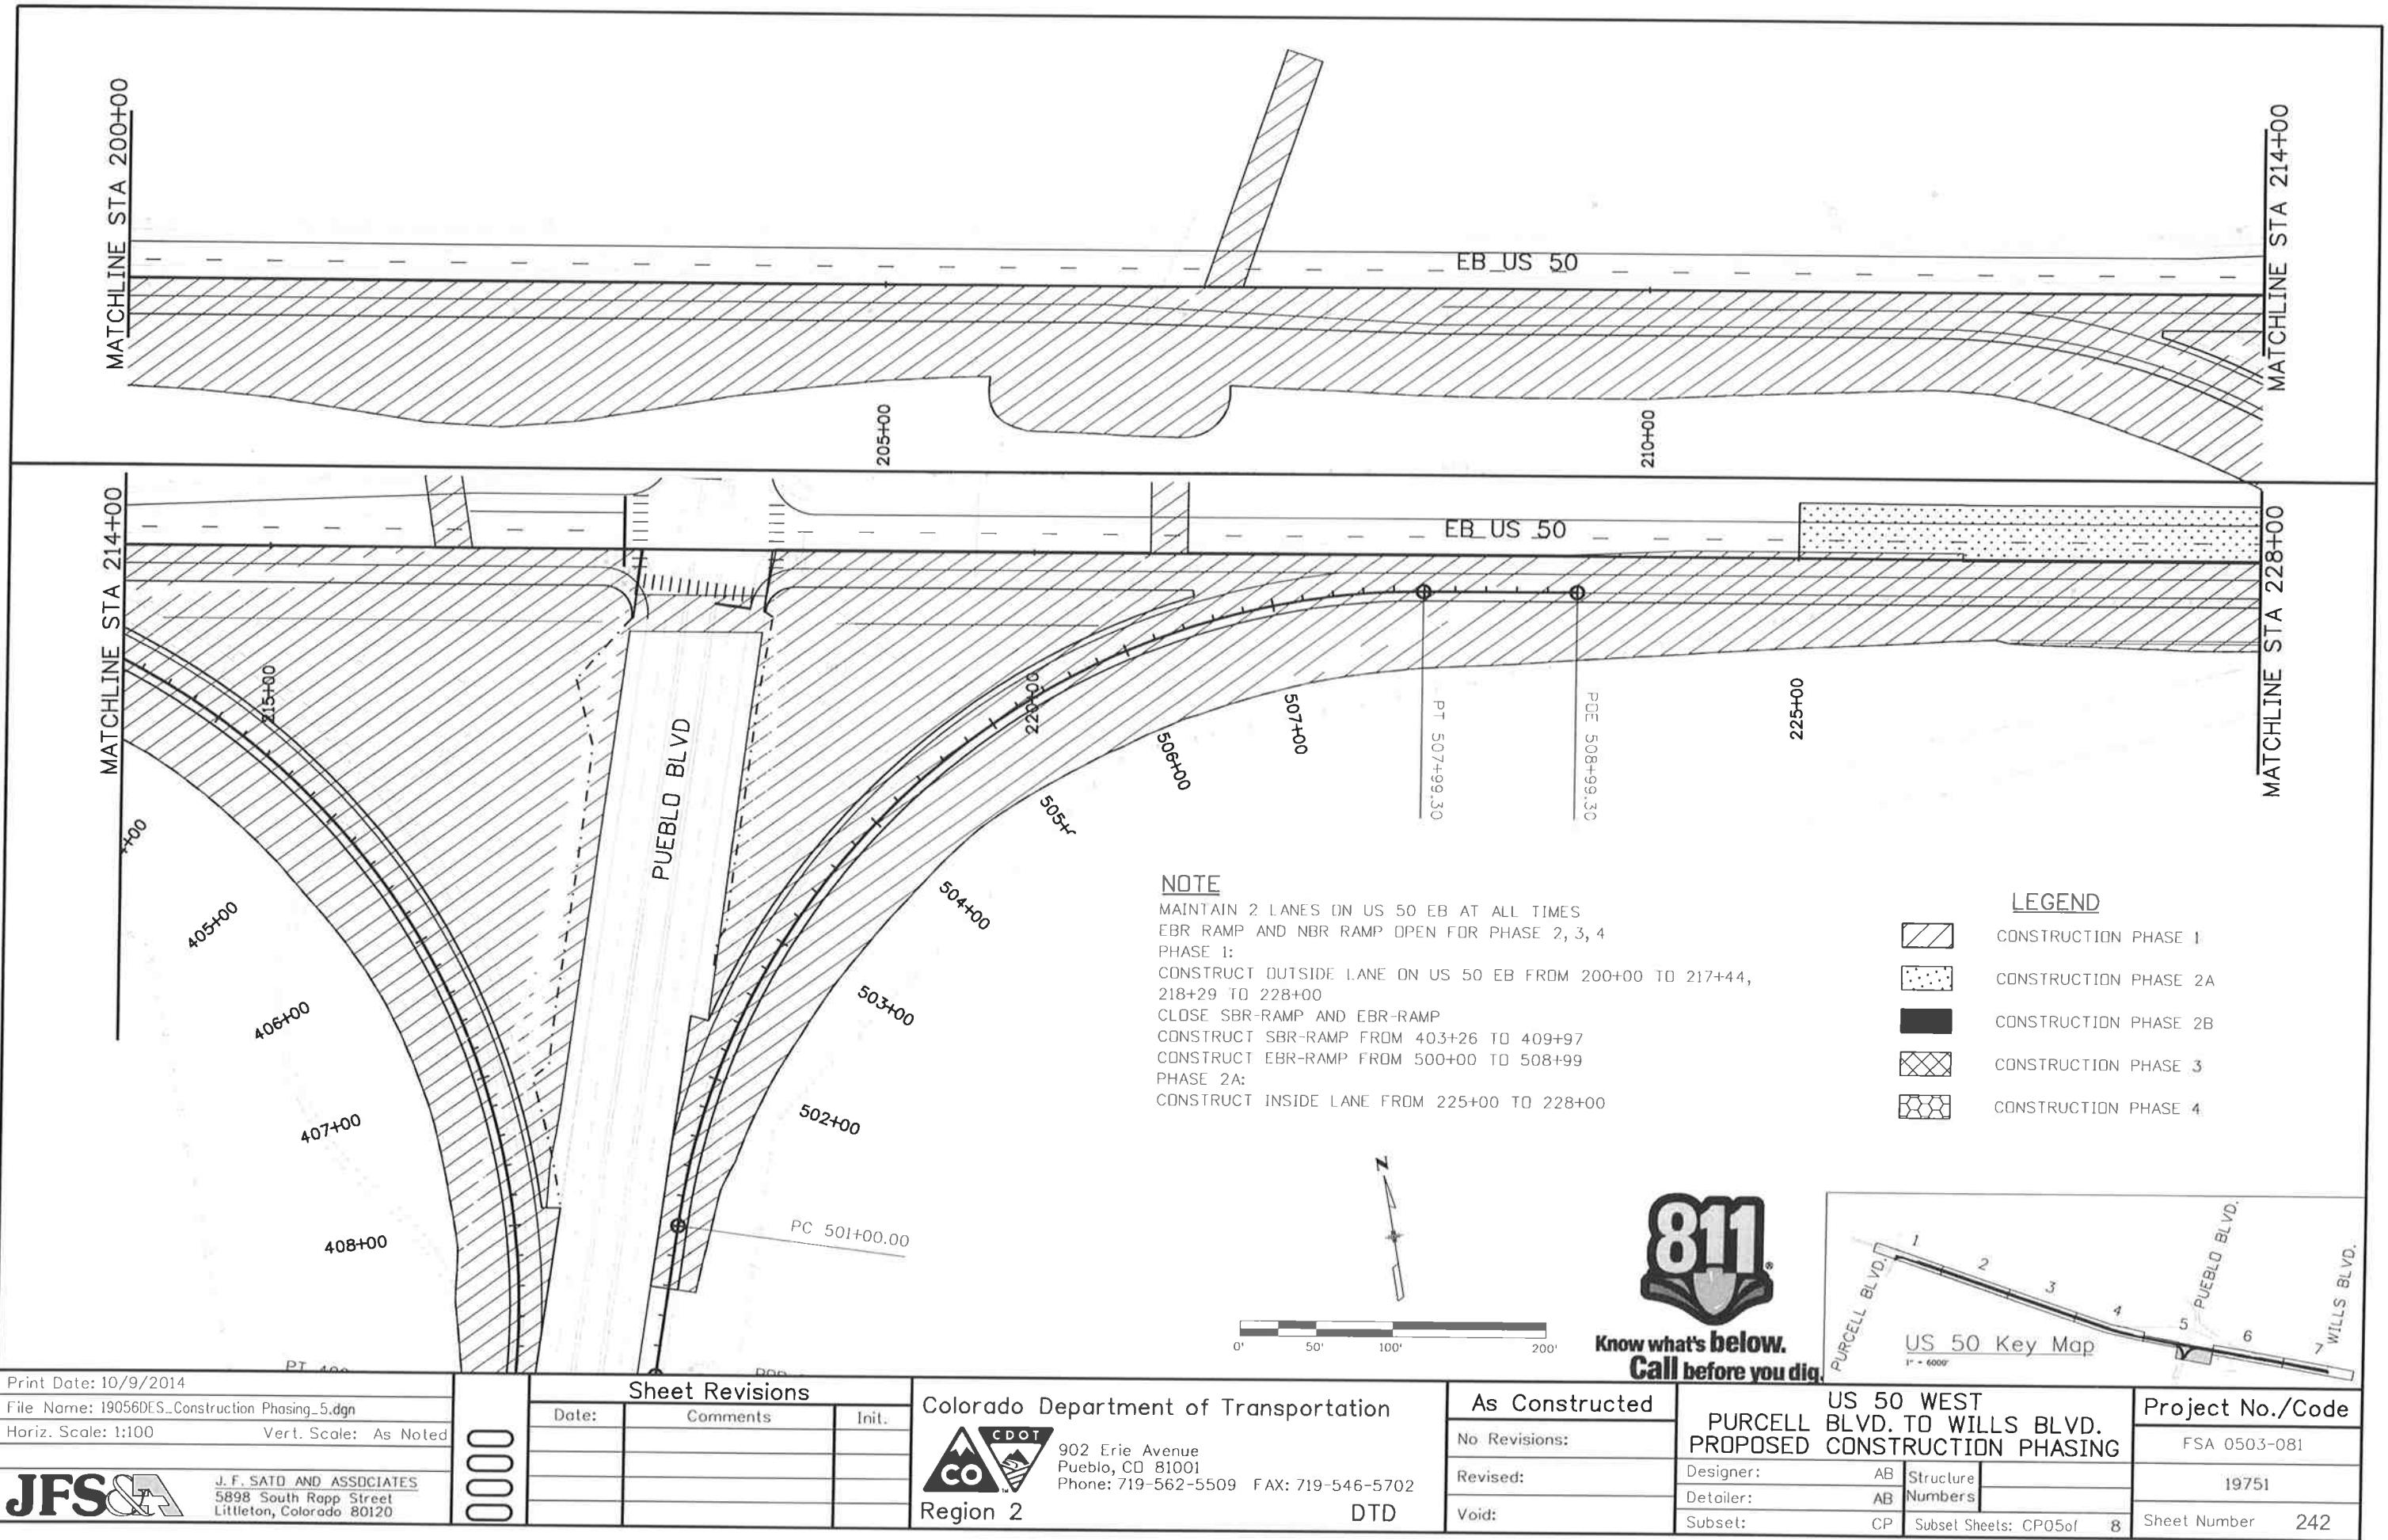




**Know what's below.
Call before you dig.**

NOTE

MAINTAIN 2 LANES ON US 50 EB AT ALL TIMES
 PHASE 1:
 CONSTRUCT OUTSIDE LANE ON US 50 EB FROM 228+00 TO 256+00
 PHASE 2A:
 CONSTRUCT INSIDE LANE ON US 50 EB FROM 228+00 TO 256+00
 PHASE 2B:
 CONSTRUCT MIDDLE LANE ON US 50 EB FROM 254+22 TO 256+00

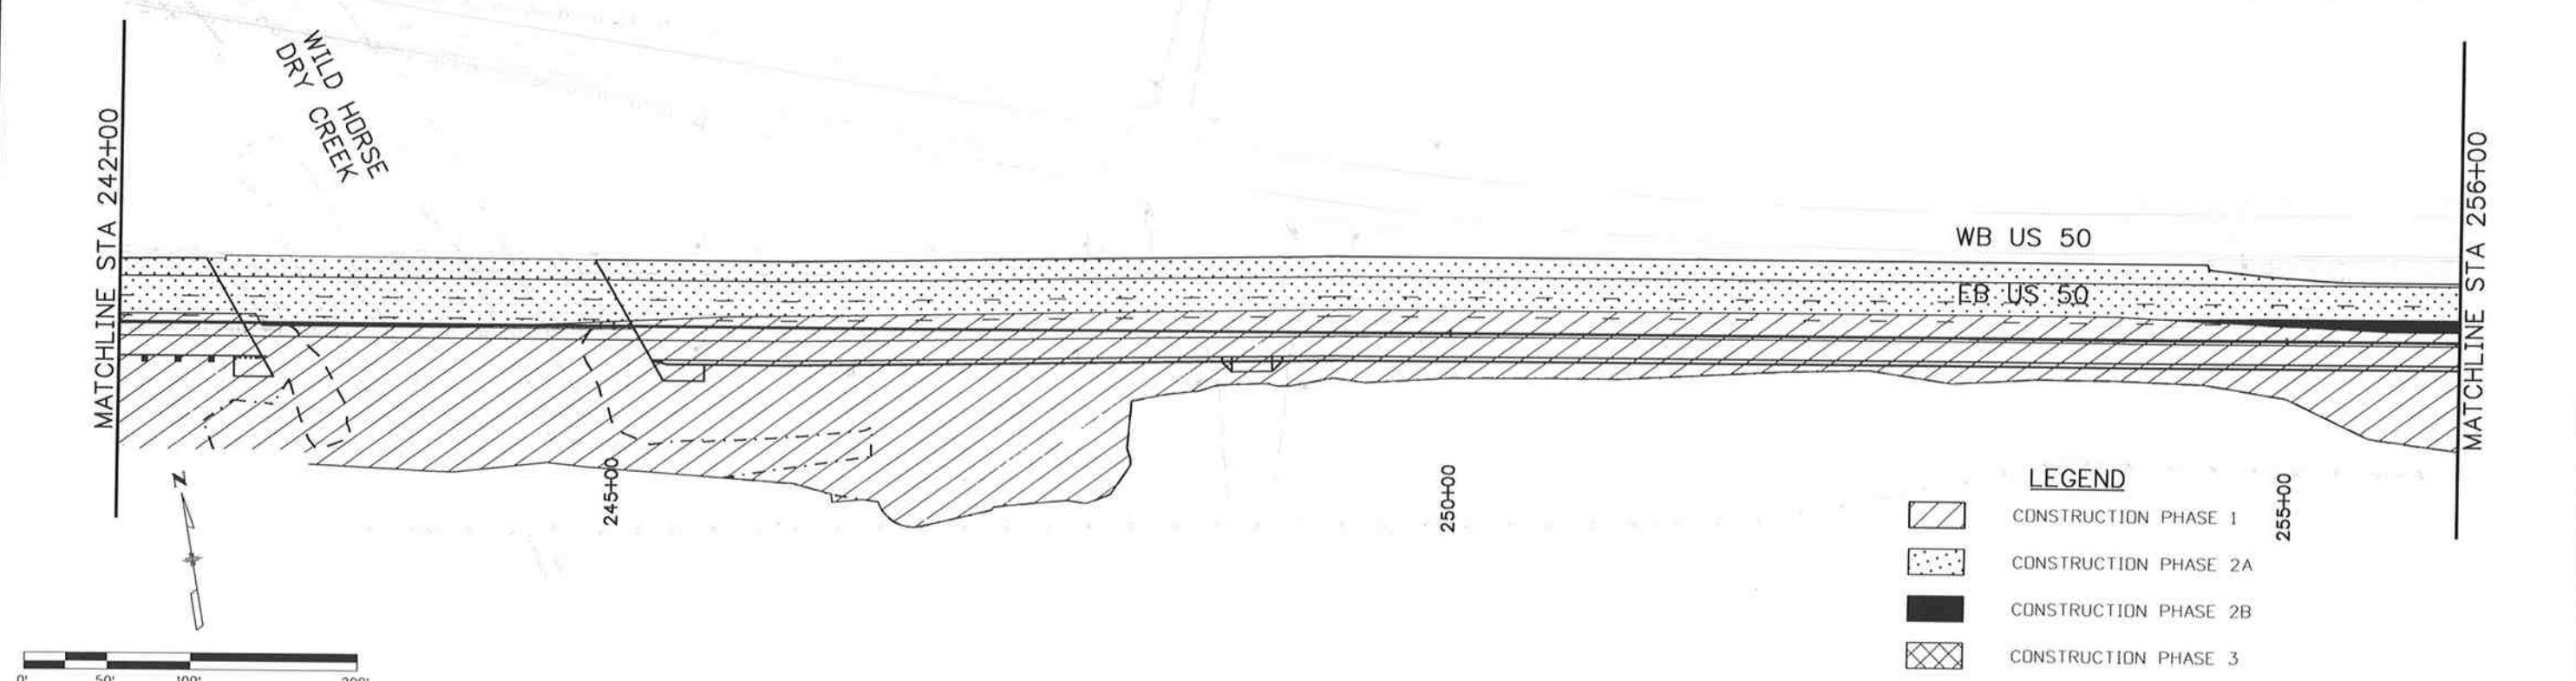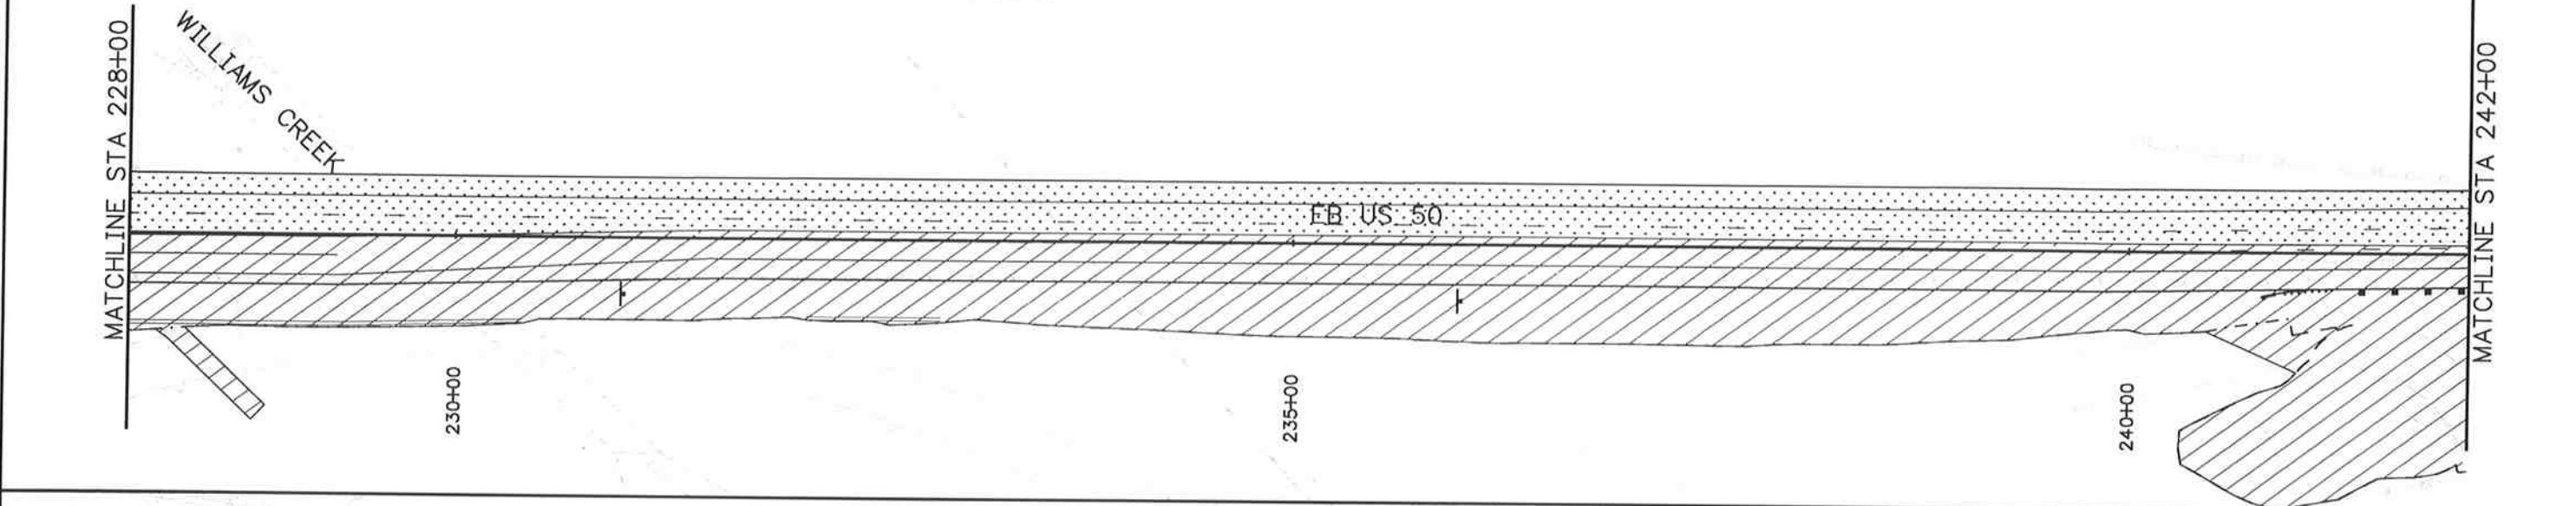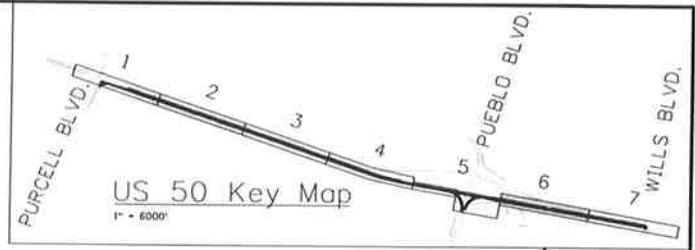

LEGEND

- CONSTRUCTION PHASE 1
- CONSTRUCTION PHASE 2A
- CONSTRUCTION PHASE 2B
- CONSTRUCTION PHASE 3
- CONSTRUCTION PHASE 4

Print Date: 10/9/2014

File Name: I9056DES_Construction Phasing_6.dgn

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**US 50 WEST
 PURCELL BLVD. TO WILLS BLVD.
 PROPOSED CONSTRUCTION PHASING**

Project No./Code

FSA 0503-081

19751

Sheet Number 243



Subset: CP Subset Sheets: CP06 of 8

DTD

Designer: AB Structure
 Detailer: AB Numbers



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LEGEND	
	CONSTRUCTION PHASE 1
	CONSTRUCTION PHASE 2A
	CONSTRUCTION PHASE 2B
	CONSTRUCTION PHASE 3
	CONSTRUCTION PHASE 4

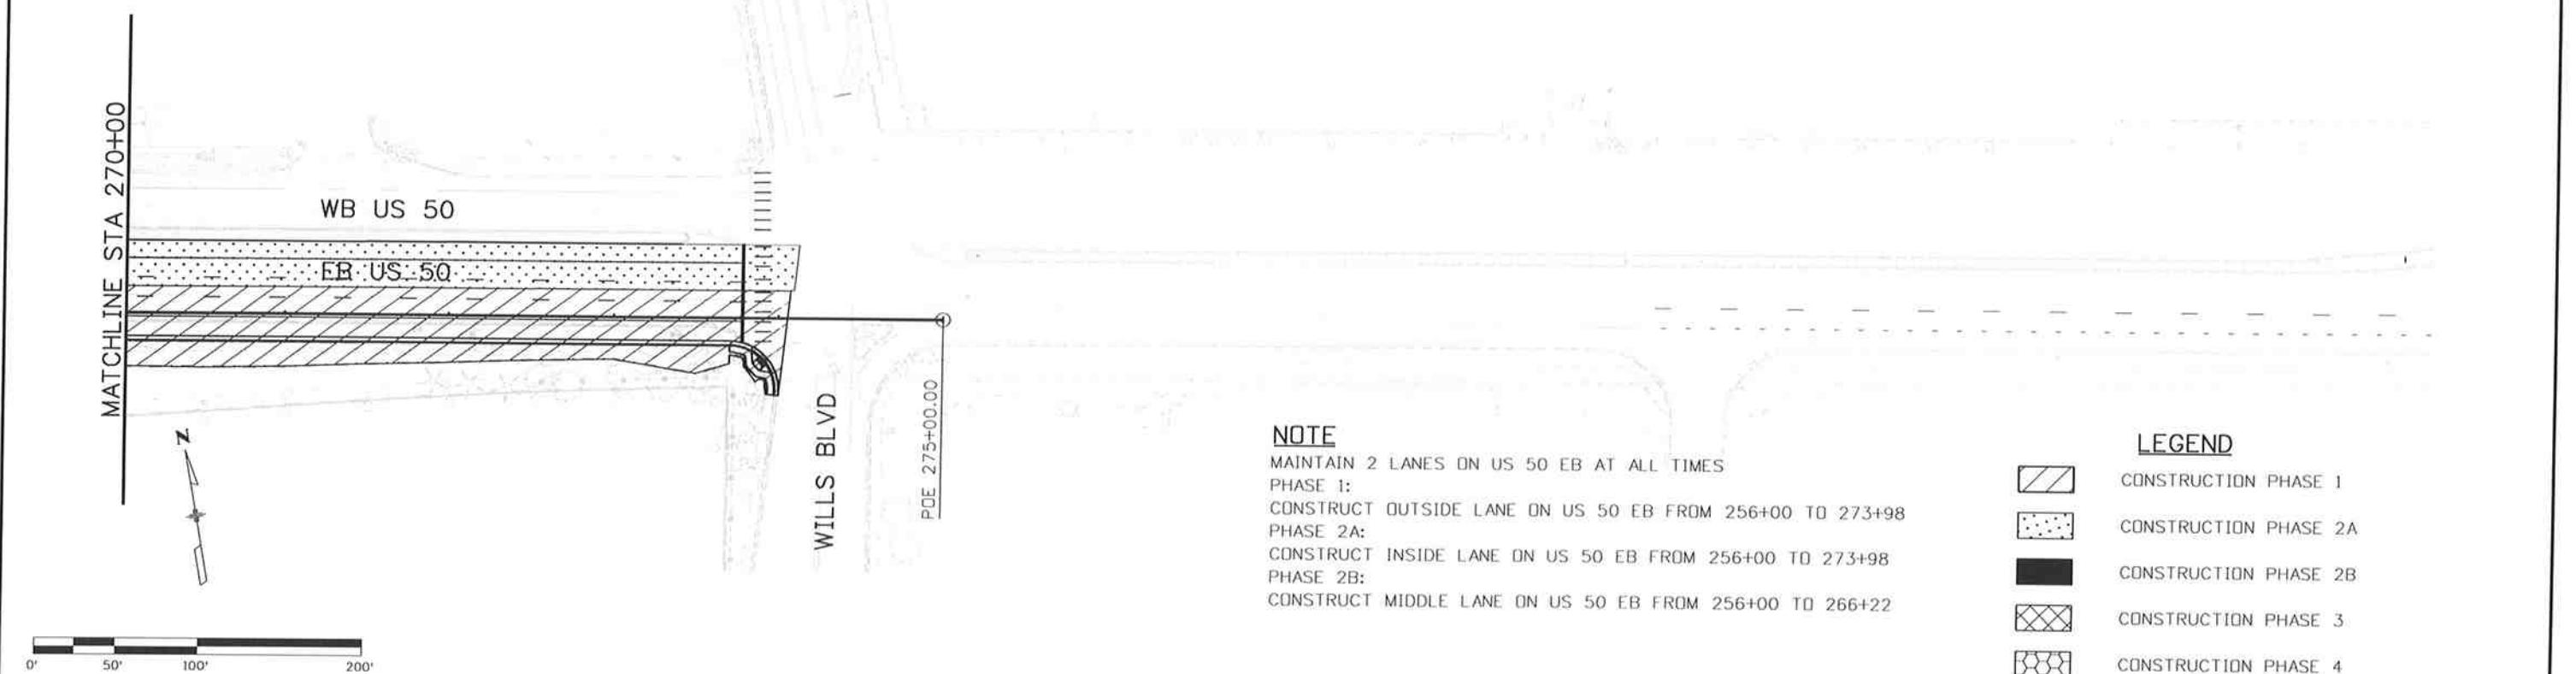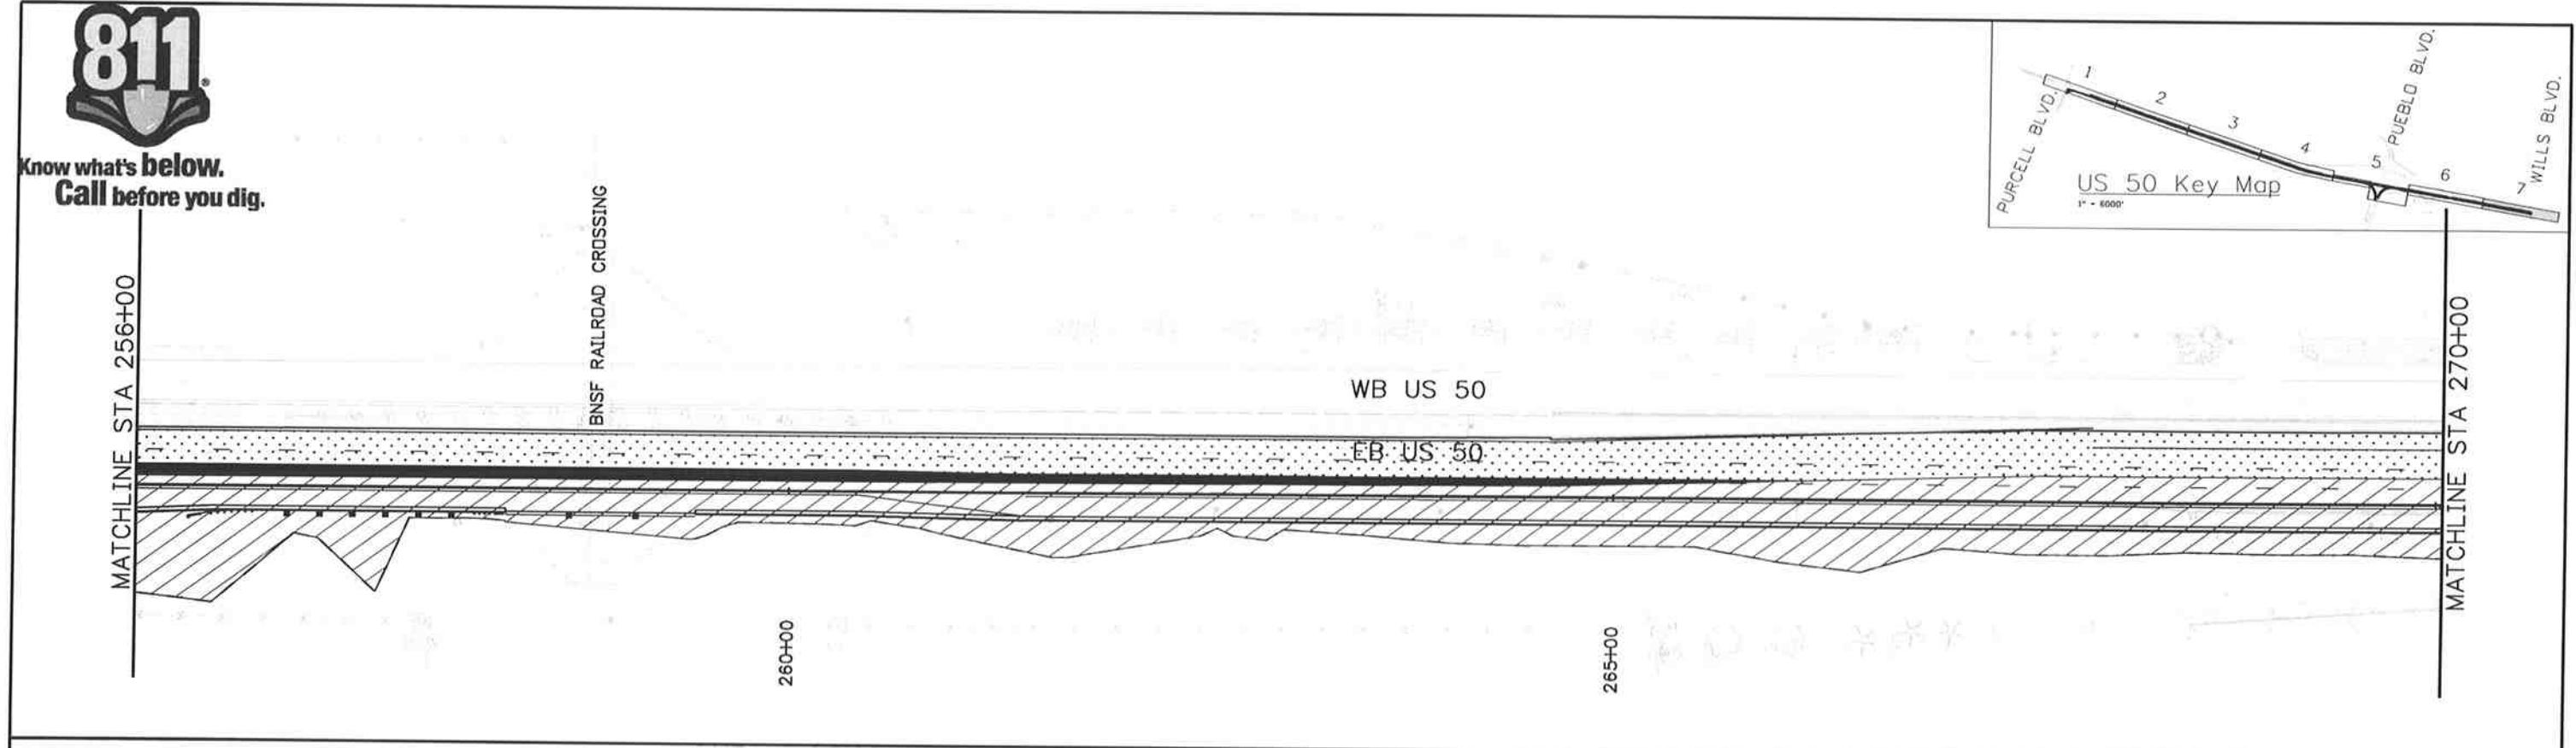Print Date: 10/9/2014

File Name: 19056DES_Construction Phasing_7.dgn

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US 50 WEST
PURCELL BLVD. TO WILLS BLVD.
PROPOSED CONSTRUCTION PHASING

Project No./Code

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19751

Sheet Number 244


Designer: AB	Structure Numbers
Drafter: AB	
Subset: CP	Subset Sheets: CP07 of 8



Know what's below.
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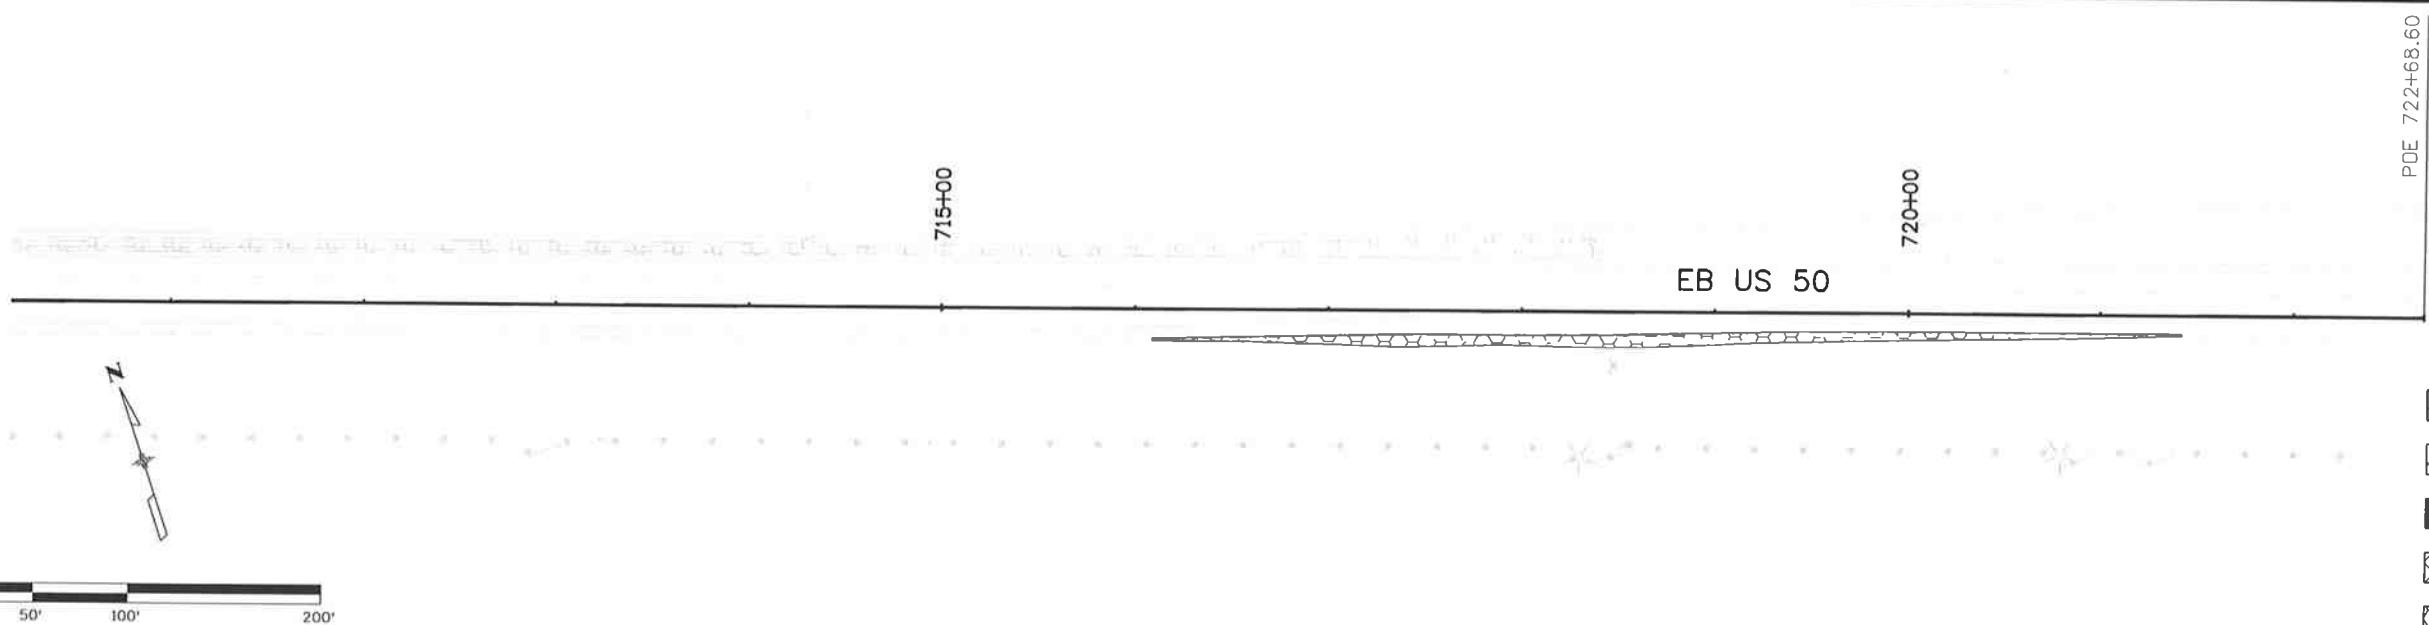
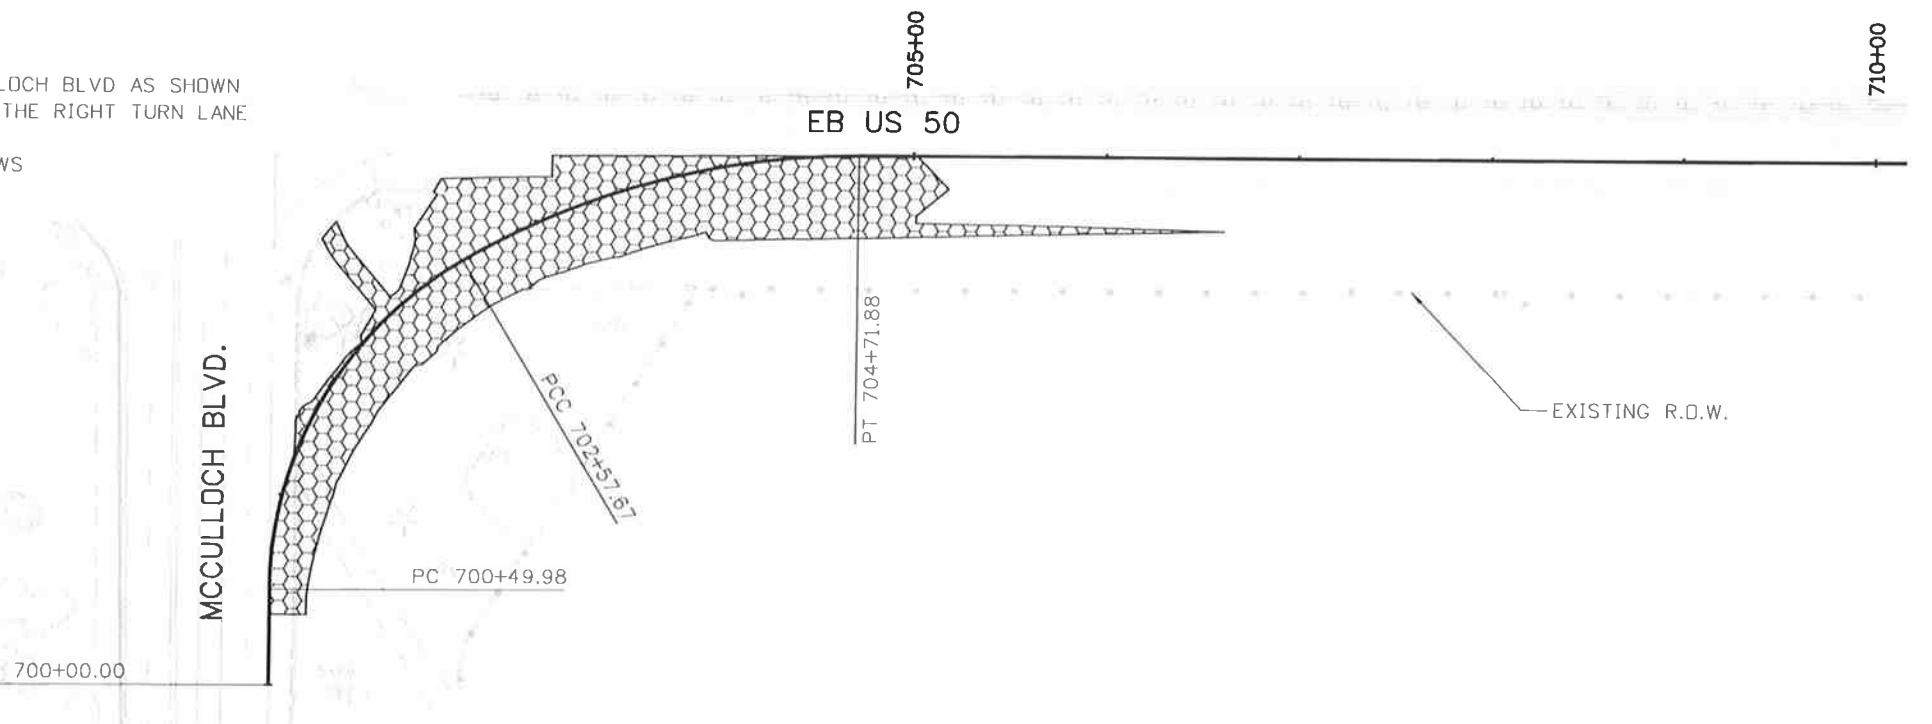
NOTE

TRAFFIC CONTROL:
MCCULLOCH BLVD TRAFFIC ON EXISTING PAVEMENT
MAINTAIN 2 LANES ON MCCULLOCH BLVD NB
LANE SHIFTS AT INTERSECTION OF US 50/MCCULLOCH BLVD
US 50 TRAFFIC ON EXISTING PAVEMENT
MAINTAIN 2 LANES ON US 50 EB
CLOSE EXISTING ACCELERATION LANE

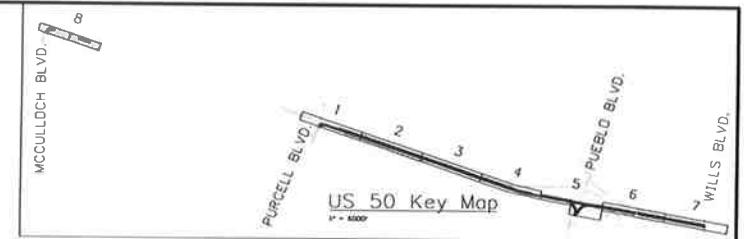

CONSTRUCTION PHASE 4:

CONSTRUCT RIGHT TURN LANE ON MCCULLOCH BLVD AS SHOWN
CONSTRUCT WATER QUALITY SWALE FOR THE RIGHT TURN LANE
CONSTRUCT CROSS PIPE AS SHOWN
MAINTAIN DRAINAGE AND IRRIGATION FLOWS
PLACE EROSION CONTROL PER THE SWMP



LEGEND

	CONSTRUCTION PHASE 1
	CONSTRUCTION PHASE 2A
	CONSTRUCTION PHASE 2B
	CONSTRUCTION PHASE 3
	CONSTRUCTION PHASE 4

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US 50 WEST MCCULLOCH BLVD. PROPOSED CONSTRUCTION PHASING

Project No./Code

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Sheet Number 245

Subset Sheets: CP08 of 8




Know what's below.
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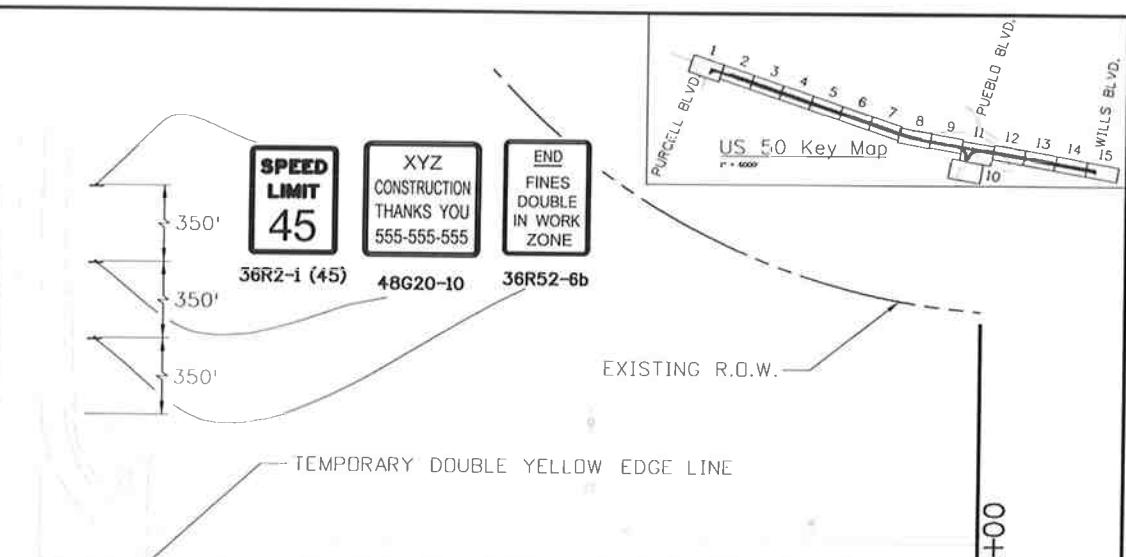
PHASE 1

TRAFFIC CONTROL:
US 50 TRAFFIC ON EXISTING PAVEMENT
MAINTAIN 2 LANES ON US 50 EB
LANE SHIFTS AT INTERSECTION OF US 50/PURCELL BLVD
MAINTAIN 2 LANES ON PURCELL BLVD NB


CONSTRUCTION:
CONSTRUCT RIGHT TURN LANE ON PURCELL BLVD AS SHOWN
CONSTRUCT OUTSIDE LANES AND WATER QUALITY SWALE FOR US 50
CONSTRUCT CROSS PIPE AS SHOWN
MAINTAIN DRAINAGE AND IRRIGATION FLOWS
PLACE EROSION CONTROL PER THE SWMP

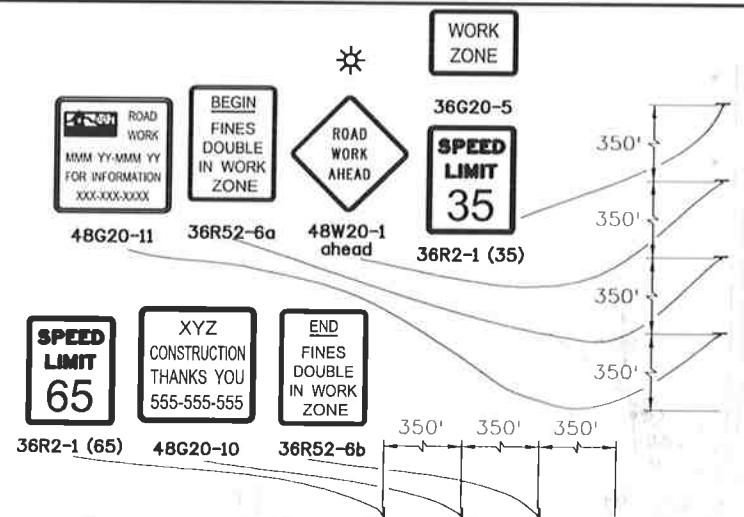


WB US 50



EXISTING R.O.W.
TEMPORARY DOUBLE YELLOW EDGE LINE

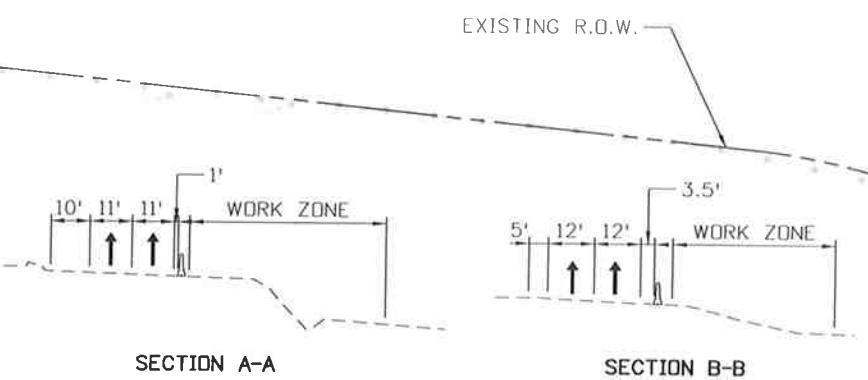

EB US 50

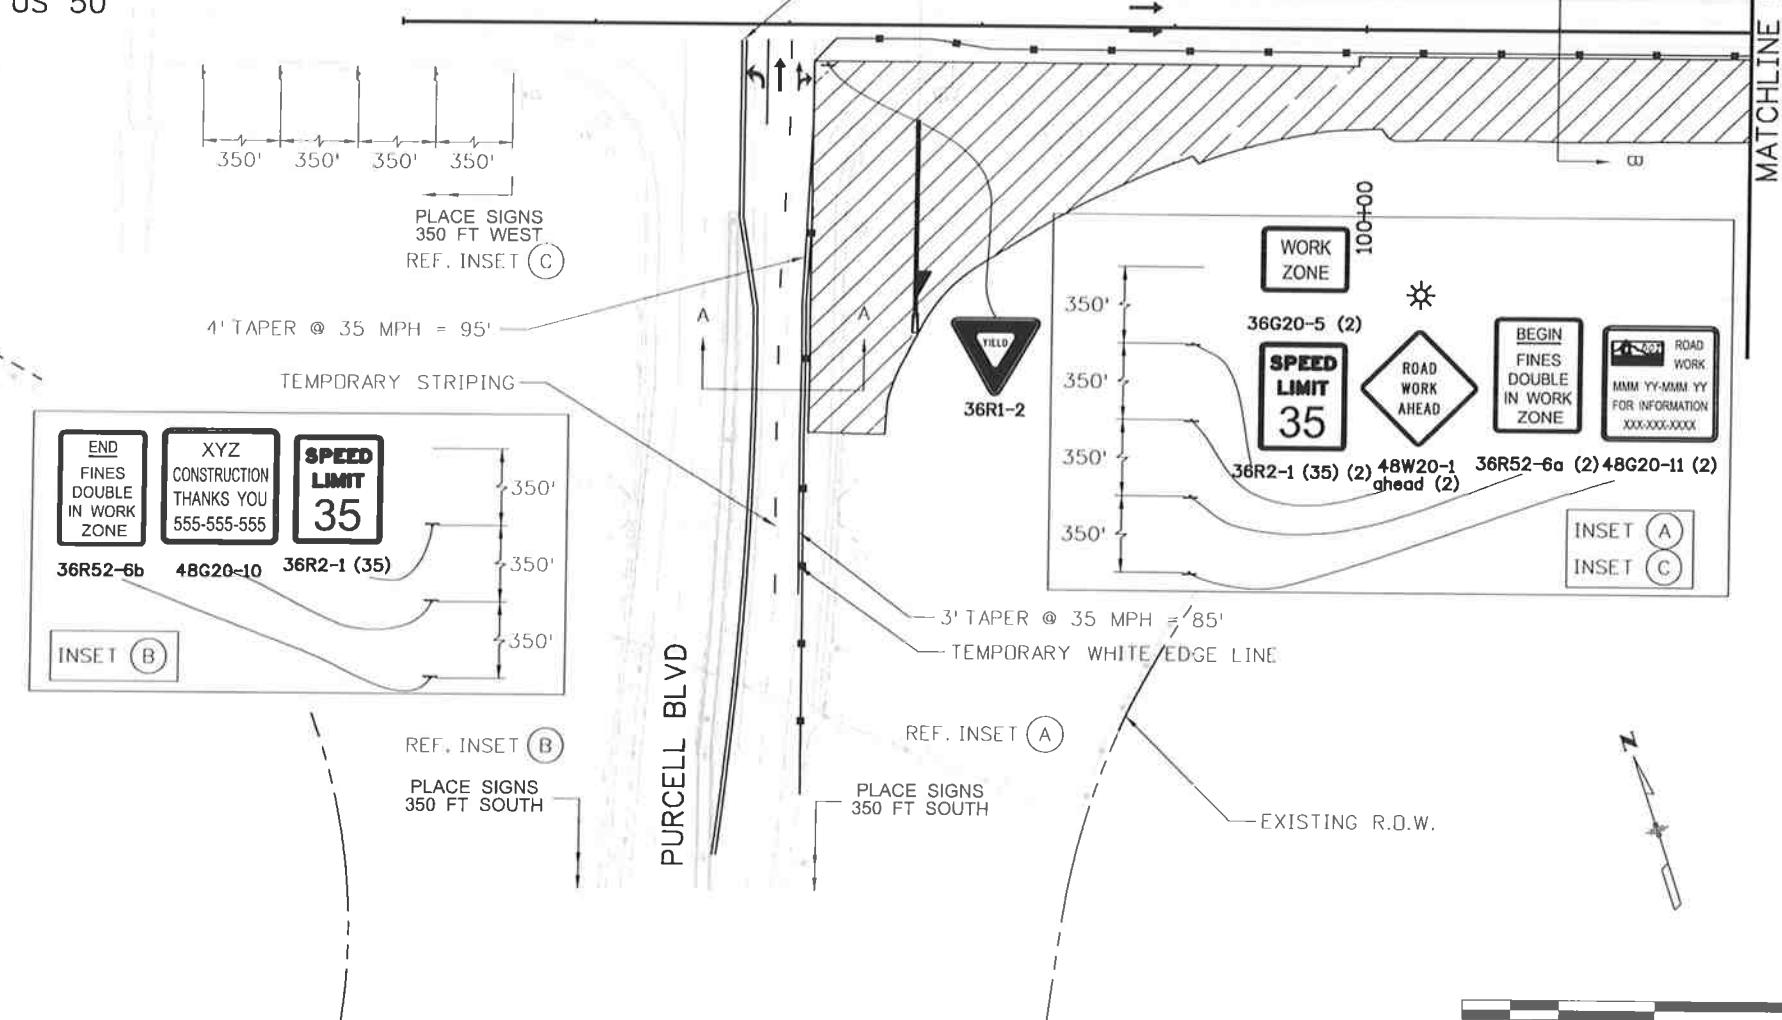

LEGEND

- ◀ TRAVEL DIRECTION
- TYPE 7 BARRIER
- ▨ CONSTRUCTION ZONE
- ▨ IMPACT ATTENUATOR
- ▨ COMPLETED CONSTRUCTION
- ▨ BARRICADE
- ▨ TEMPORARY HOT MIX ASPHALT
- ▨ DRUM CHANNELIZING DEVICE (WITH LIGHT) (FLASHING)
- ✳ FLASHING BEACON

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US 50 WEST
PURCELL BLVD. TO WILLS BLVD.
CTC - PHASE 1

Project No./Code

FSA 0503-081

19751

Sheet Number 246

0' 50' 100' 200'
Subset Sheets: CT01 of 33





Know what's below.
Call before you dig.

PHASE 1

TRAFFIC CONTROL:
US 50 TRAFFIC ON EXISTING PAVEMENT
MAINTAIN 2 LANES ON US 50 EB

CONSTRUCTION:

CONSTRUCT OUTSIDE LANES AND WATER QUALITY SWALE FOR US 50
MAINTAIN DRAINAGE AND IRRIGATION FLOWS
PLACE EROSION CONTROL PER THE SWMP
OFFSITE GRADING, WITHIN TE SHOWN, TO ENSURE DRAINAGE

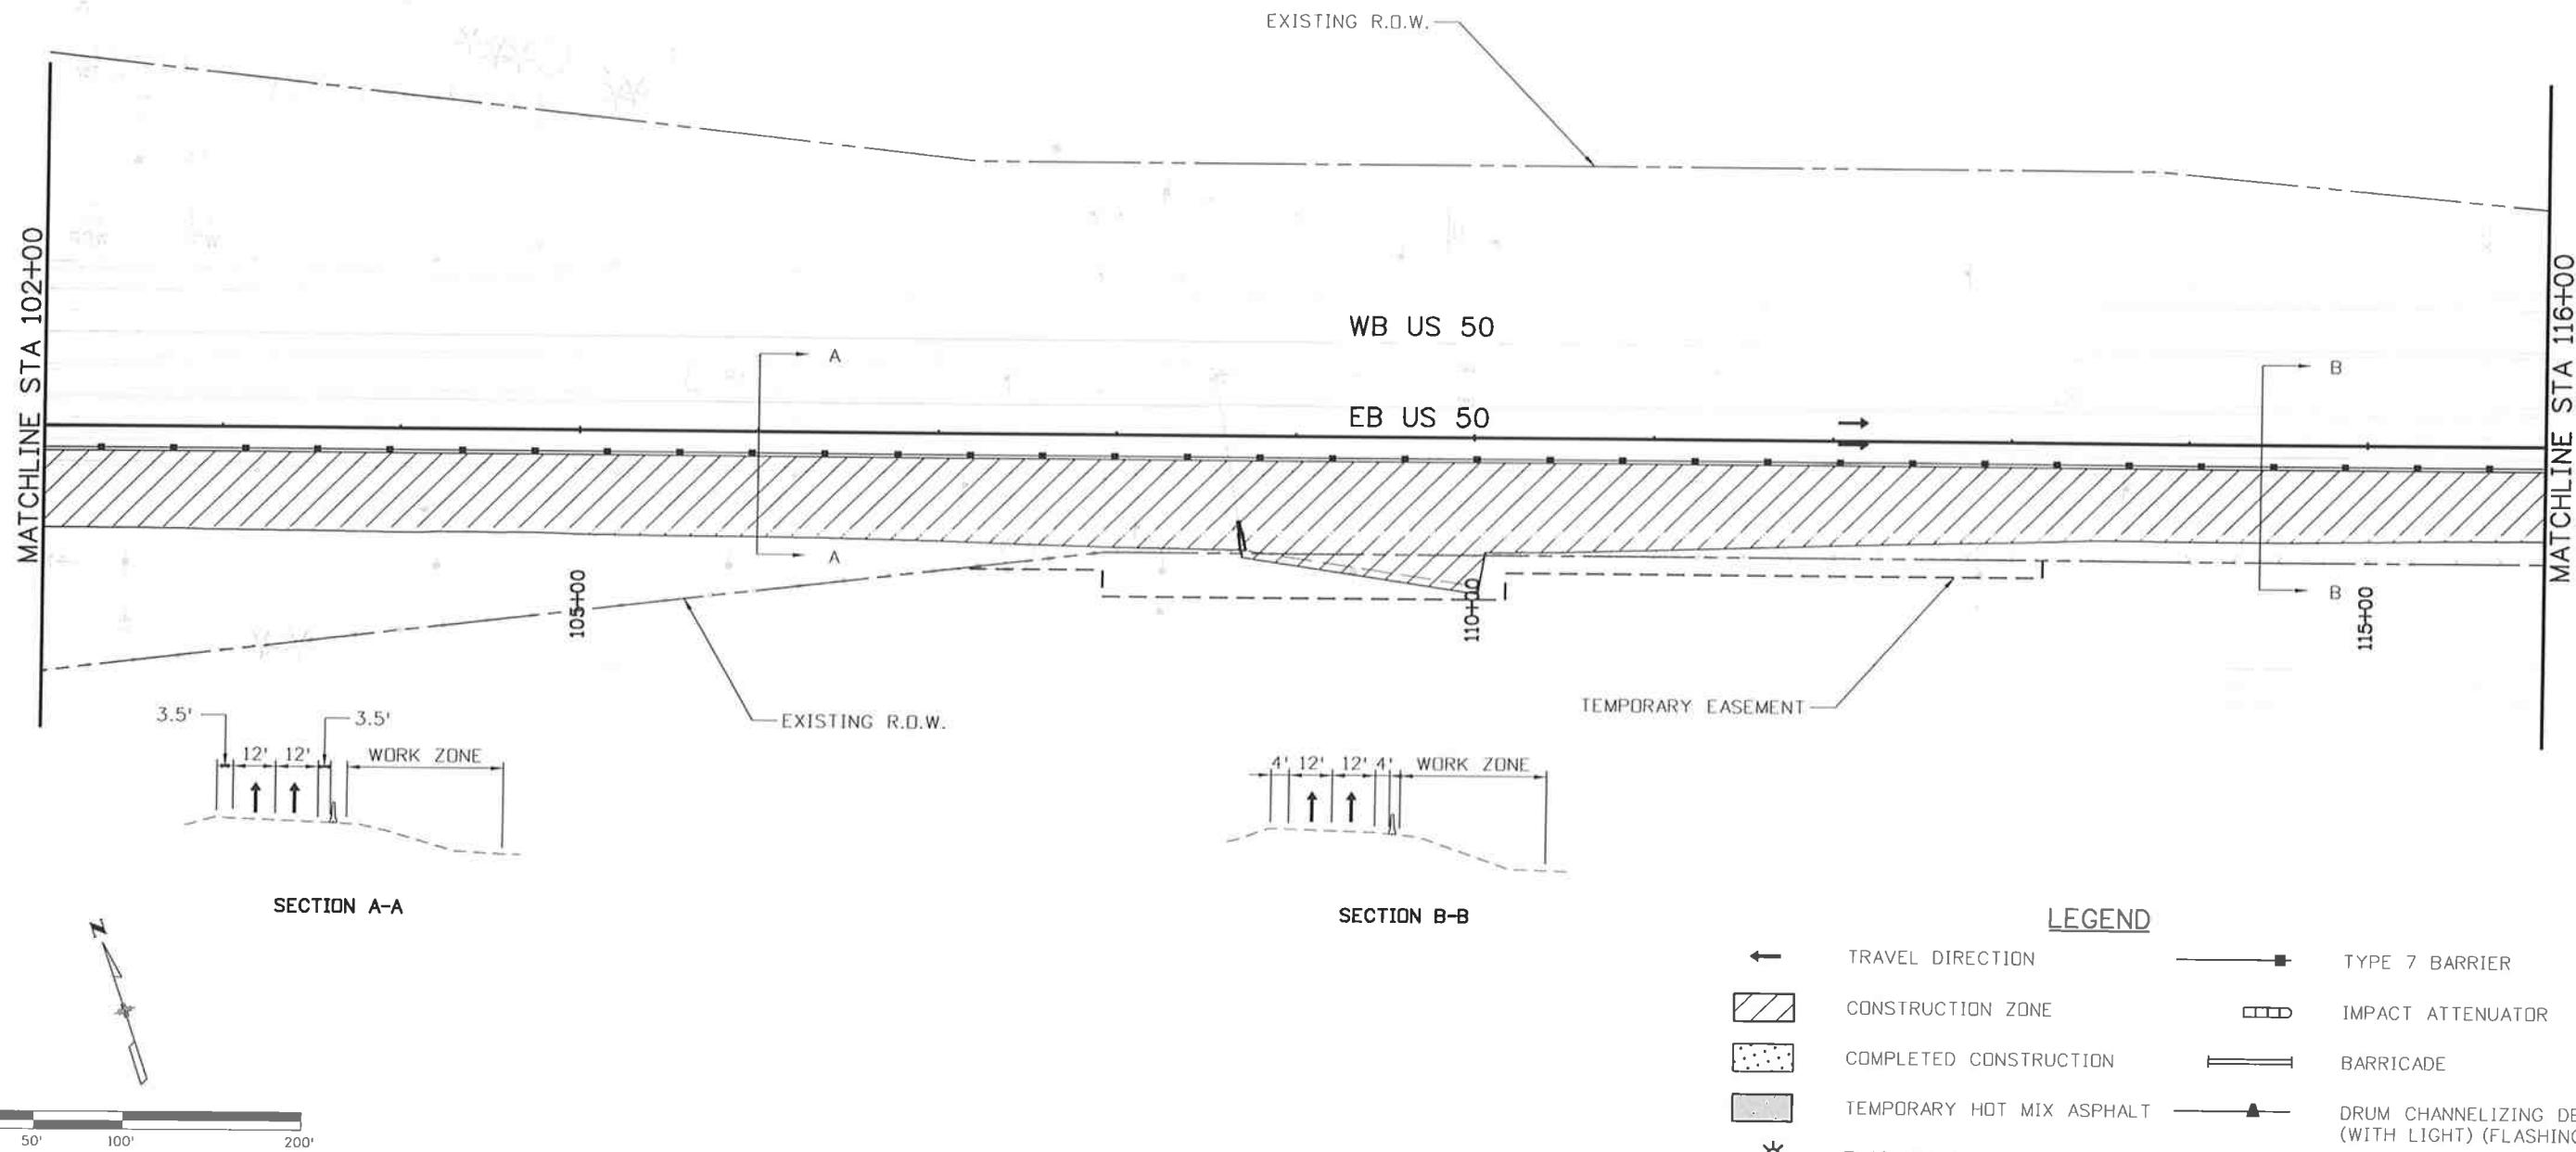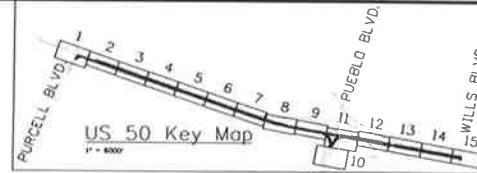

Print Date: 10/9/2014

File Name: 19056DES_Construction Phasing_2.dgn

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Vert. Scale: As Noted



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US 50 WEST
PURCELL BLVD. TO WILLS BLVD.
CTC - PHASE 1

Project No./Code

FSA 0503-081

19751

Sheet Number 247





**Know what's below.
Call before you dig.**

PHASE 1

TRAFFIC CONTROL:
US 50 TRAFFIC ON EXISTING PAVEMENT
MAINTAIN 2 LANES ON US 50 EB

CONSTRUCTION:

CONSTRUCT OUTSIDE LANES AND WATER QUALITY SWALE FOR US 50
CONSTRUCT CROSS PIPE AS SHOWN
OFFSITE GRADING, WITHIN TE SHOWN, TO ENSURE DRAINAGE
MAINTAIN DRAINAGE AND IRRIGATION FLOWS
PLACE EROSION CONTROL PER THE SWMP
PROTECT EXISTING MONUMENT AS SHOWN

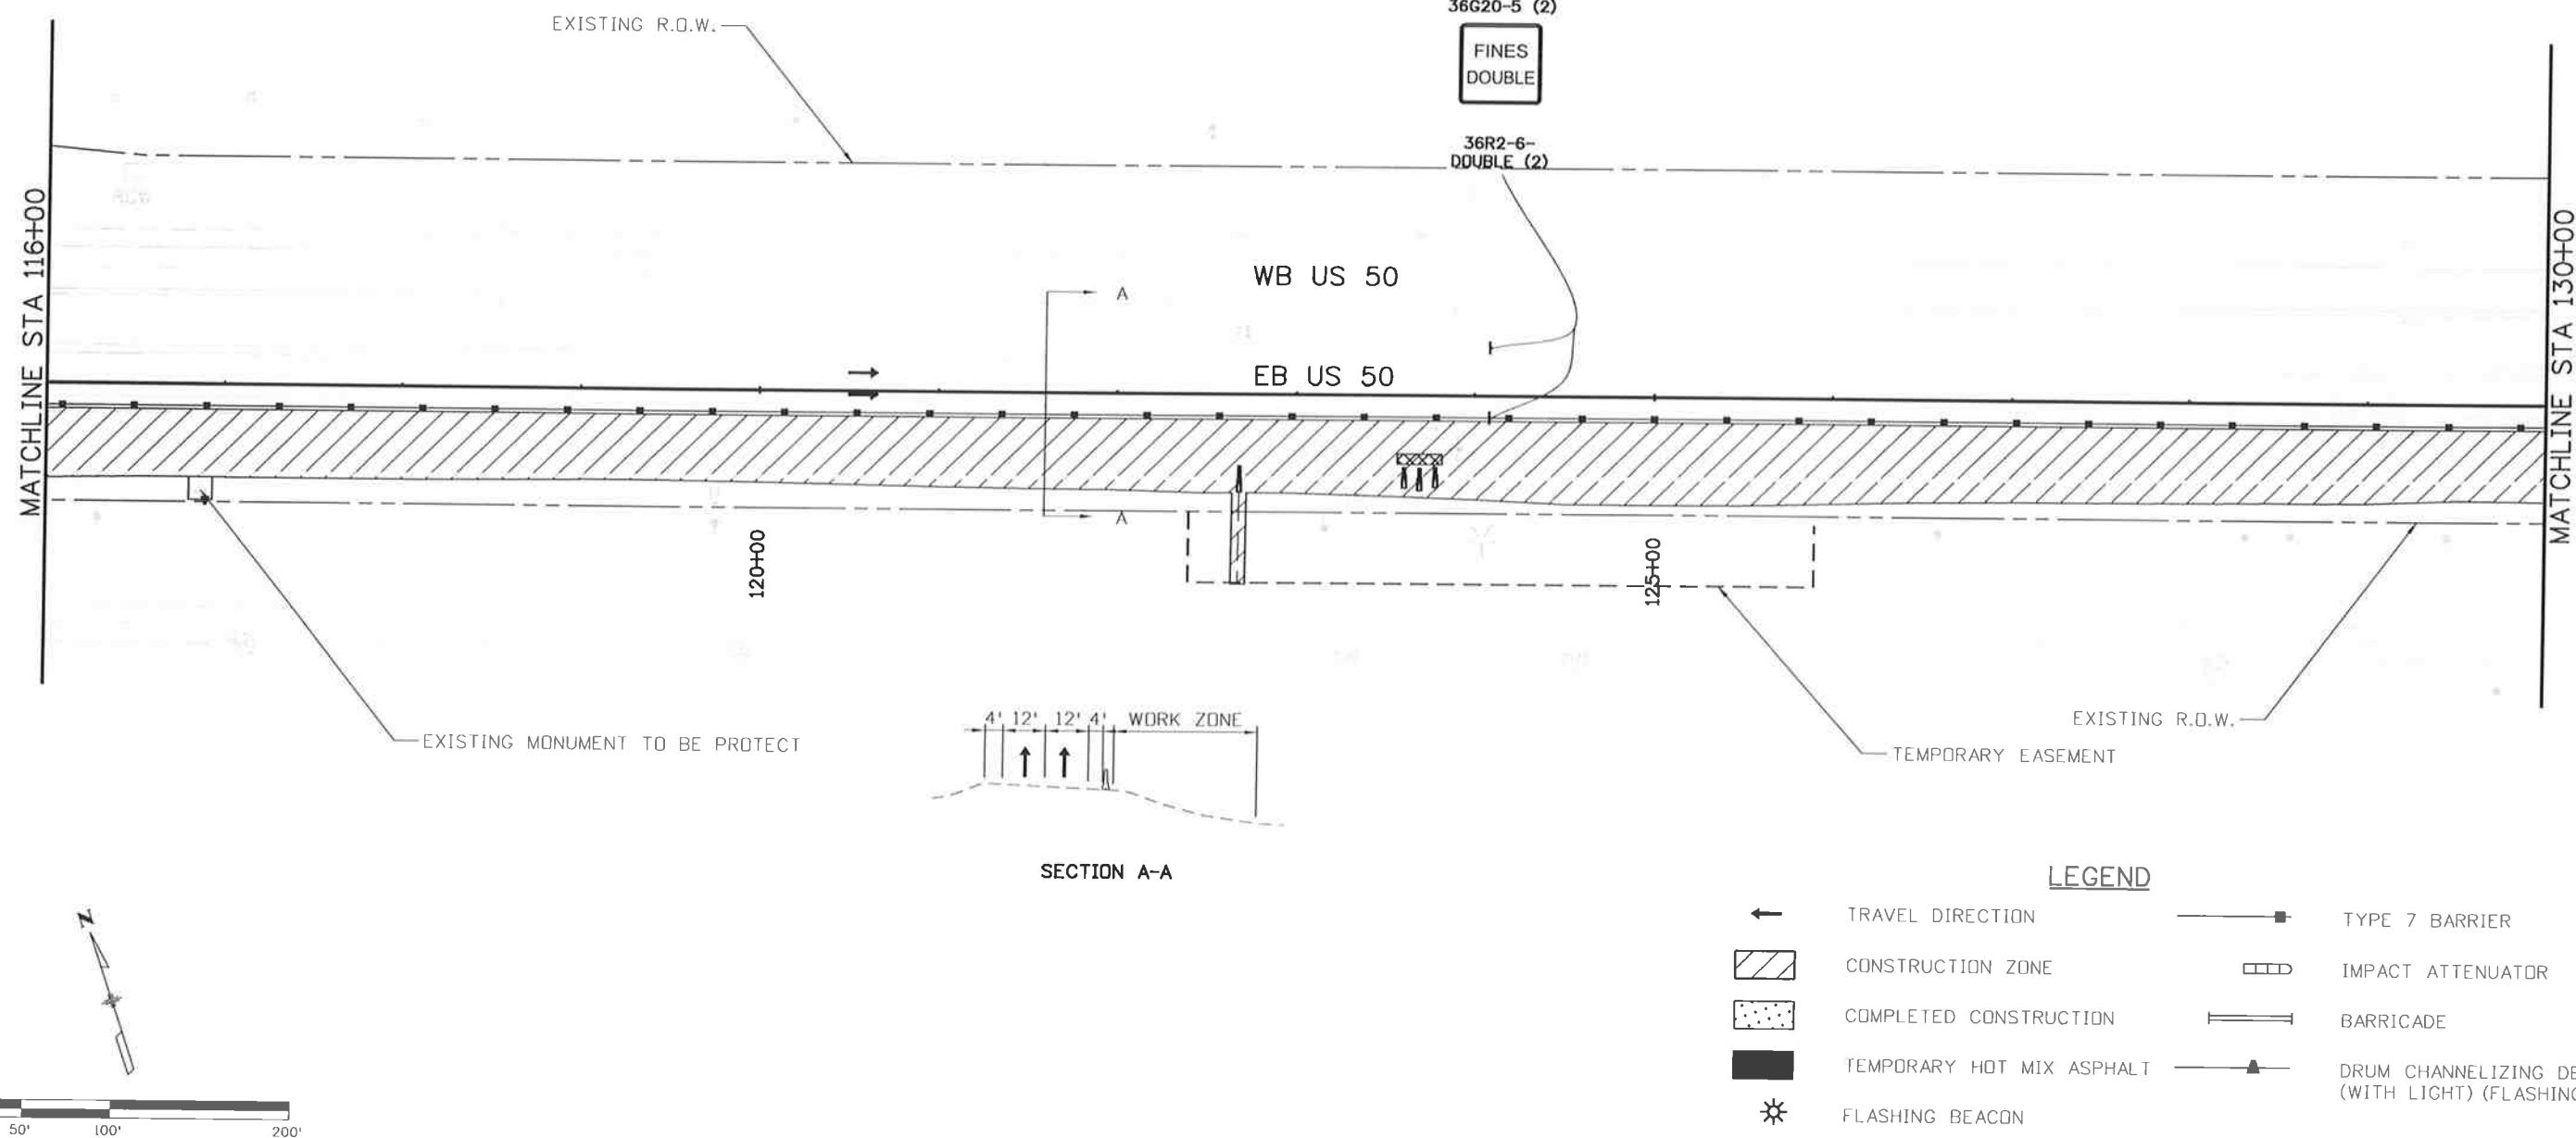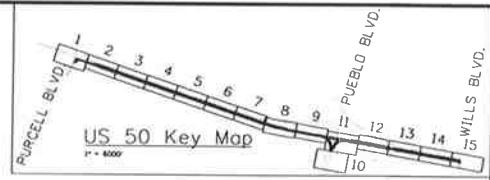

Print Date: 10/9/2014

File Name: 19056DES_Construction Phasing1_3.dgn

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U.S. 50 WEST
PURCELL BLVD. TO WILLS BLVD.
CTC - PHASE 1

Project No./Code

FSA 0503-081

19751

Sheet Number 248

Designer:	AB	Structure
Detailer:	AB	Numbers
Subset:	CT	Subset Sheets: CTO3 of 33





Know what's below.
Call before you dig.

PHASE 1

TRAFFIC CONTROL:
US 50 TRAFFIC ON EXISTING PAVEMENT
MAINTAIN 2 LANES ON US 50 EB

CONSTRUCTION:

CONSTRUCT OUTSIDE LANES AND WATER QUALITY SWALE FOR US 50
CONSTRUCT CROSS PIPE HEADWALL AS SHOWN
OFFSITE GRADING, WITHIN TE SHOWN, TO ENSURE DRAINAGE
MAINTAIN DRAINAGE AND IRRIGATION FLOWS
PLACE EROSION CONTROL PER THE SWMP

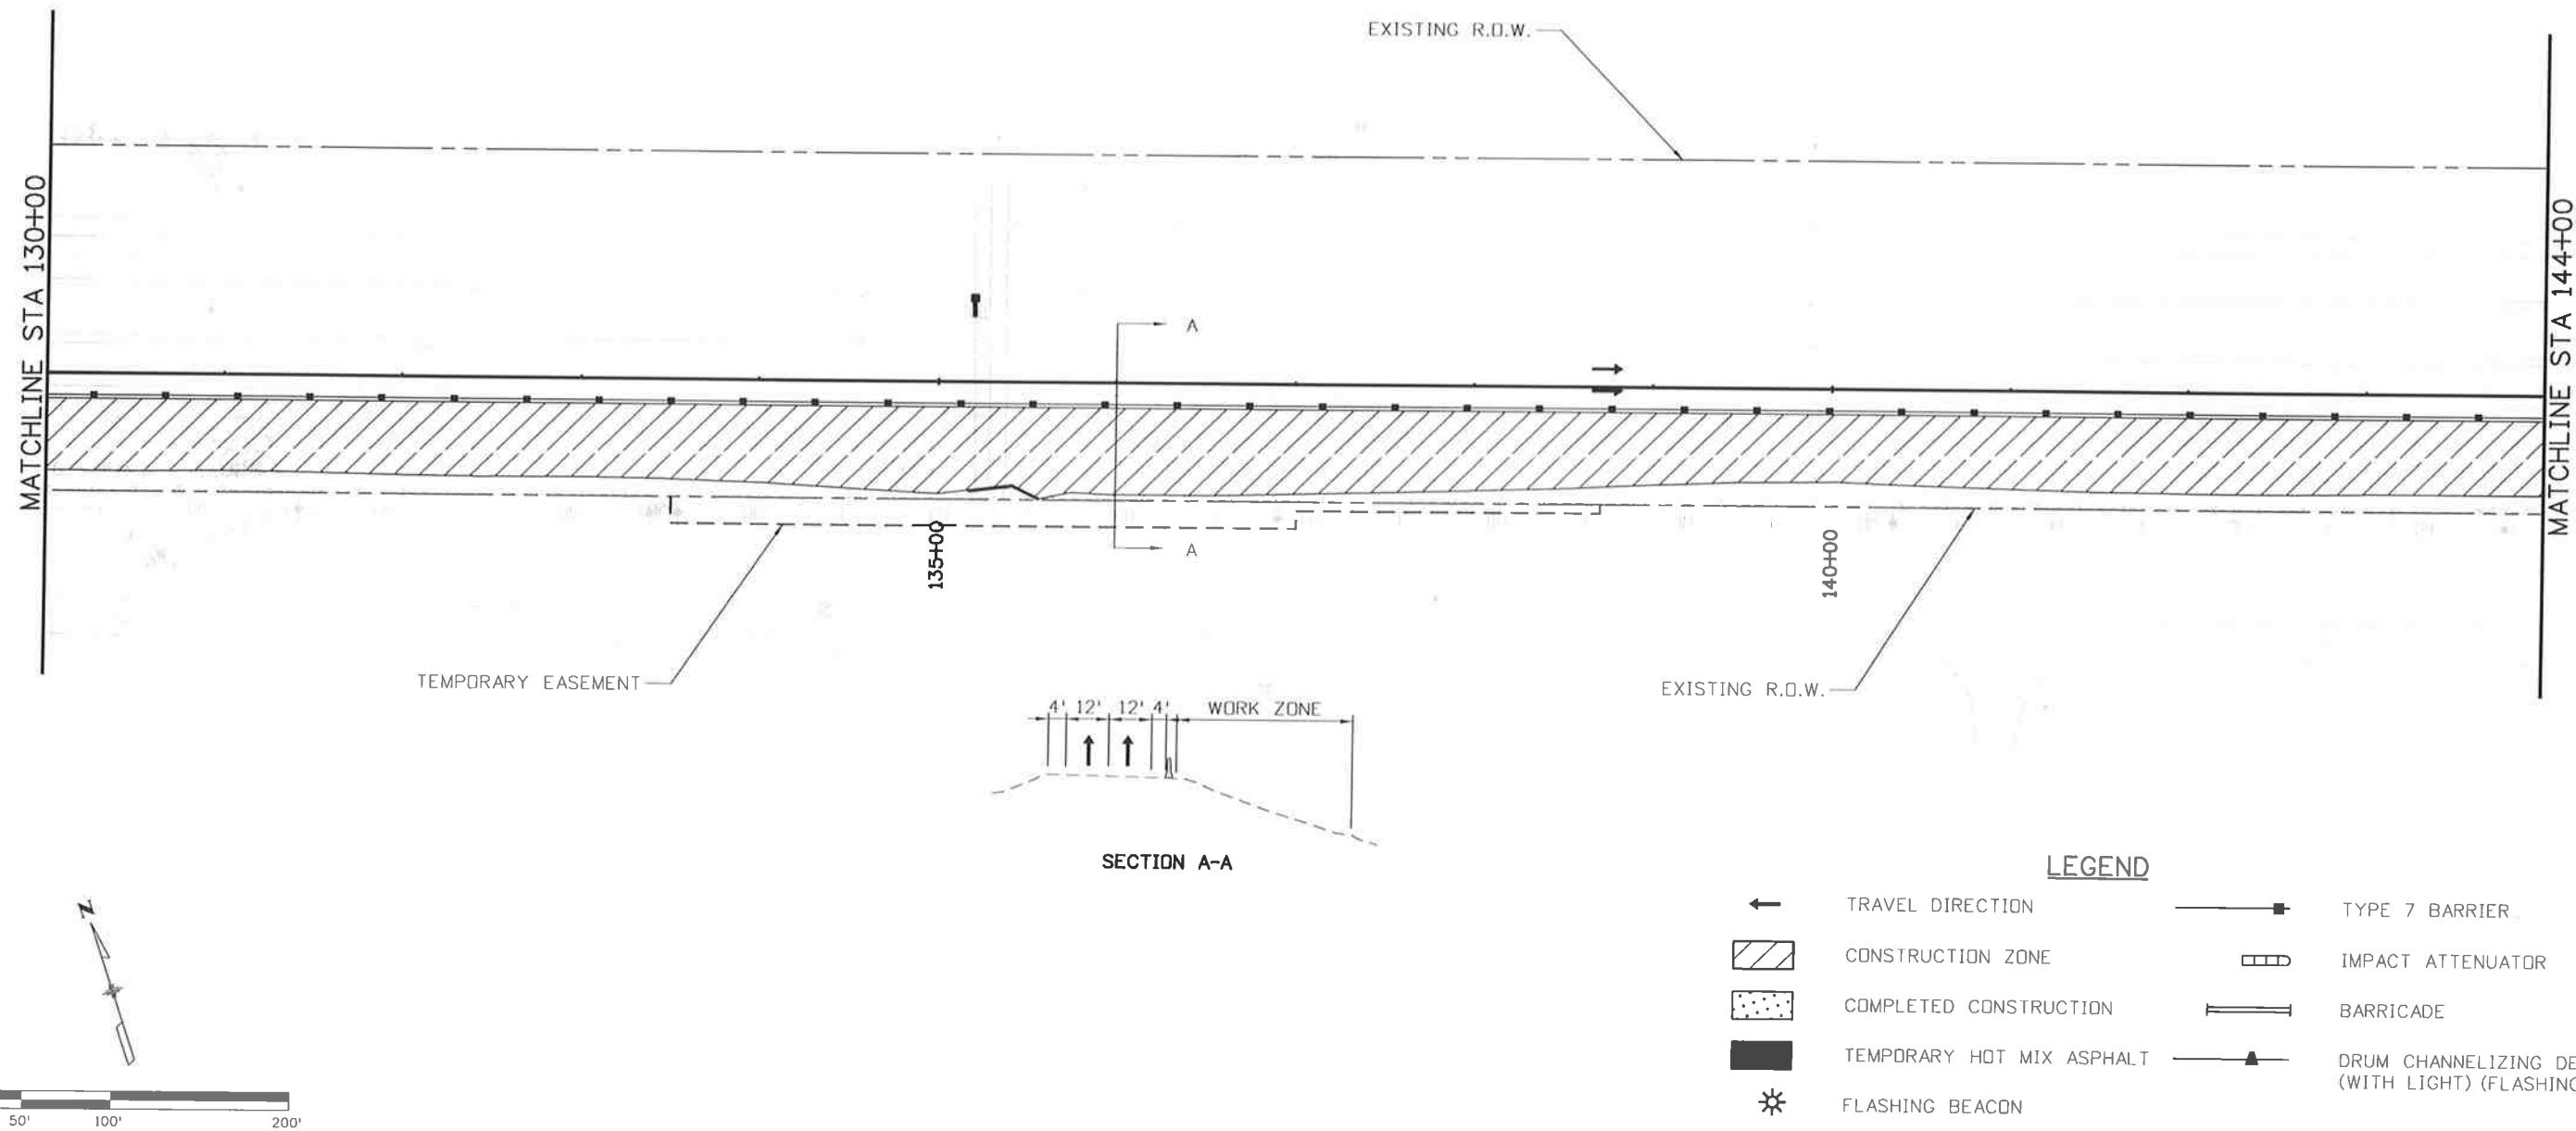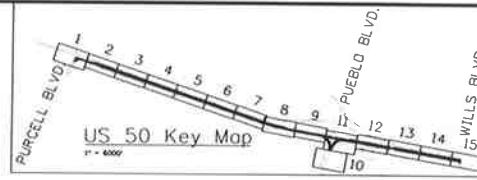

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US 50 WEST
PURCELL BLVD. TO WILLS BLVD.
CTC - PHASE 1

Project No./Code

FSA 0503-081

19751

Sheet Number 249




Know what's below.
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PHASE 1

TRAFFIC CONTROL:
US 50 TRAFFIC ON EXISTING PAVEMENT
MAINTAIN 2 LANES ON US 50 EB

CONSTRUCTION:


CONSTRUCT OUTSIDE LANES AND WATER QUALITY SWALE FOR US 50
CONSTRUCT CROSS PIPE AS SHOWN
OFFSITE GRADING, WITHIN TE SHOWN, TO ENSURE DRAINAGE
MAINTAIN DRAINAGE AND IRRIGATION FLOWS
PLACE EROSION CONTROL PER THE SWMP

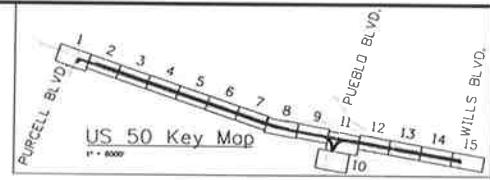

36G20-5 (2)



36R2-1 (35) (2)

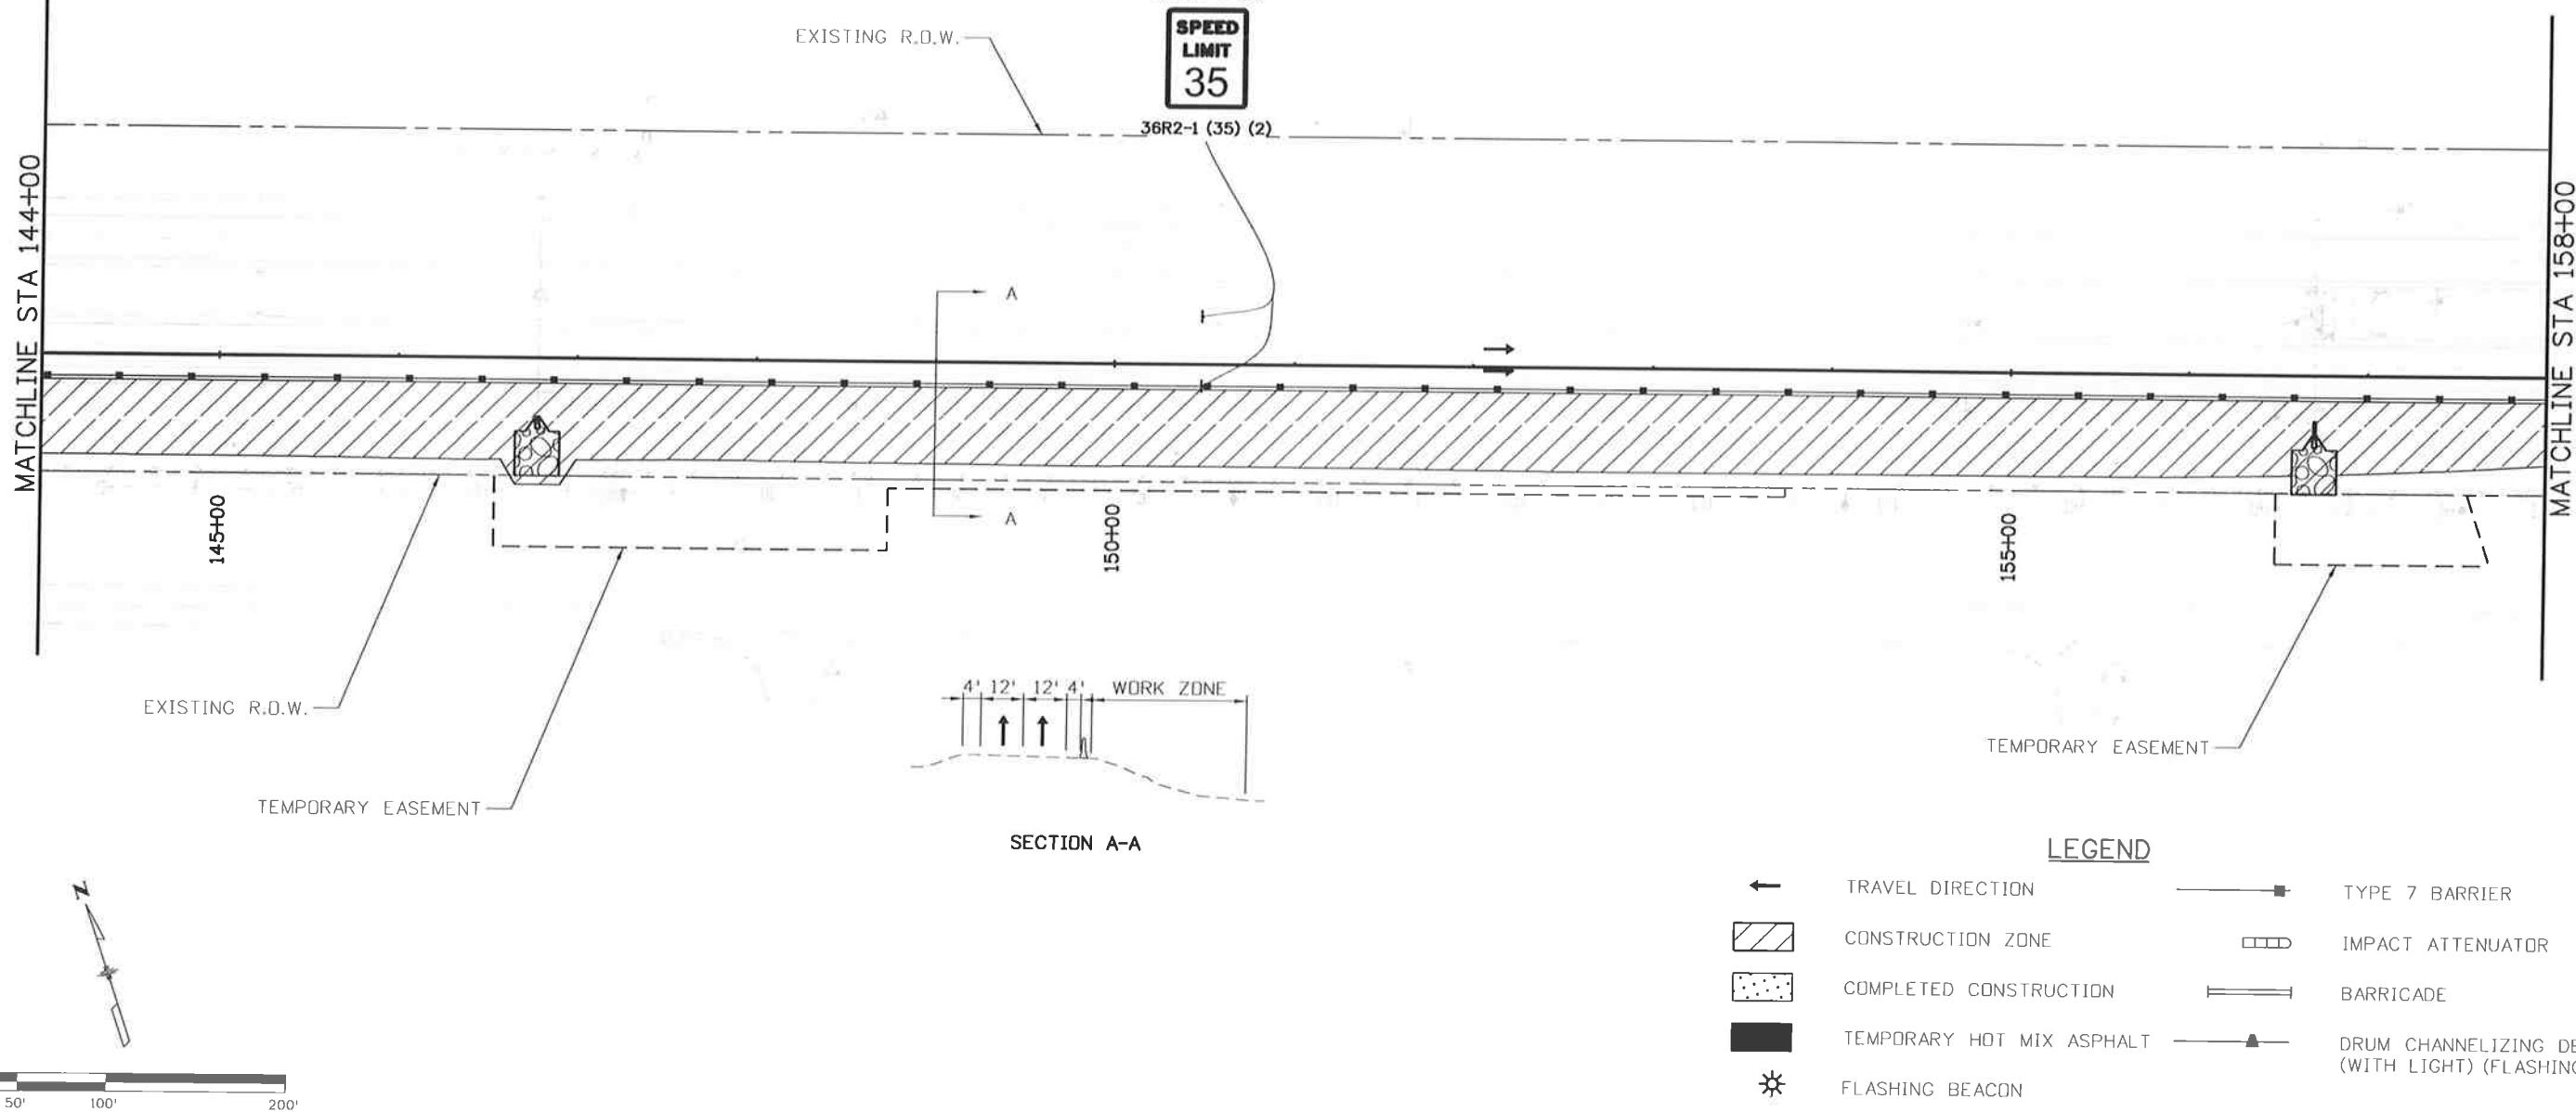

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US 50 WEST
PURCELL BLVD. TO WILLS BLVD.
CTC - PHASE 1

Project No./Code

FSA 0503-081

19751

Designer:	AB	Structure
Detailer:	AB	Numbers
Subset:	CT	Subset Sheets: CT05 of 33

Sheet Number 250





Know what's below.
Call before you dig.

PHASE 1

TRAFFIC CONTROL:
US 50 TRAFFIC ON EXISTING PAVEMENT
MAINTAIN 2 LANES ON US 50 EB

CONSTRUCTION:

CONSTRUCT OUTSIDE LANES AND WATER QUALITY SWALE FOR US 50
CONSTRUCT CROSS PIPED AS SHOWN
MAINTAIN DRAINAGE AND IRRIGATION FLOWS
PLACE EROSION CONTROL PER THE SWMP

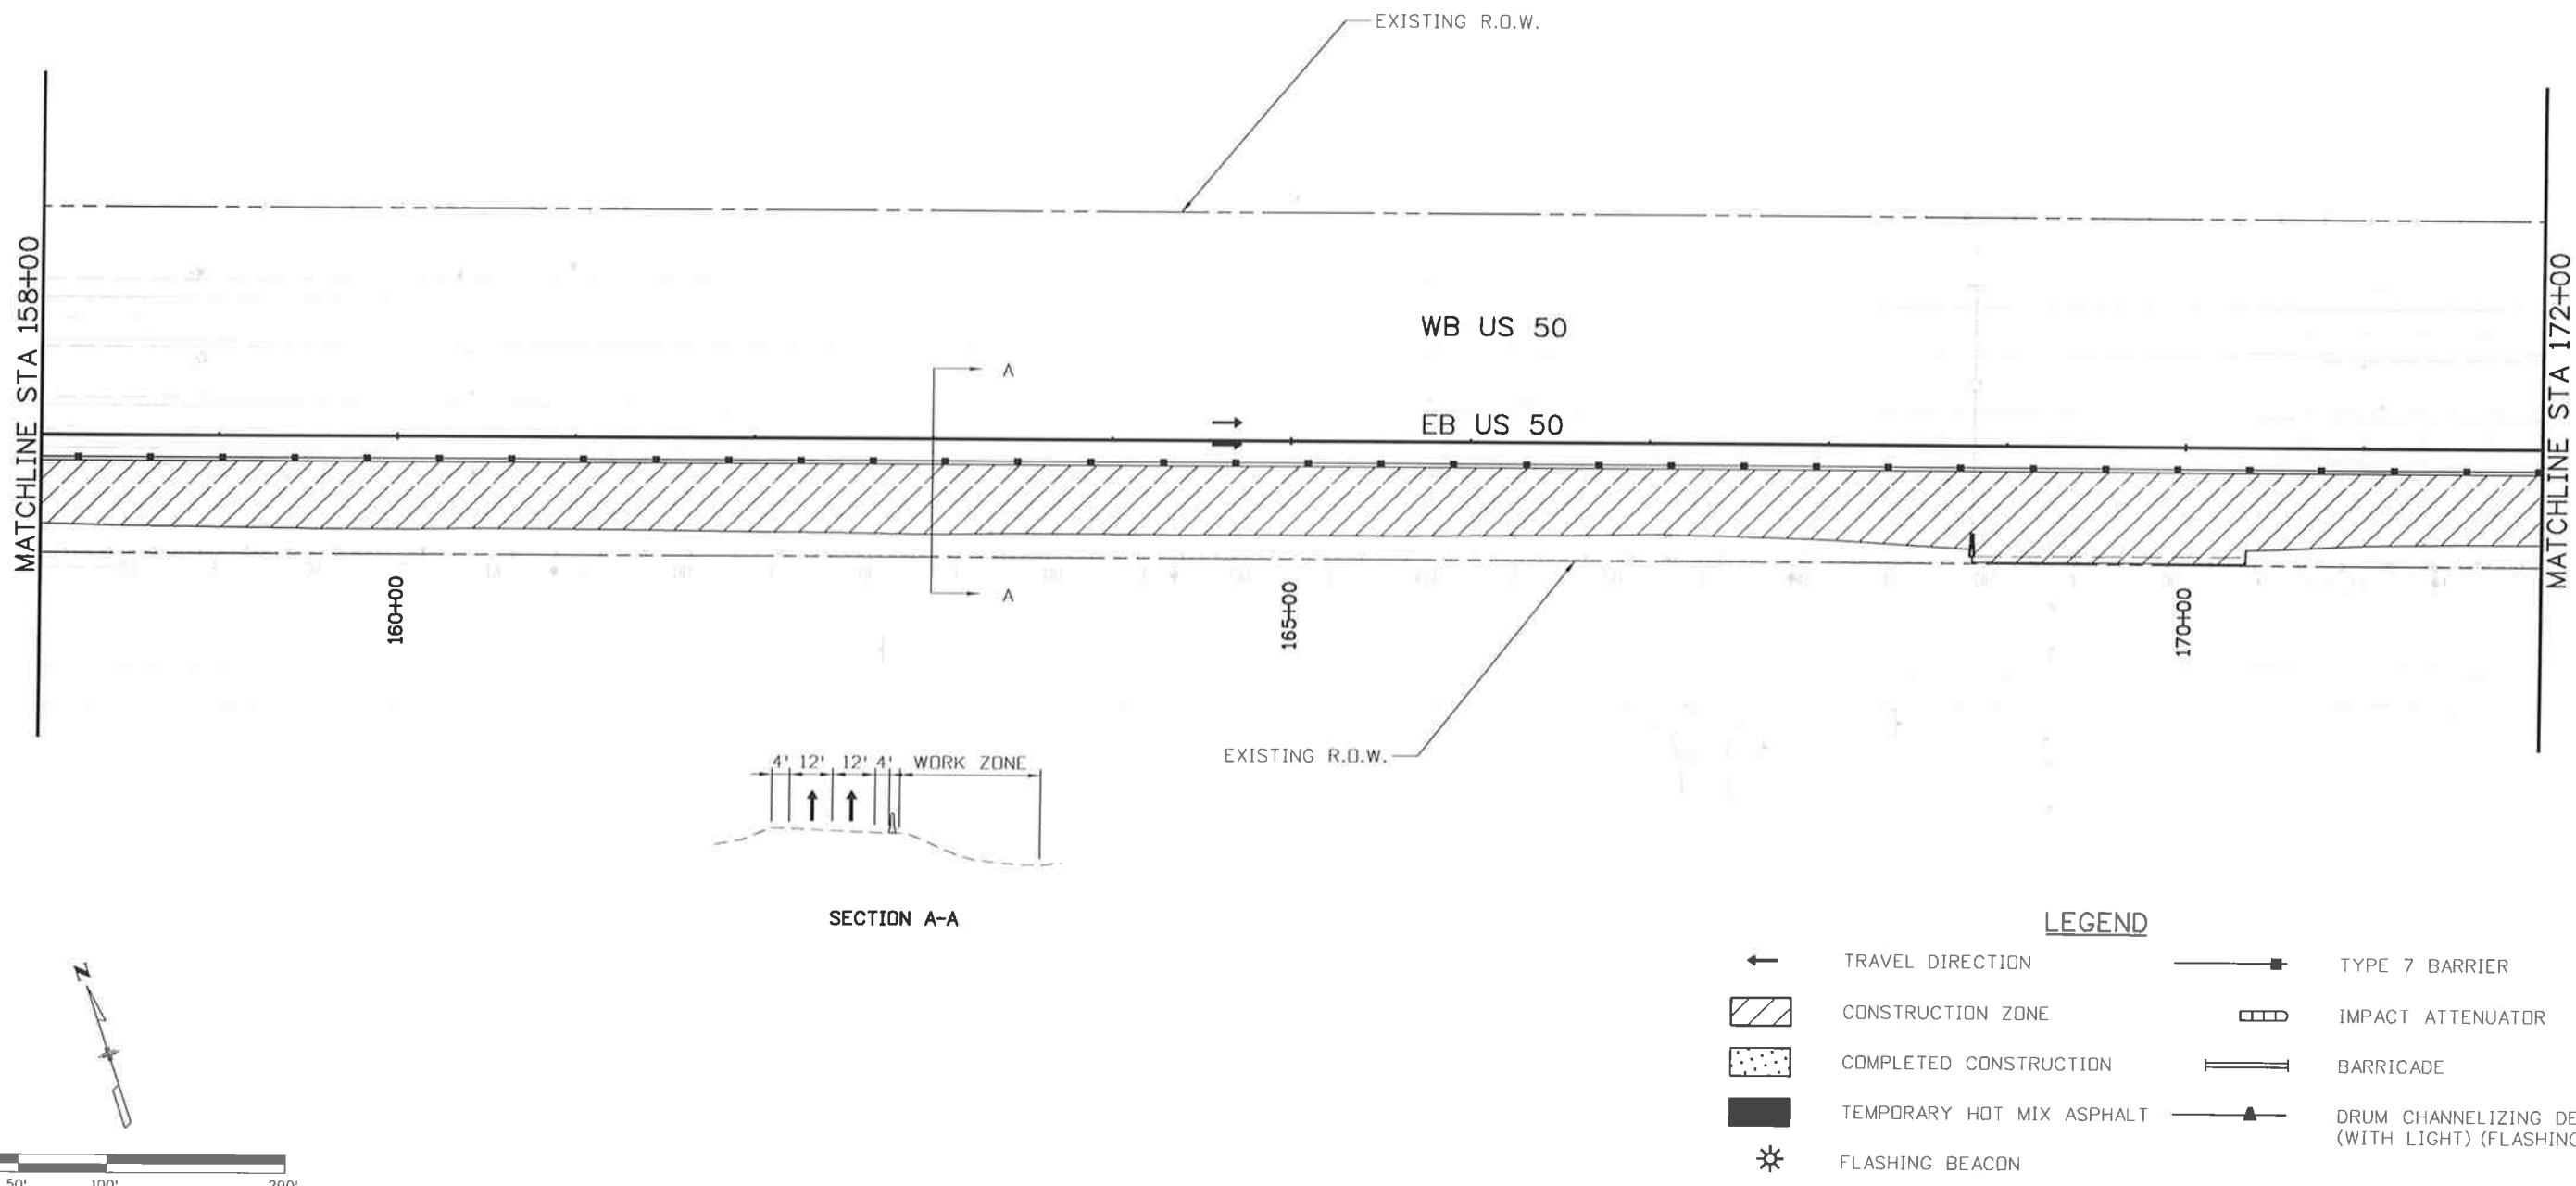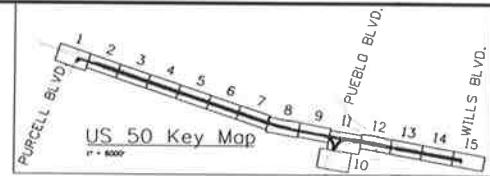

Print Date: 10/9/2014

File Name: 19056DES_Construction Phasing1_6.dgn

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Void:

US 50 WEST
PURCELL BLVD. TO WILLS BLVD.
CTC - PHASE 1

Project No./Code
FSA 0503-081
19751
Sheet Number 251

Designer: AB Structure Numbers
Detailer: AB
Subset: CT Subset Sheets: CT06 of 33




**Know what's below.
Call before you dig.**

PHASE 1


TRAFFIC CONTROL:
US 50 TRAFFIC ON EXISTING PAVEMENT
MAINTAIN 2 LANES ON US 50 EB

CONSTRUCTION:


CONSTRUCT OUTSIDE LANES AND WATER QUALITY SWALE FOR US 50
CONSTRUCT CROSS PIPE AS SHOWN
RESET 1 LIGHT STANDARD
MAINTAIN DRAINAGE AND IRRIGATION FLOWS
PLACE EROSION CONTROL PER THE SWMP

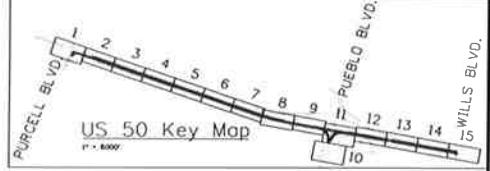

36G20-5 (2)

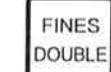

EXISTING R.O.W.

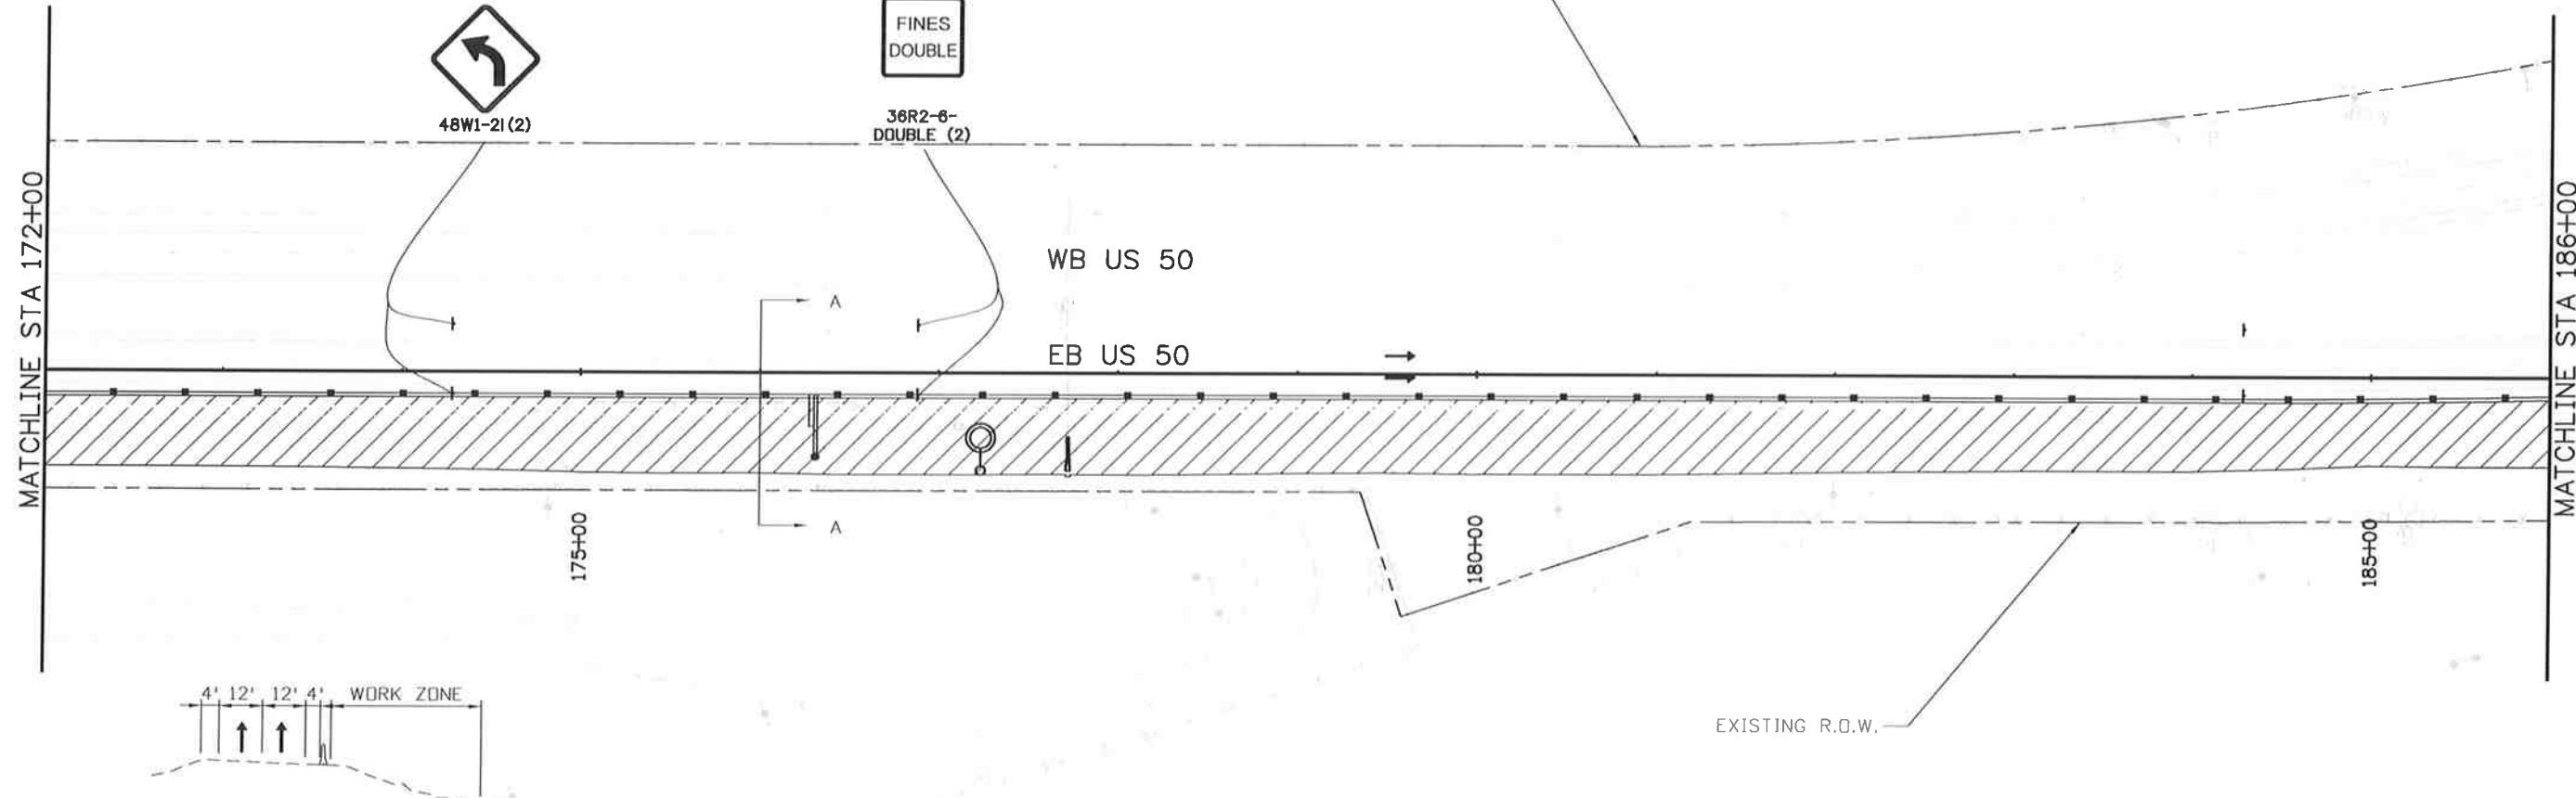

SECTION A-A



0' 50' 100' 200'

LEGEND

	TRAVEL DIRECTION		TYPE 7 BARRIER
	CONSTRUCTION ZONE		IMPACT ATTENUATOR
	COMPLETED CONSTRUCTION		BARRICADE
	TEMPORARY HOT MIX ASPHALT		DRUM CHANNELIZING DEVICE (WITH LIGHT) (FLASHING)
	FLASHING BEACON		

Print Date: 10/9/2014

File Name: 19056DES_Construction Phasing_7.dgn

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Void:

US 50 WEST
PURCELL BLVD. TO WILLS BLVD.
CTC - PHASE 1

Project No./Code

FSA 0503-081

19751

Sheet Number 252

DTD

AB

Structure
Numbers

CT

Subset Sheets: CT07 of 33





**Know what's below.
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PHASE 1

TRAFFIC CONTROL:
US 50 TRAFFIC ON EXISTING PAVEMENT
MAINTAIN 2 LANES ON US 50 EB

CONSTRUCTION:

CONSTRUCT OUTSIDE LANES AND WATER QUALITY SWALE FOR US 50
CONSTRUCT CROSS PIPE AS SHOWN
MAINTAIN DRAINAGE AND IRRIGATION FLOWS
PLACE EROSION CONTROL PER THE SWMP

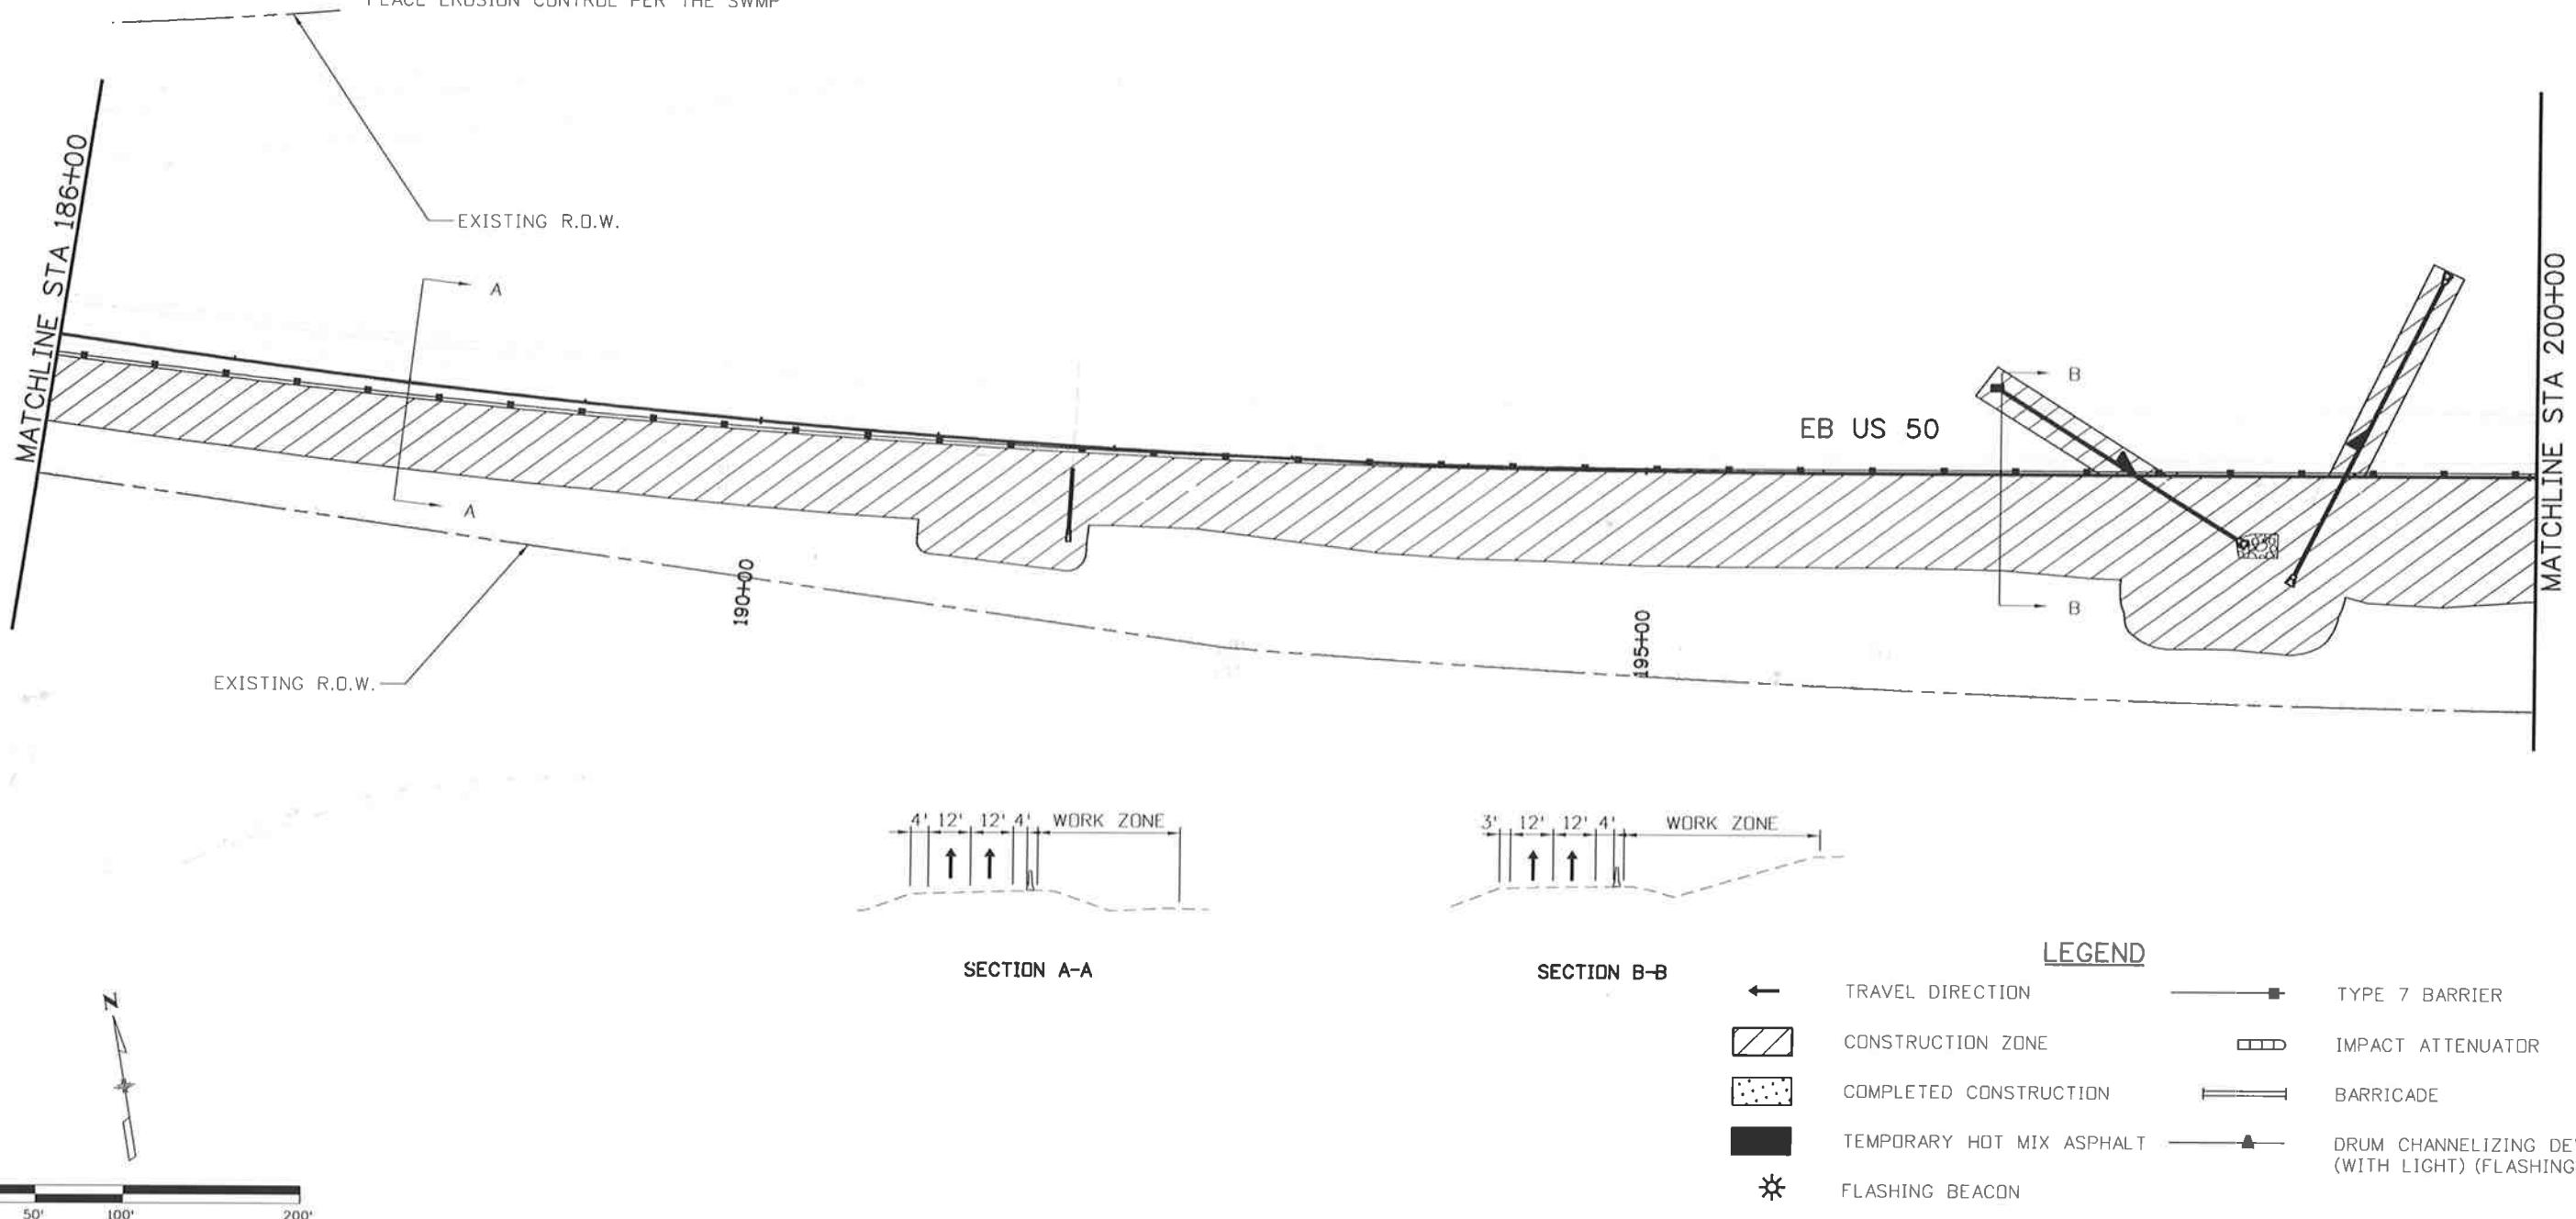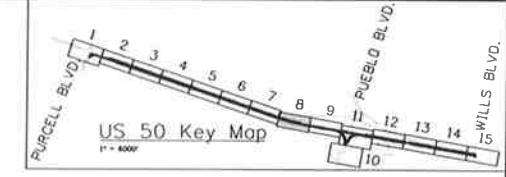

Print Date: 10/9/2014

File Name: 19056DES_Construction Phasing1_B.dgn

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US 50 WEST
PURCELL BLVD. TO WILLS BLVD.
CTC - PHASE 1

Project No./Code
FSA 0503-081
19751
Sheet Number 253





**Know what's below.
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PHASE 1

TRAFFIC CONTROL:
US 50 TRAFFIC ON EXISTING PAVEMENT
MAINTAIN 2 LANES ON US 50 EB

CONSTRUCTION:

CONSTRUCT OUTSIDE LANES AND WATER QUALITY SWALE FOR US 50
CONSTRUCT CROSS PIPE AS SHOWN
MAINTAIN DRAINAGE AND IRRIGATION FLOWS
PLACE EROSION CONTROL PER THE SWMP

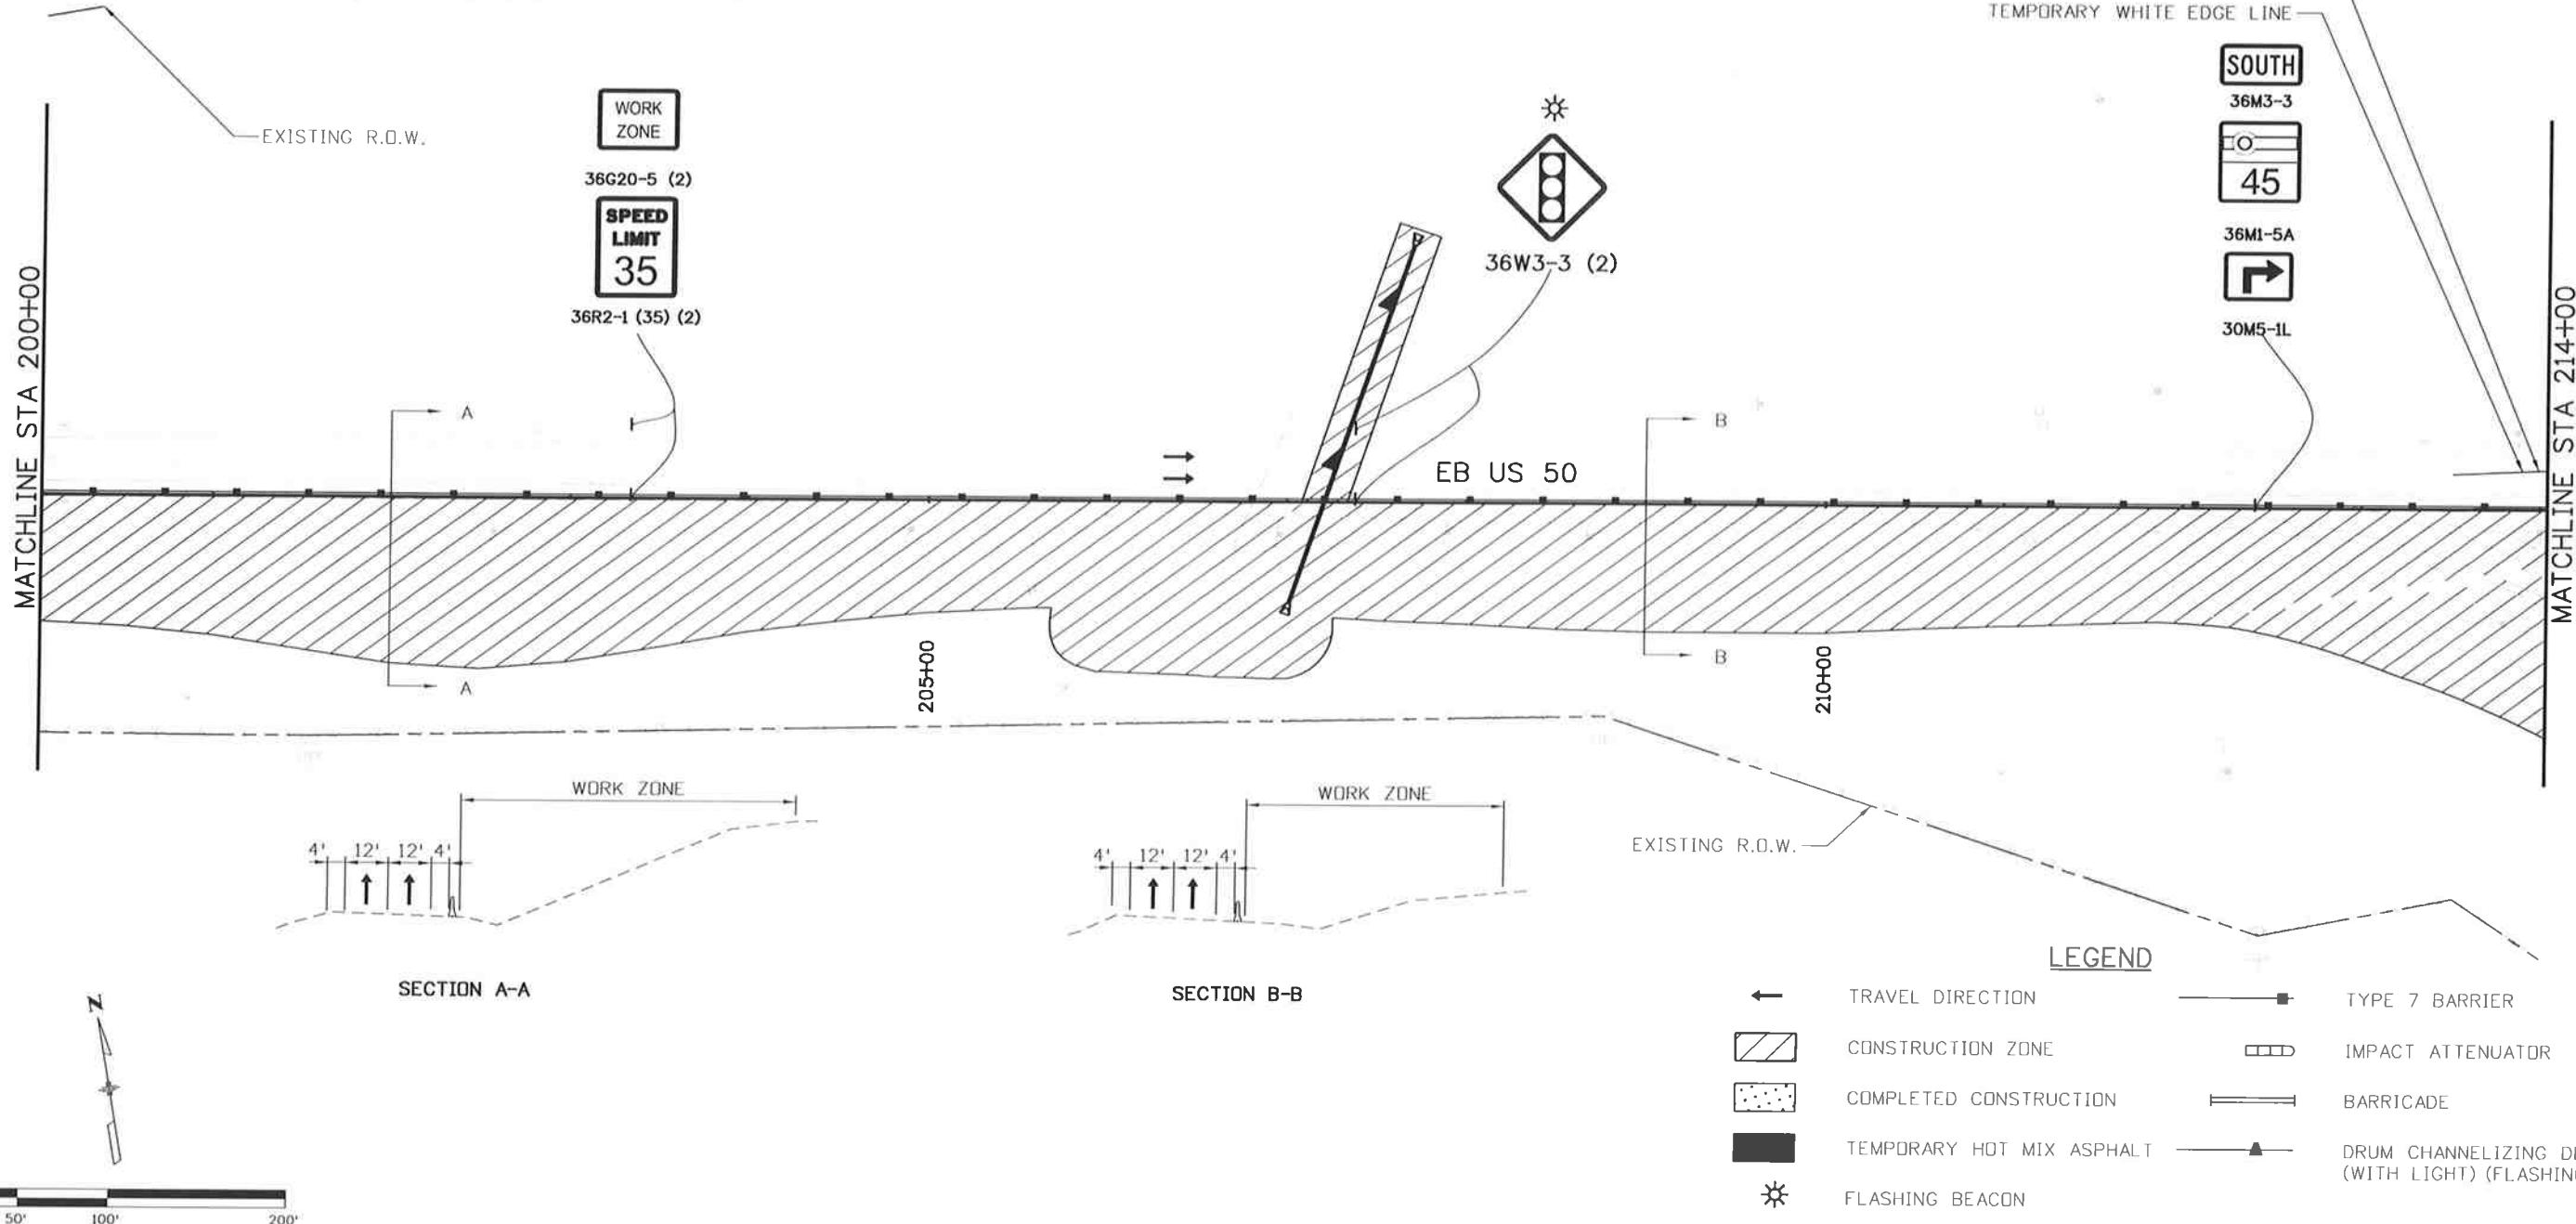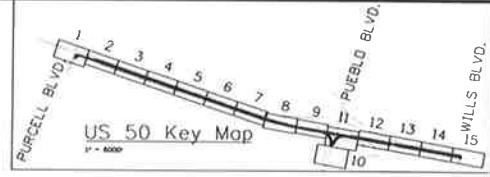

Print Date: 10/9/2014

File Name: 19056DES_Construction Phasing1_9.dgn

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US 50 WEST
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CTC -- PHASE 1

Project No./Code


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File Name: 19056DES_Construction Phasing_10.dgn

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DTD

As Constructed

No Revisions:

Revised:

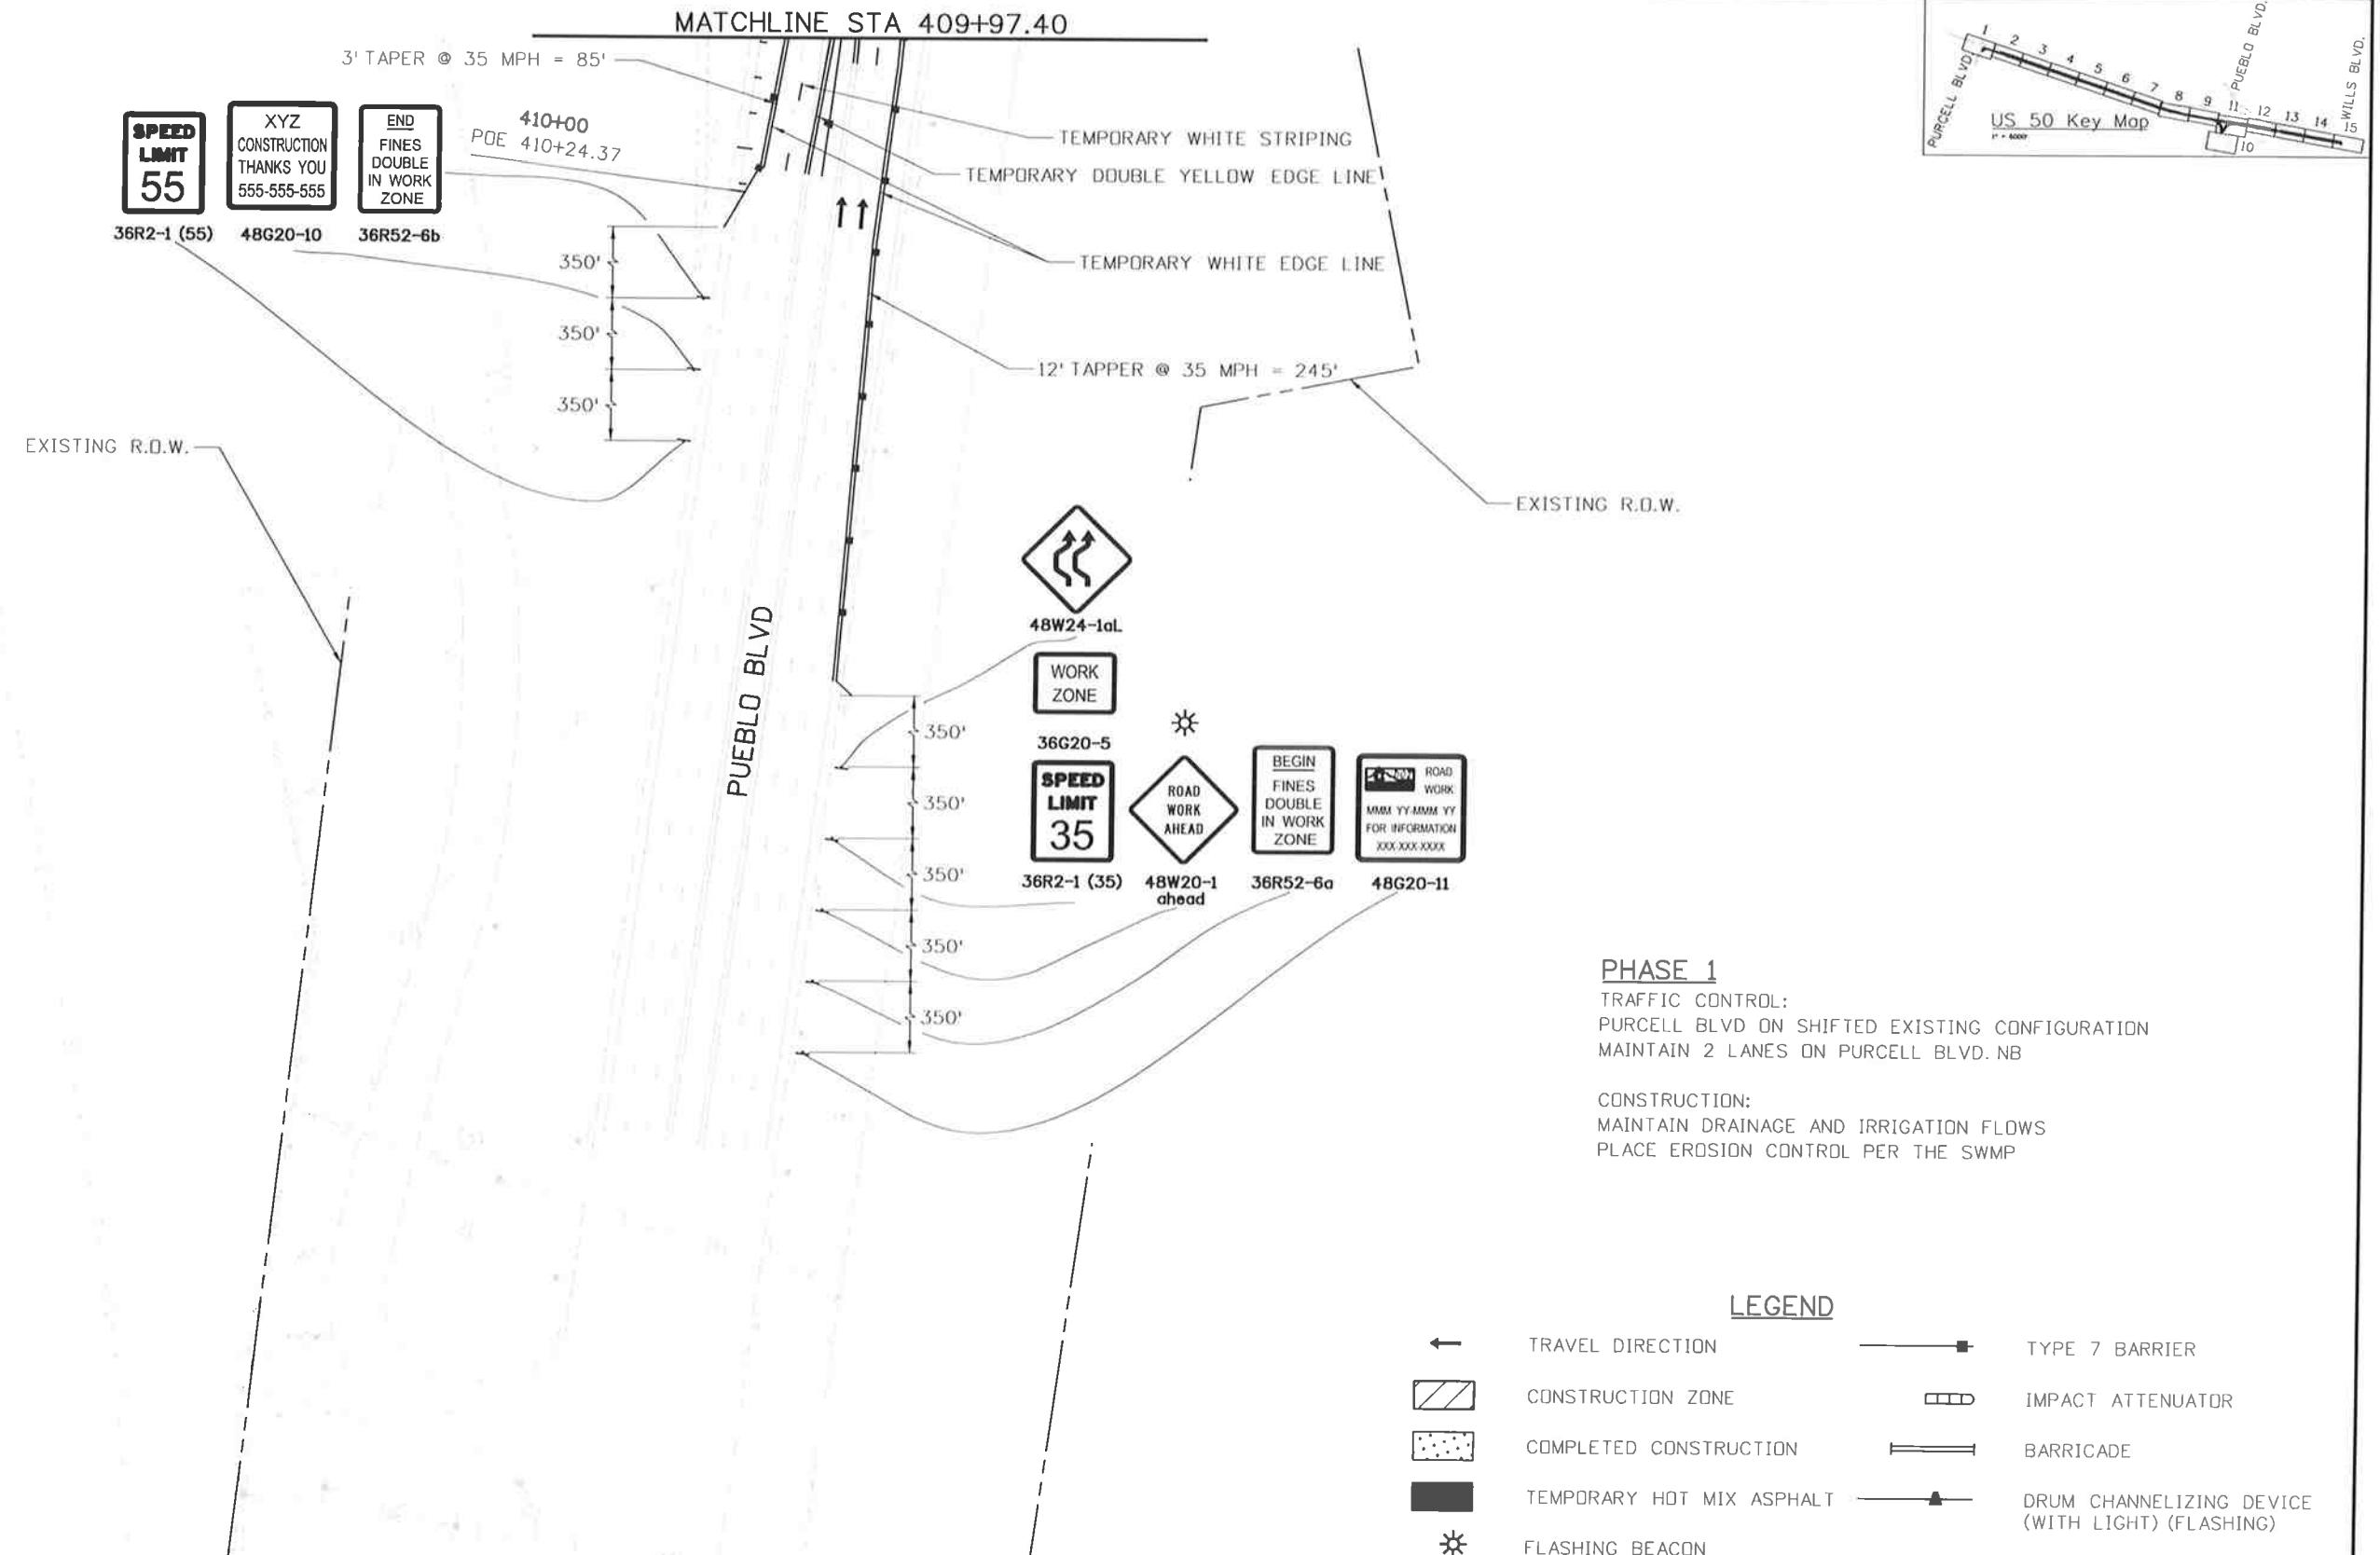Void:

US 50 WEST
PURCELL BLVD. TO WILLS BLVD.
CTC - PHASE 1

Project No./Code

FSA 0503-081


Designer: AB Structure

Detailer: AB Numbers

Subset: CT Subset Sheets: CT10 of 33

19751

Sheet Number 255

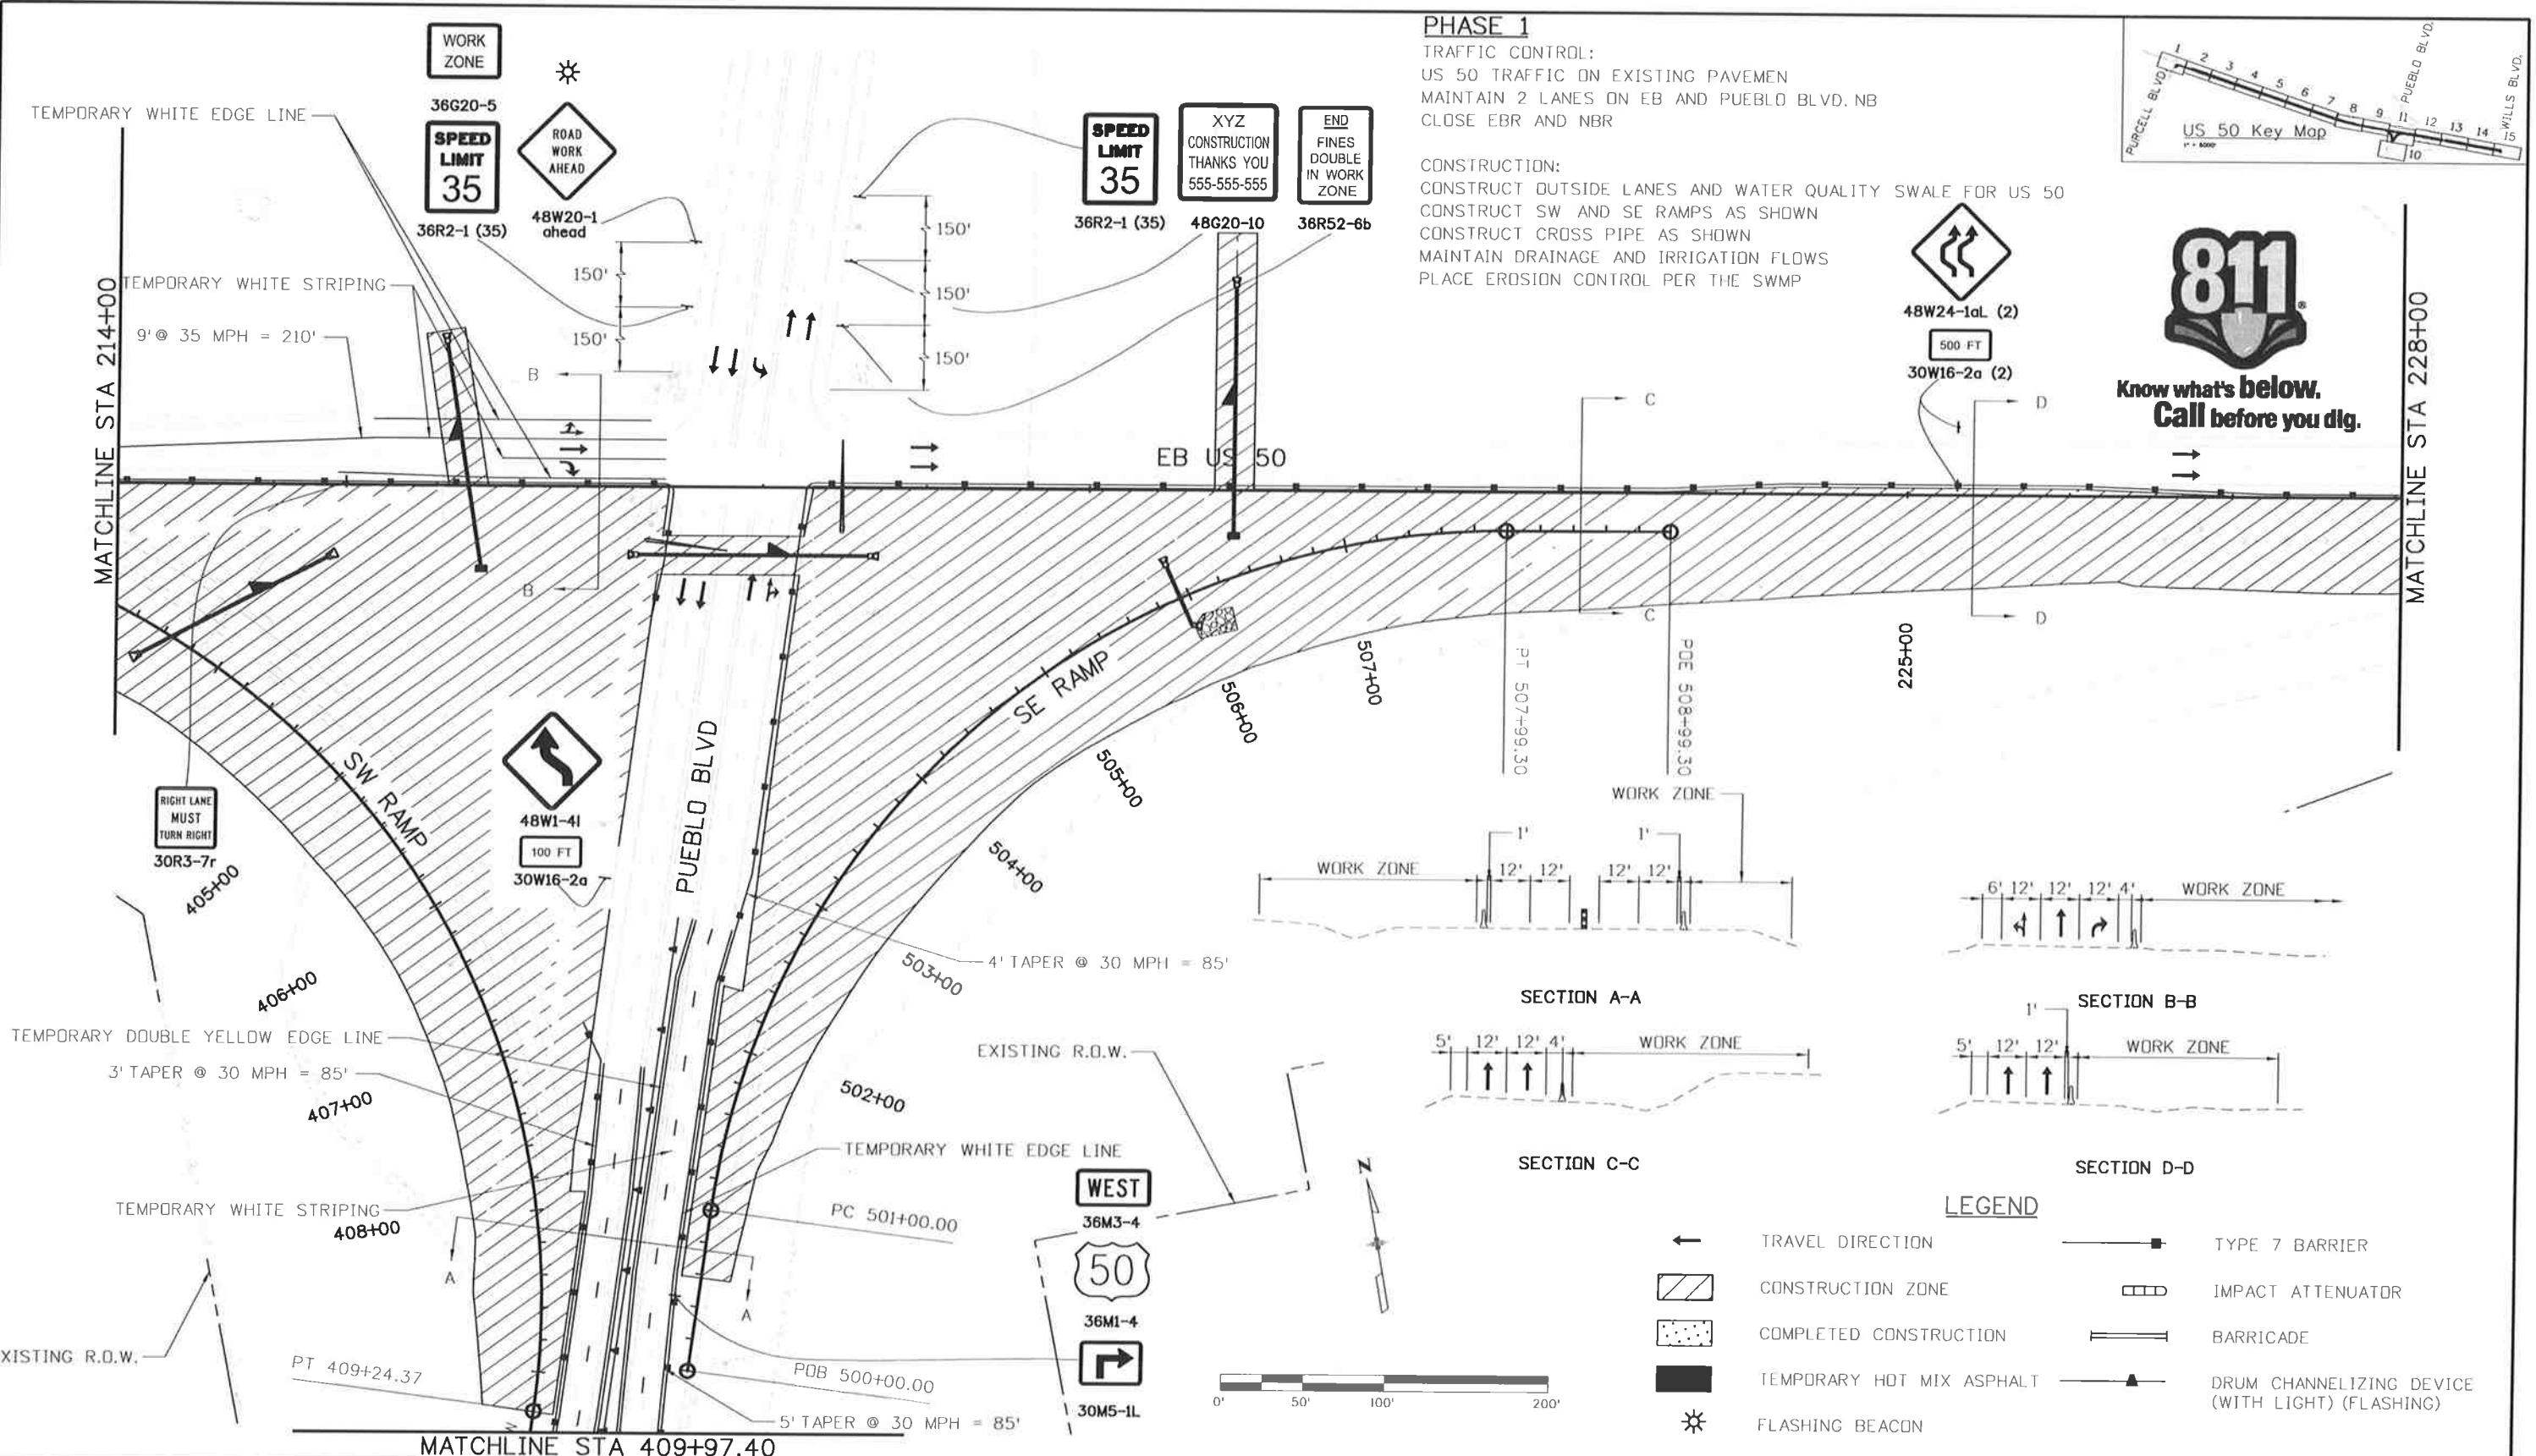

Print Date: 10/9/2014

File Name: 19056DES_Construction Phasing1.dgn

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Void:

US 50 WEST:
PURCELL BLVD. TO WILLS BLVD.
CTC - PHASE 1

Project No./Code
FSA 0503-081

19751

Sheet Number 256





**Know what's below.
Call before you dig.**

PHASE 1

TRAFFIC CONTROL:
US 50 TRAFFIC ON EXISTING PAVEMENT
MAINTAIN 2 LANES ON EB

CONSTRUCTION:

CONSTRUCT OUTSIDE LANES AND WATER QUALITY SWALE FOR US 50
CONSTRUCT EBR AND NBR AS SHOWN
CONSTRUCT WATER QUALITY POND AND PIPE
MAINTAIN DRAINAGE AND IRRIGATION FLOWS
PLACE EROSION CONTROL PER THE SWMP
PLACE TEMP. HMA FOR BRIDGE CONSTRUCTION DETOUR, PHASE 2A

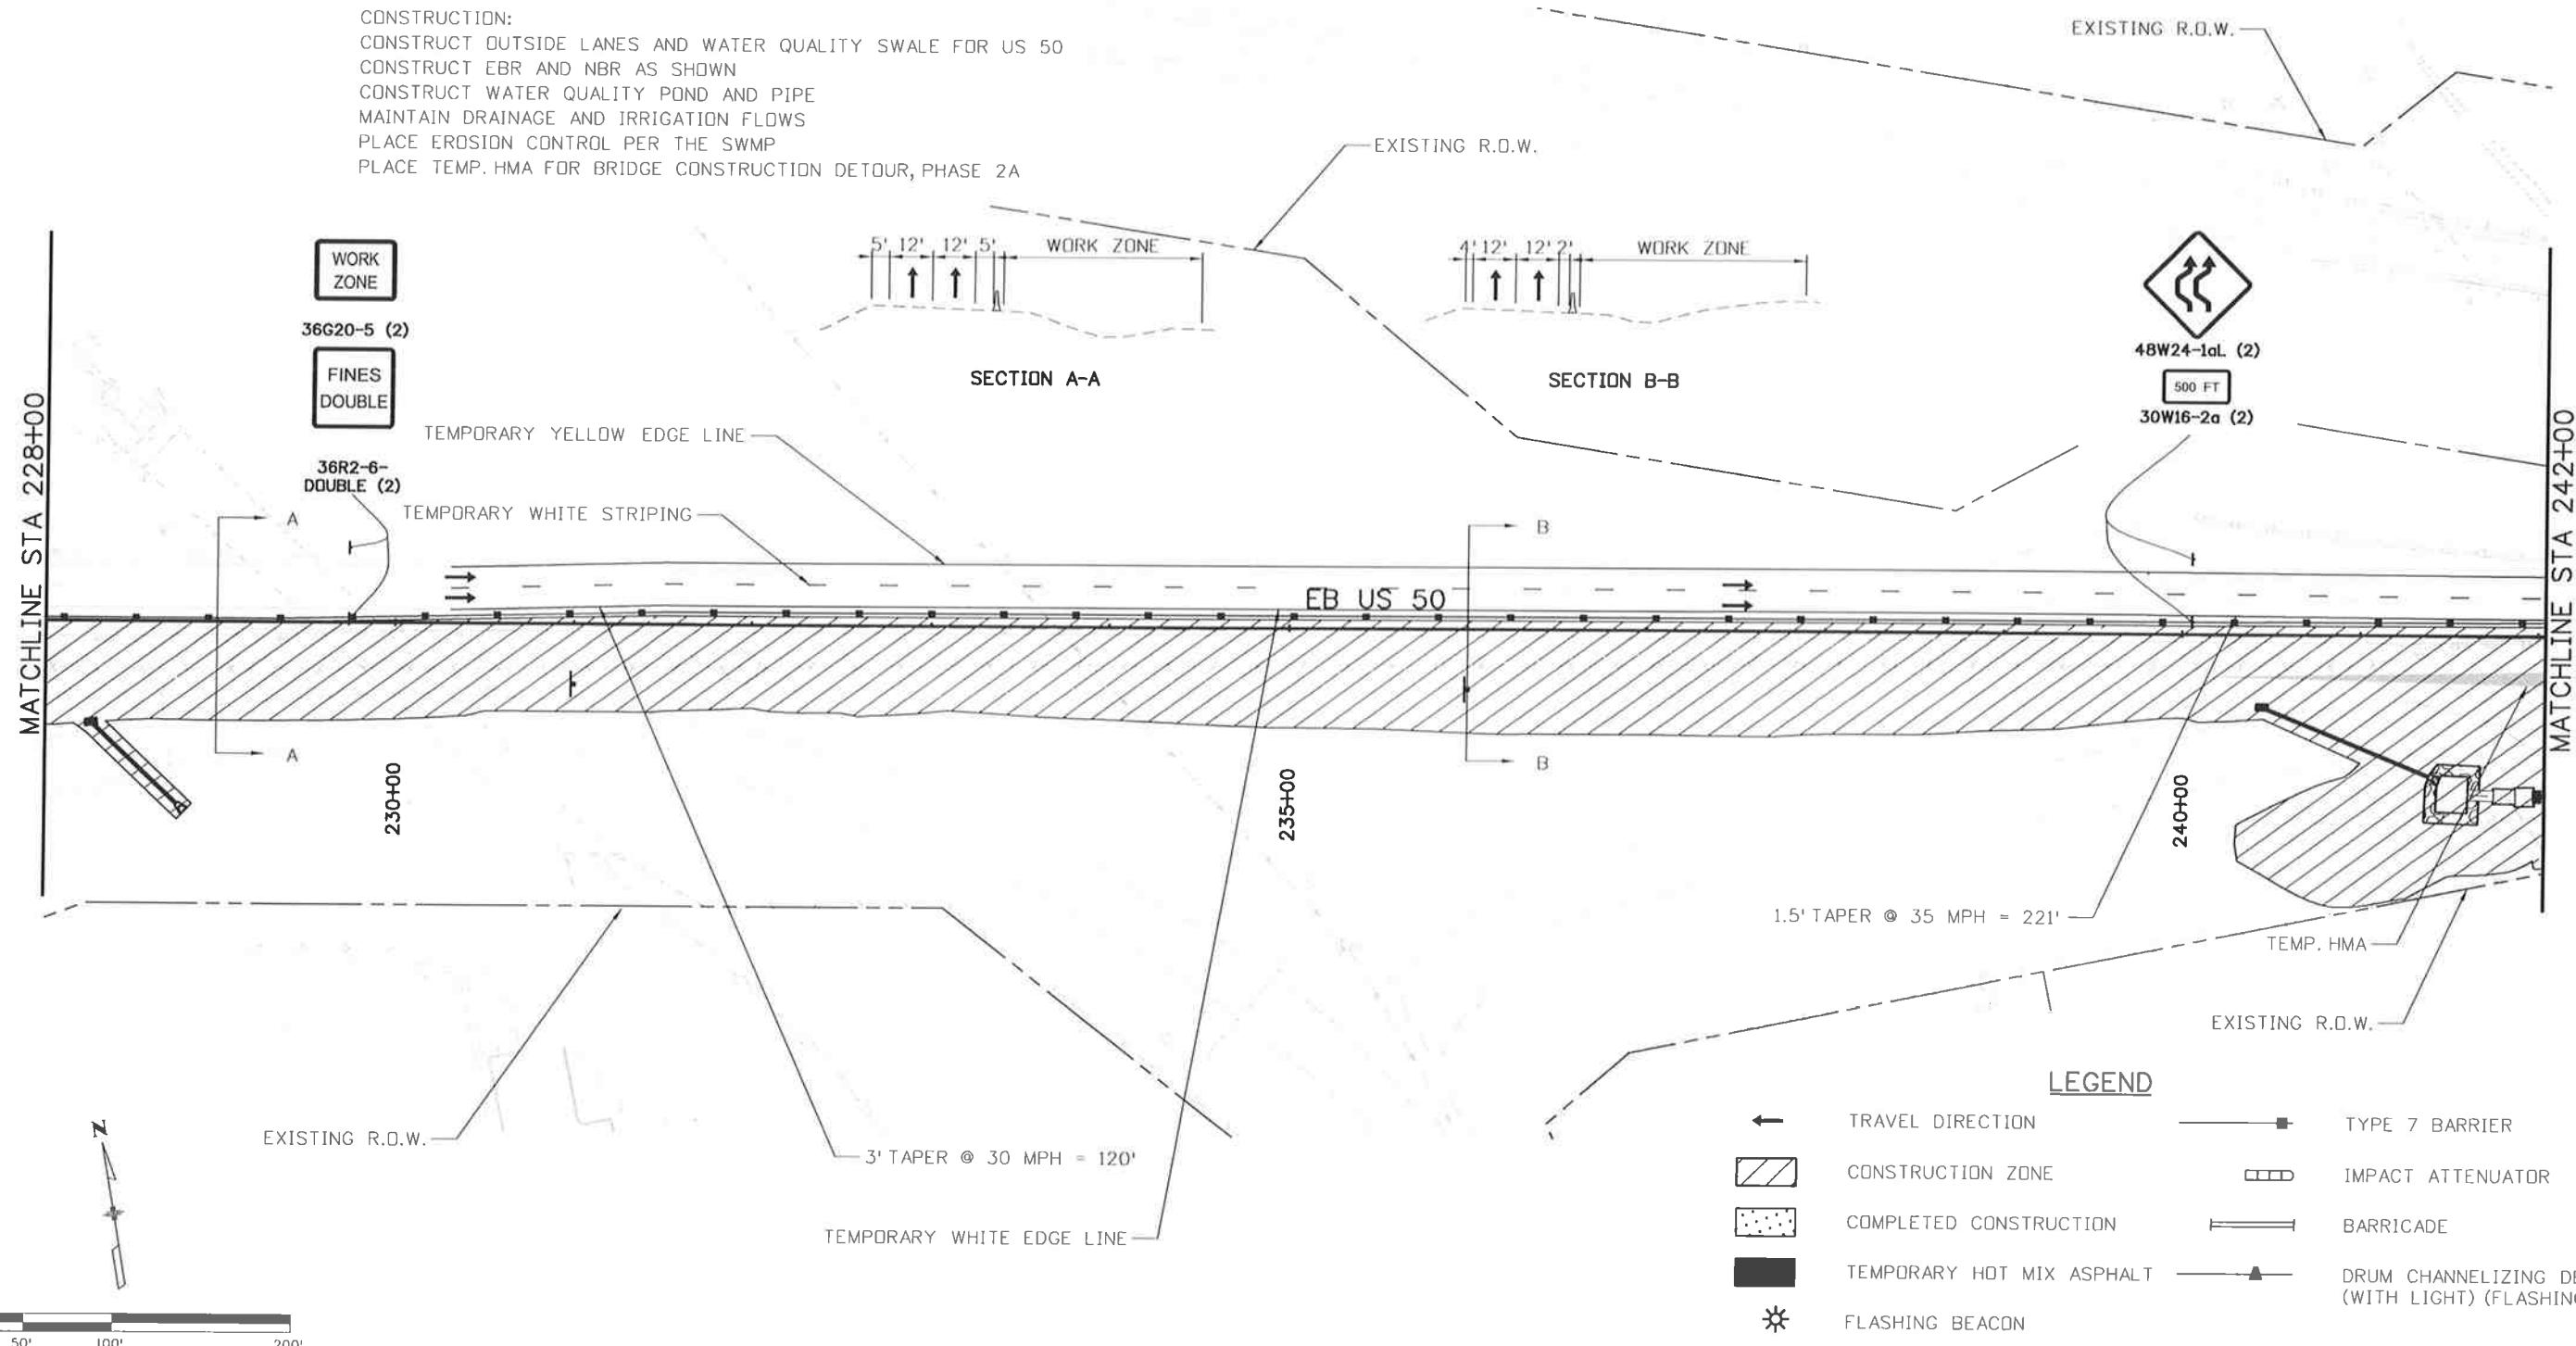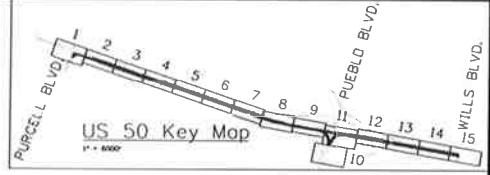

Print Date: 10/9/2014

File Name: 19056DES_Construction Phasing_12.dgn

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No Revisions:

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Void:

US 50 WEST
PURCELL BLVD. TO WILLS BLVD.
CTC - PHASE 1

Project No./Code

FSA 0503-081

19751

Sheet Number 257




**Know what's below.
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PHASE 1

TRAFFIC CONTROL:
US 50 TRAFFIC ON EXISTING PAVEMENT
MAINTAIN 2 LANES ON FB

CONSTRUCTION

CONSTRUCT OUTSIDE LANES AND WATER QUALITY SWALE FOR US 50
BRIDGE WIDENING (STAGE 1 & 2, AS SHOWN IN BRIDGE CONSTRUCTION STAGING)
CONSTRUCT EBR AND NBR AS SHOWN
CONSTRUCT STORM SYSTEM AS SHOWN
CONSTRUCT WATER QUALITY PONDS
MAINTAIN DRAINAGE AND IRRIGATION FLOWS
PLACE EROSION CONTROL PER THE SWMP
PLACE TEMP. HMA FOR BRIDGE CONSTRUCTION DETOUR, PHASE 2A

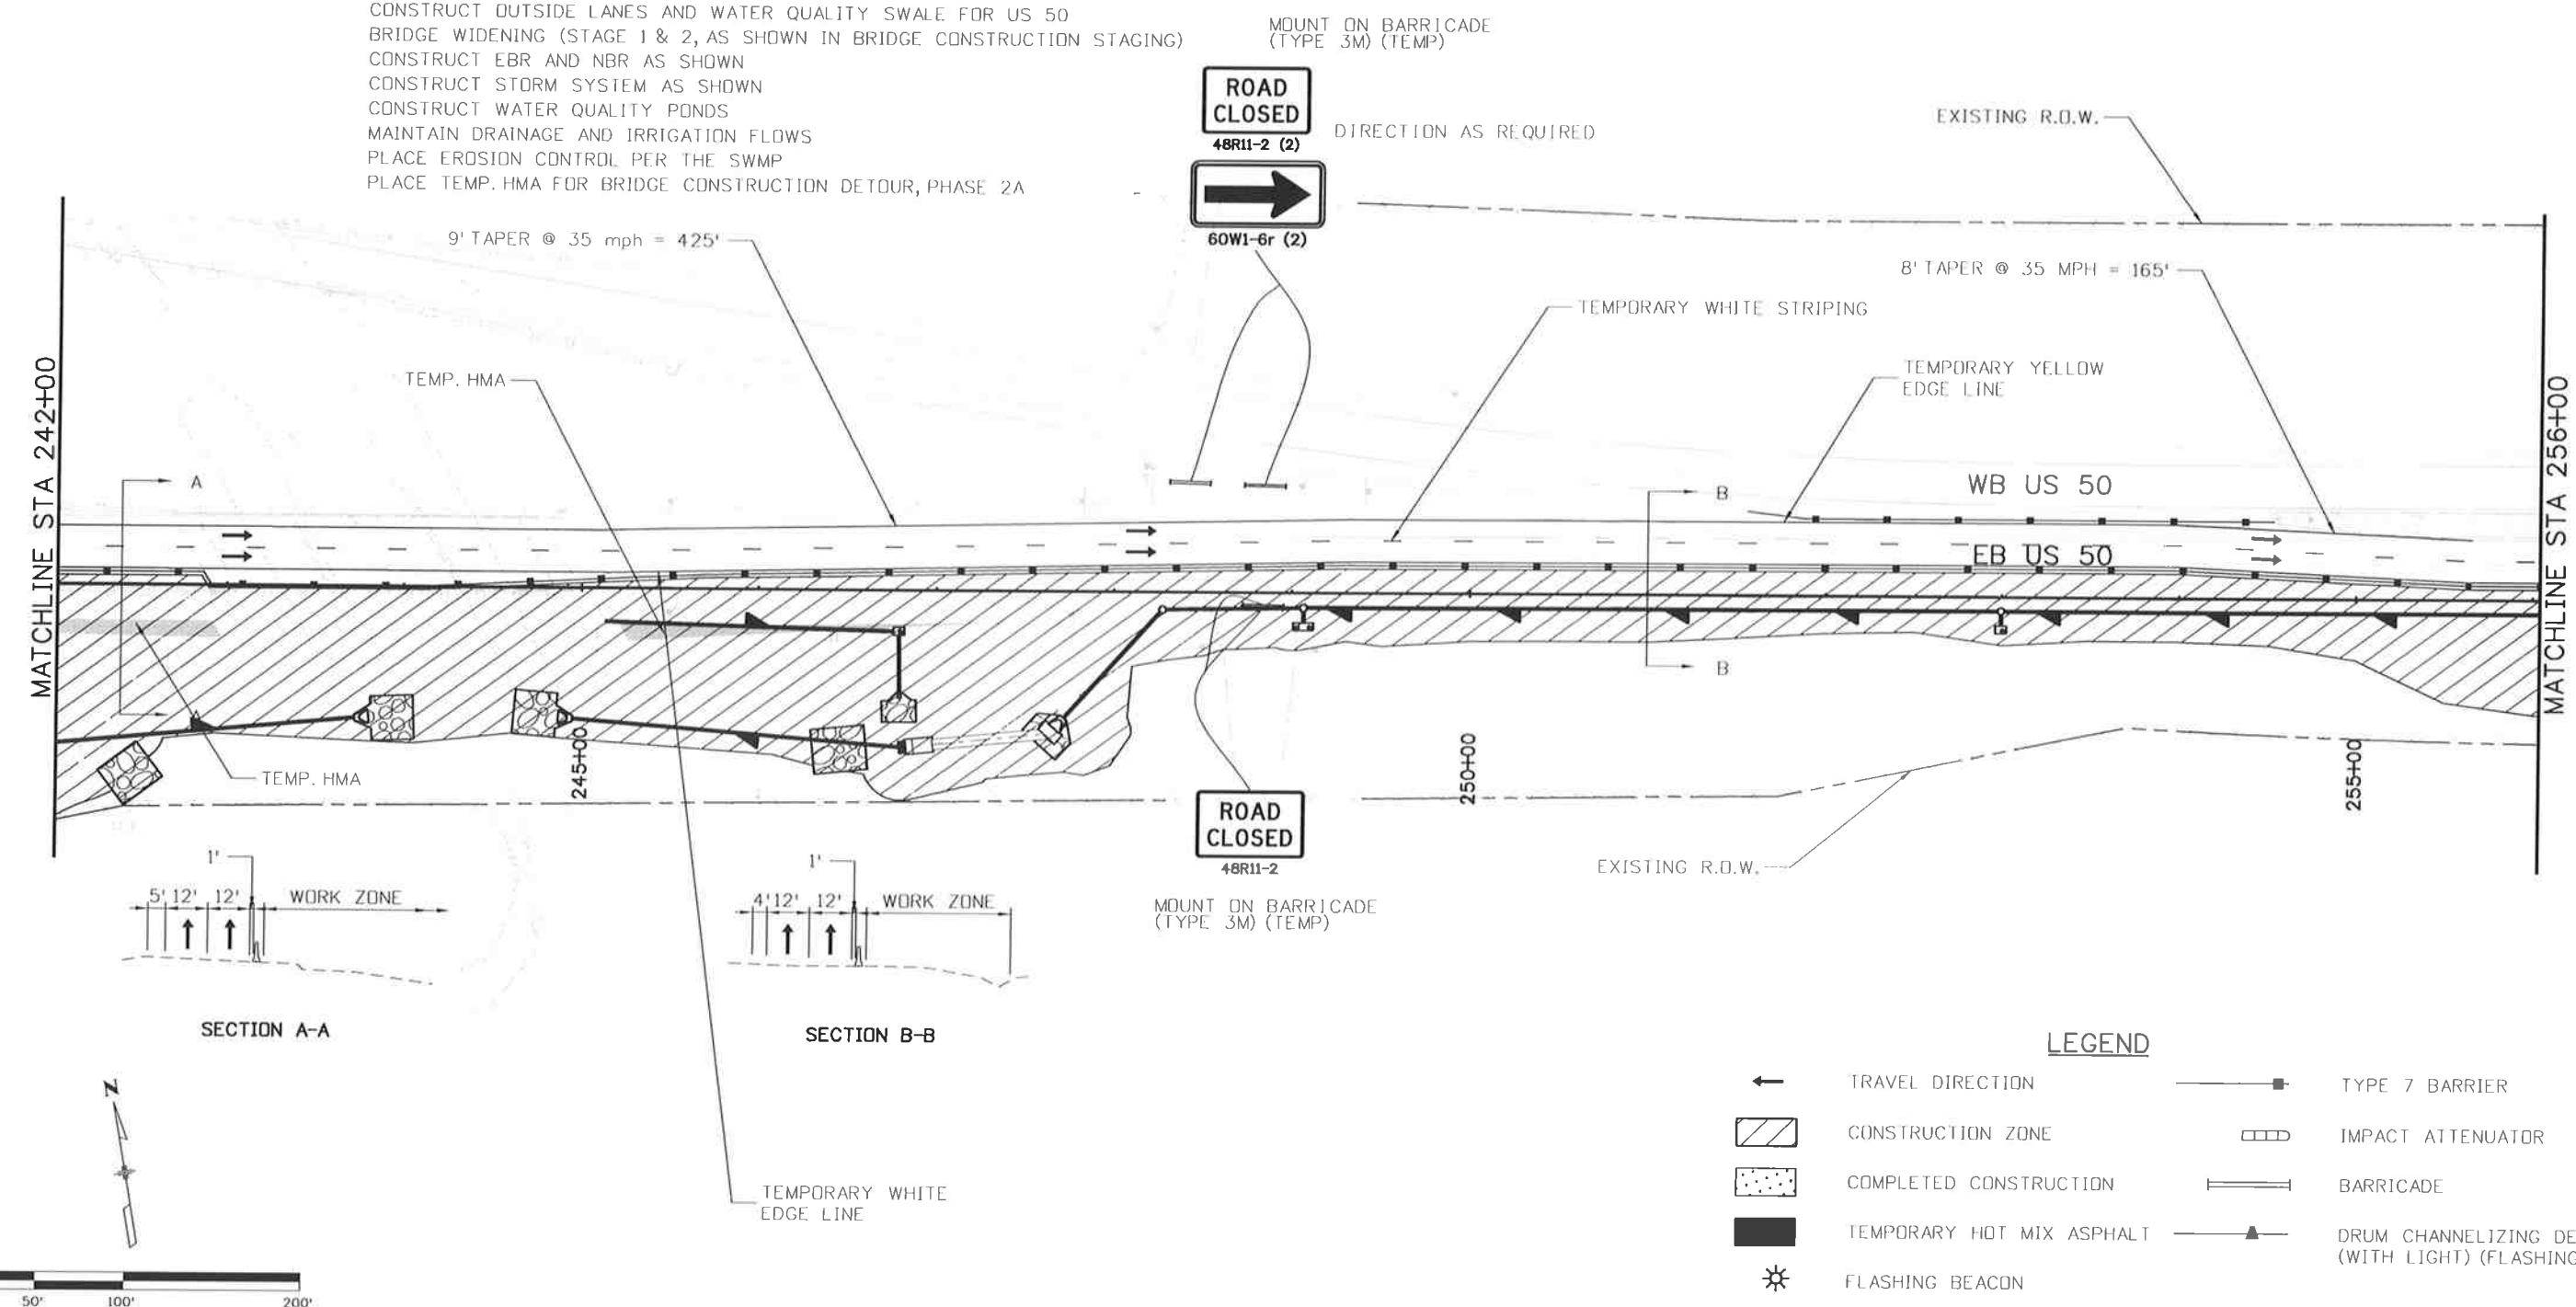

Print Date: 10/9/2014
File Name: 19056DES_Construction Phasing1_13.dgn
Horiz. Scale: 1:100 Vert. Scale: As N



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9-546-5702	Revised:
DTD	Void:

US 50 WEST
PURCELL BLVD. TO WILLS BLVD.
CTC - PHASE 1

Project No./Code	
FSA 0503-081	
19751	
Sheet Number	258





**Know what's below.
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PHASE 1

TRAFFIC CONTROL:
US 50 TRAFFIC ON EXISTING PAVEMENT
MAINTAIN 2 LANES ON EB
ONE LANE TRAFFIC AT RAILROAD BRIDGE TILL STA. 267+40

CONSTRUCTION:

CONSTRUCT OUTSIDE LANES AND WATER QUALITY SWALE FOR US 50
CONSTRUCT STORM SYSTEM AS SHOWN
RESET 2 LIGHT STANDARDS
MAINTAIN DRAINAGE AND IRRIGATION FLOWS
PLACE EROSION CONTROL PER THE SWMP

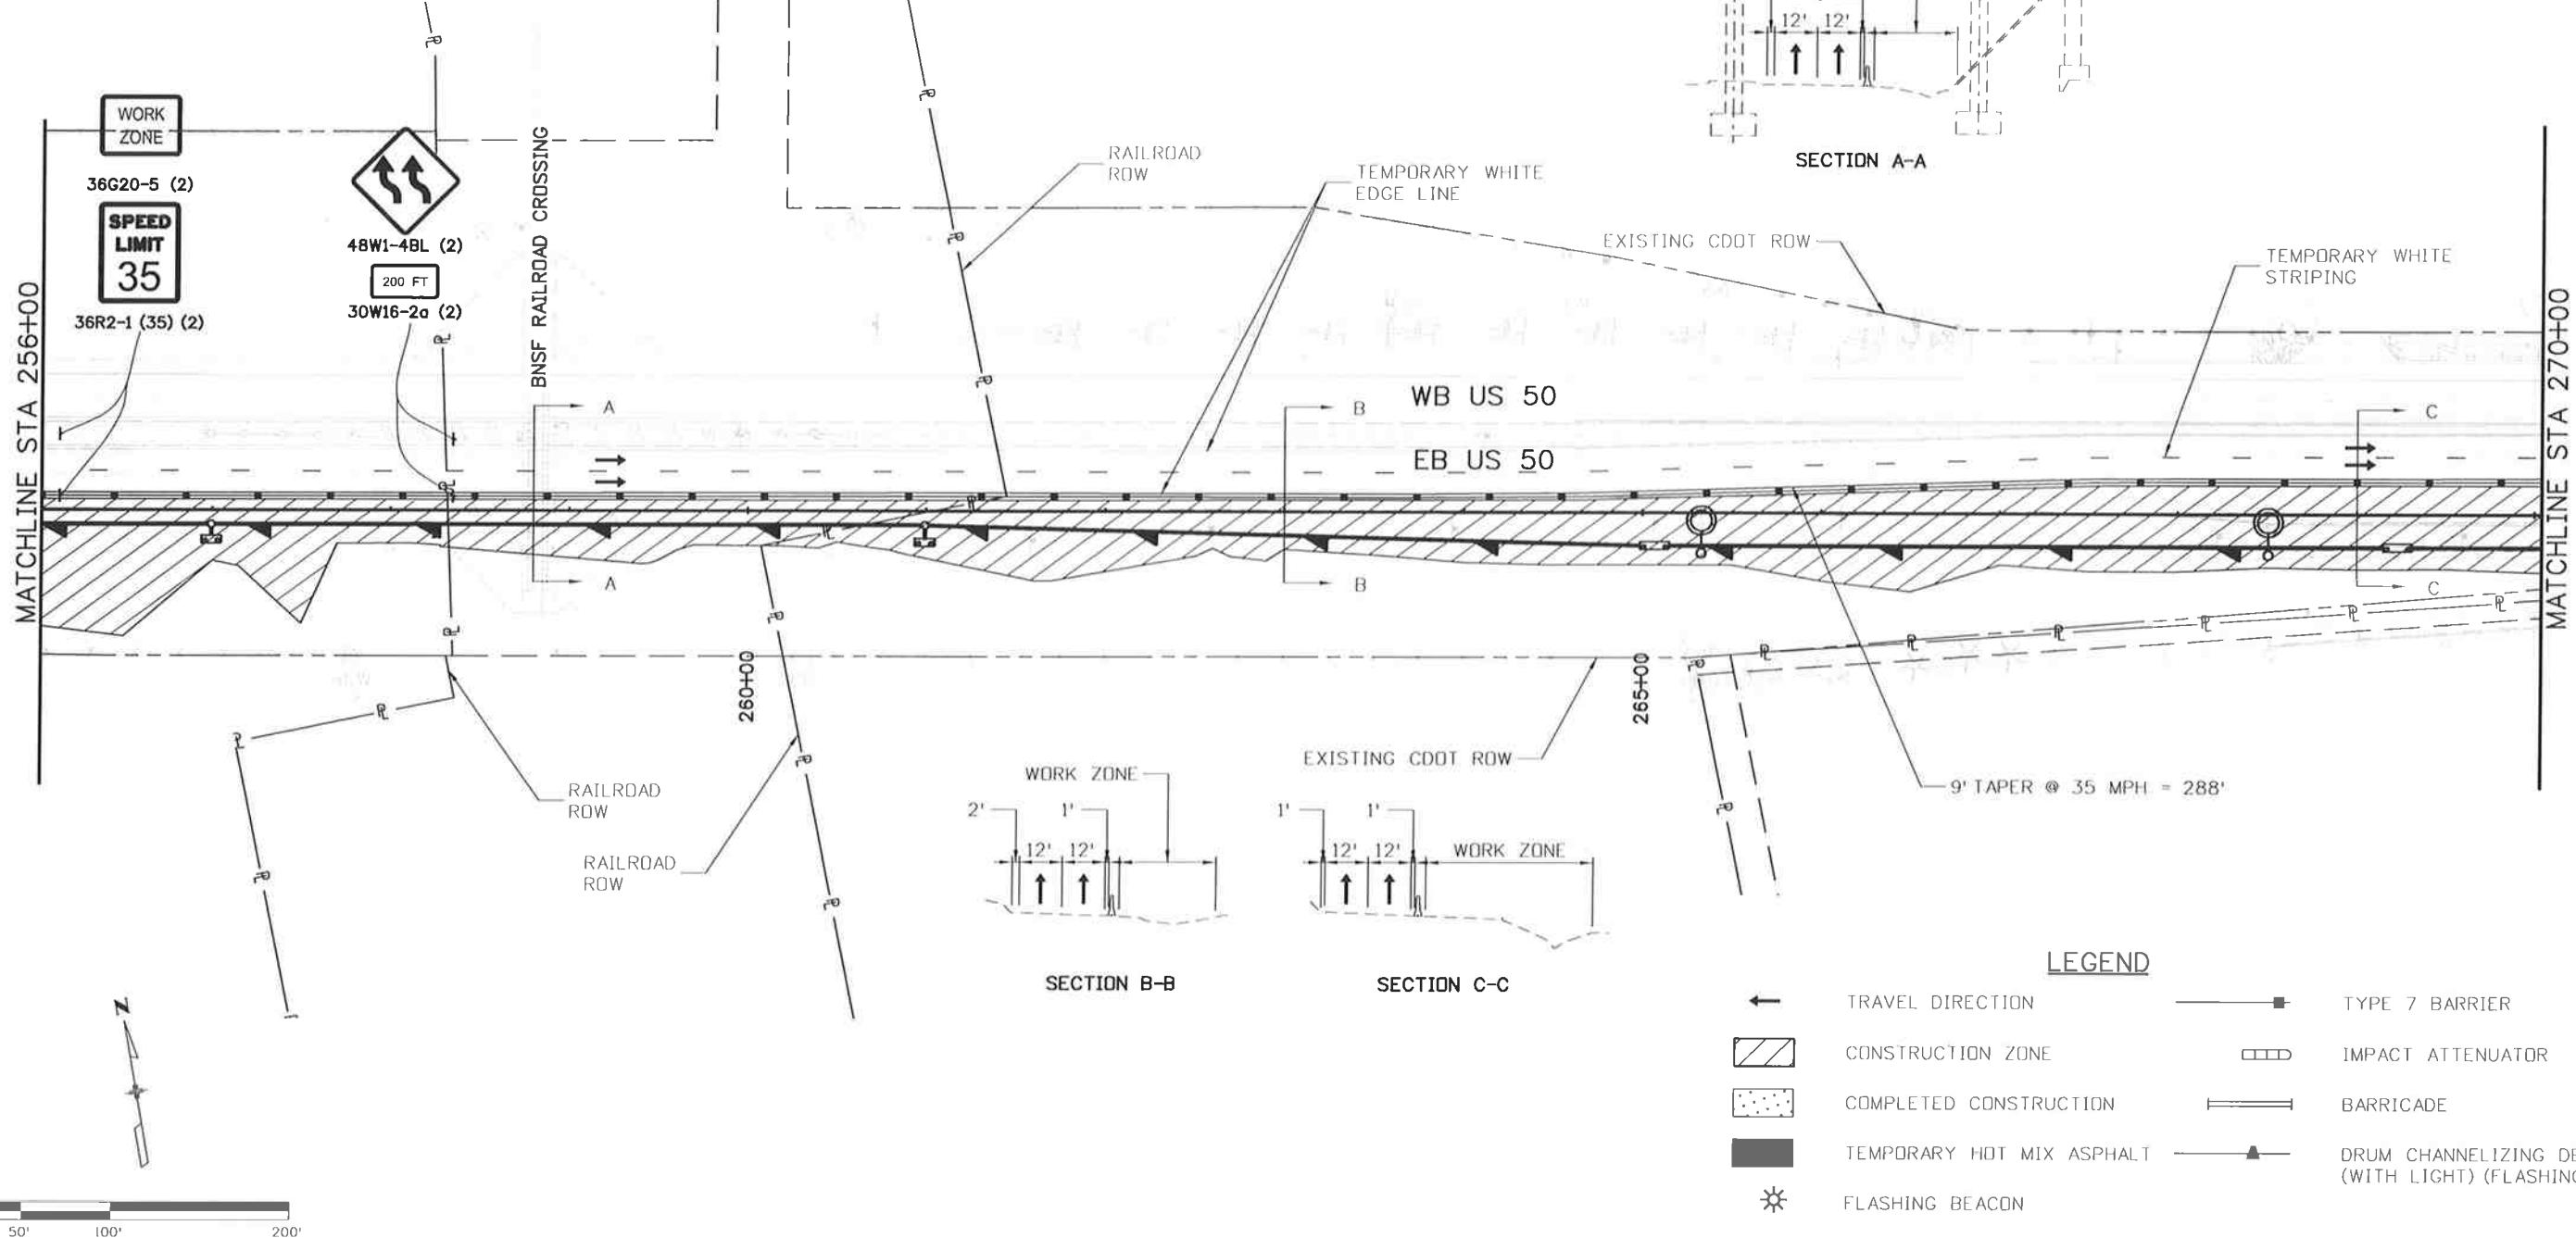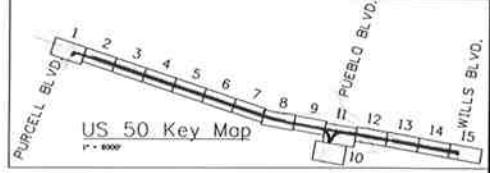

Print Date: 10/9/2014

File Name: I9056DES_Construction PhasingI_14.dgn

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US 50 WEST
PURCELL BLVD. TO WILLS BLVD.
CTC - PHASE 1

Project No./Code

FSA 0503-081

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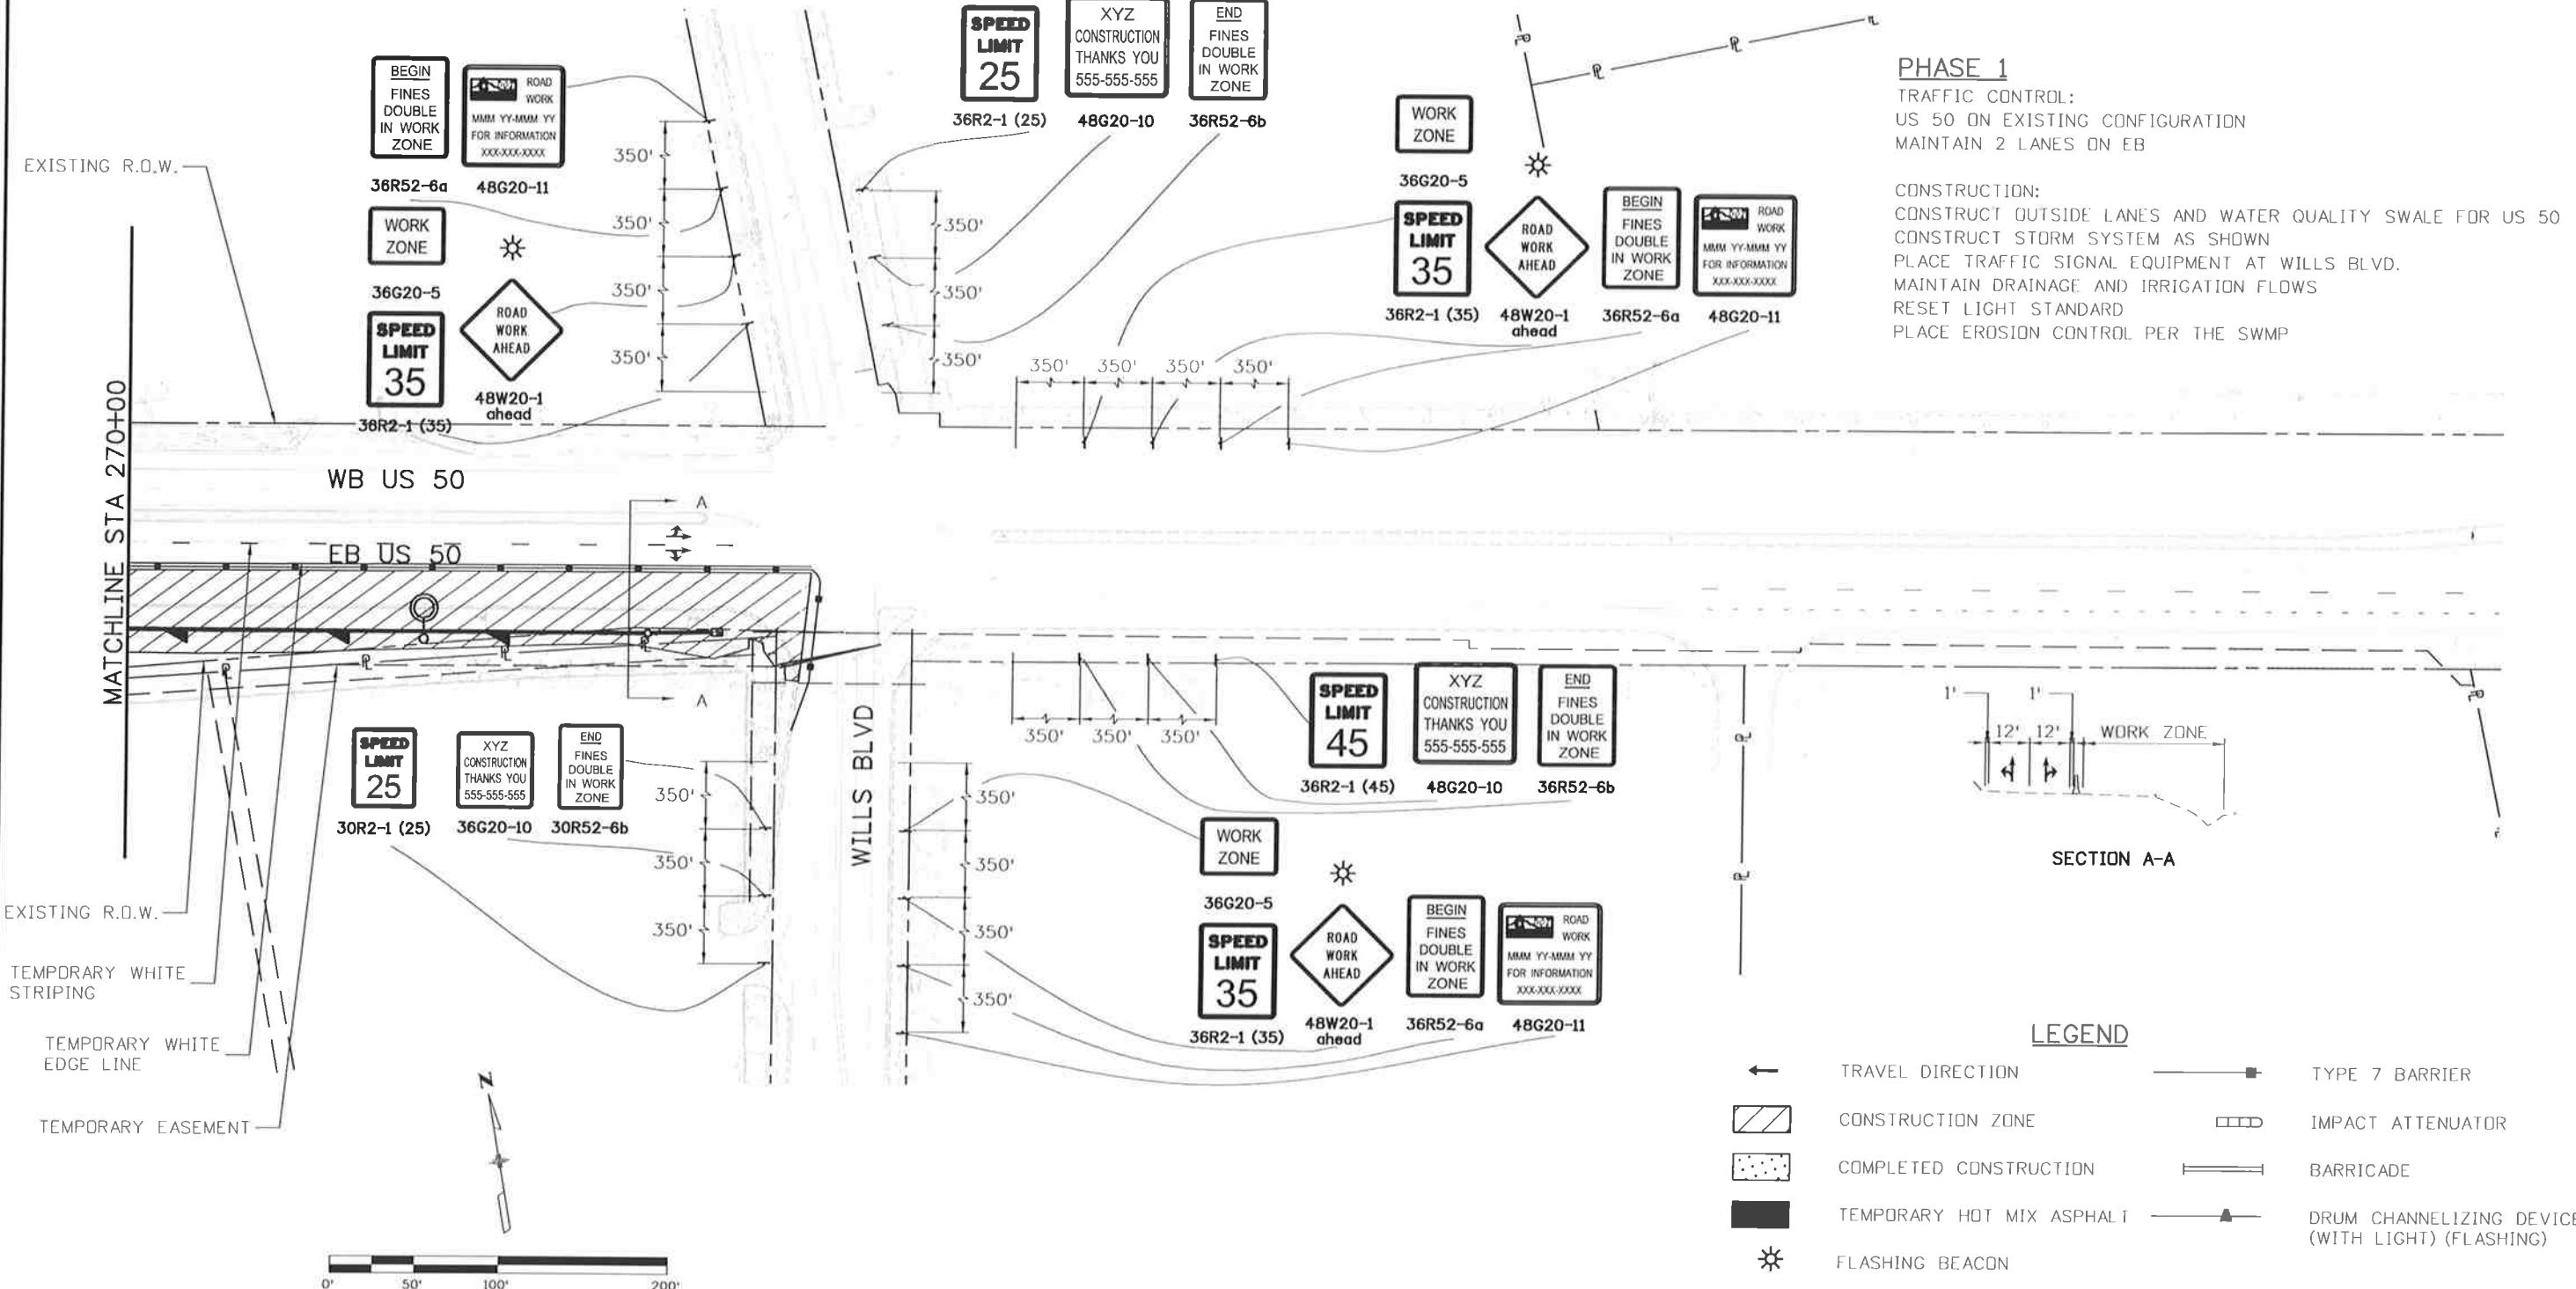
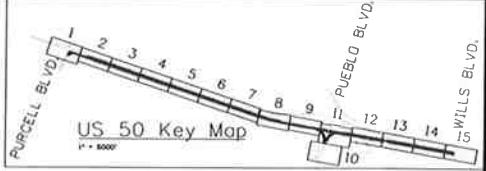
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No Revisions:

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US 50 WEST
PURCELL BLVD. TO WILLS BLVD.
CTC - PHASING 1

Project No./Code

FSA 0503-081

Designer: AB Structure Numbers

Drafter: AB Structure Numbers

Subset: CT Subset Sheets: CT15 of 33

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Sheet Number 260



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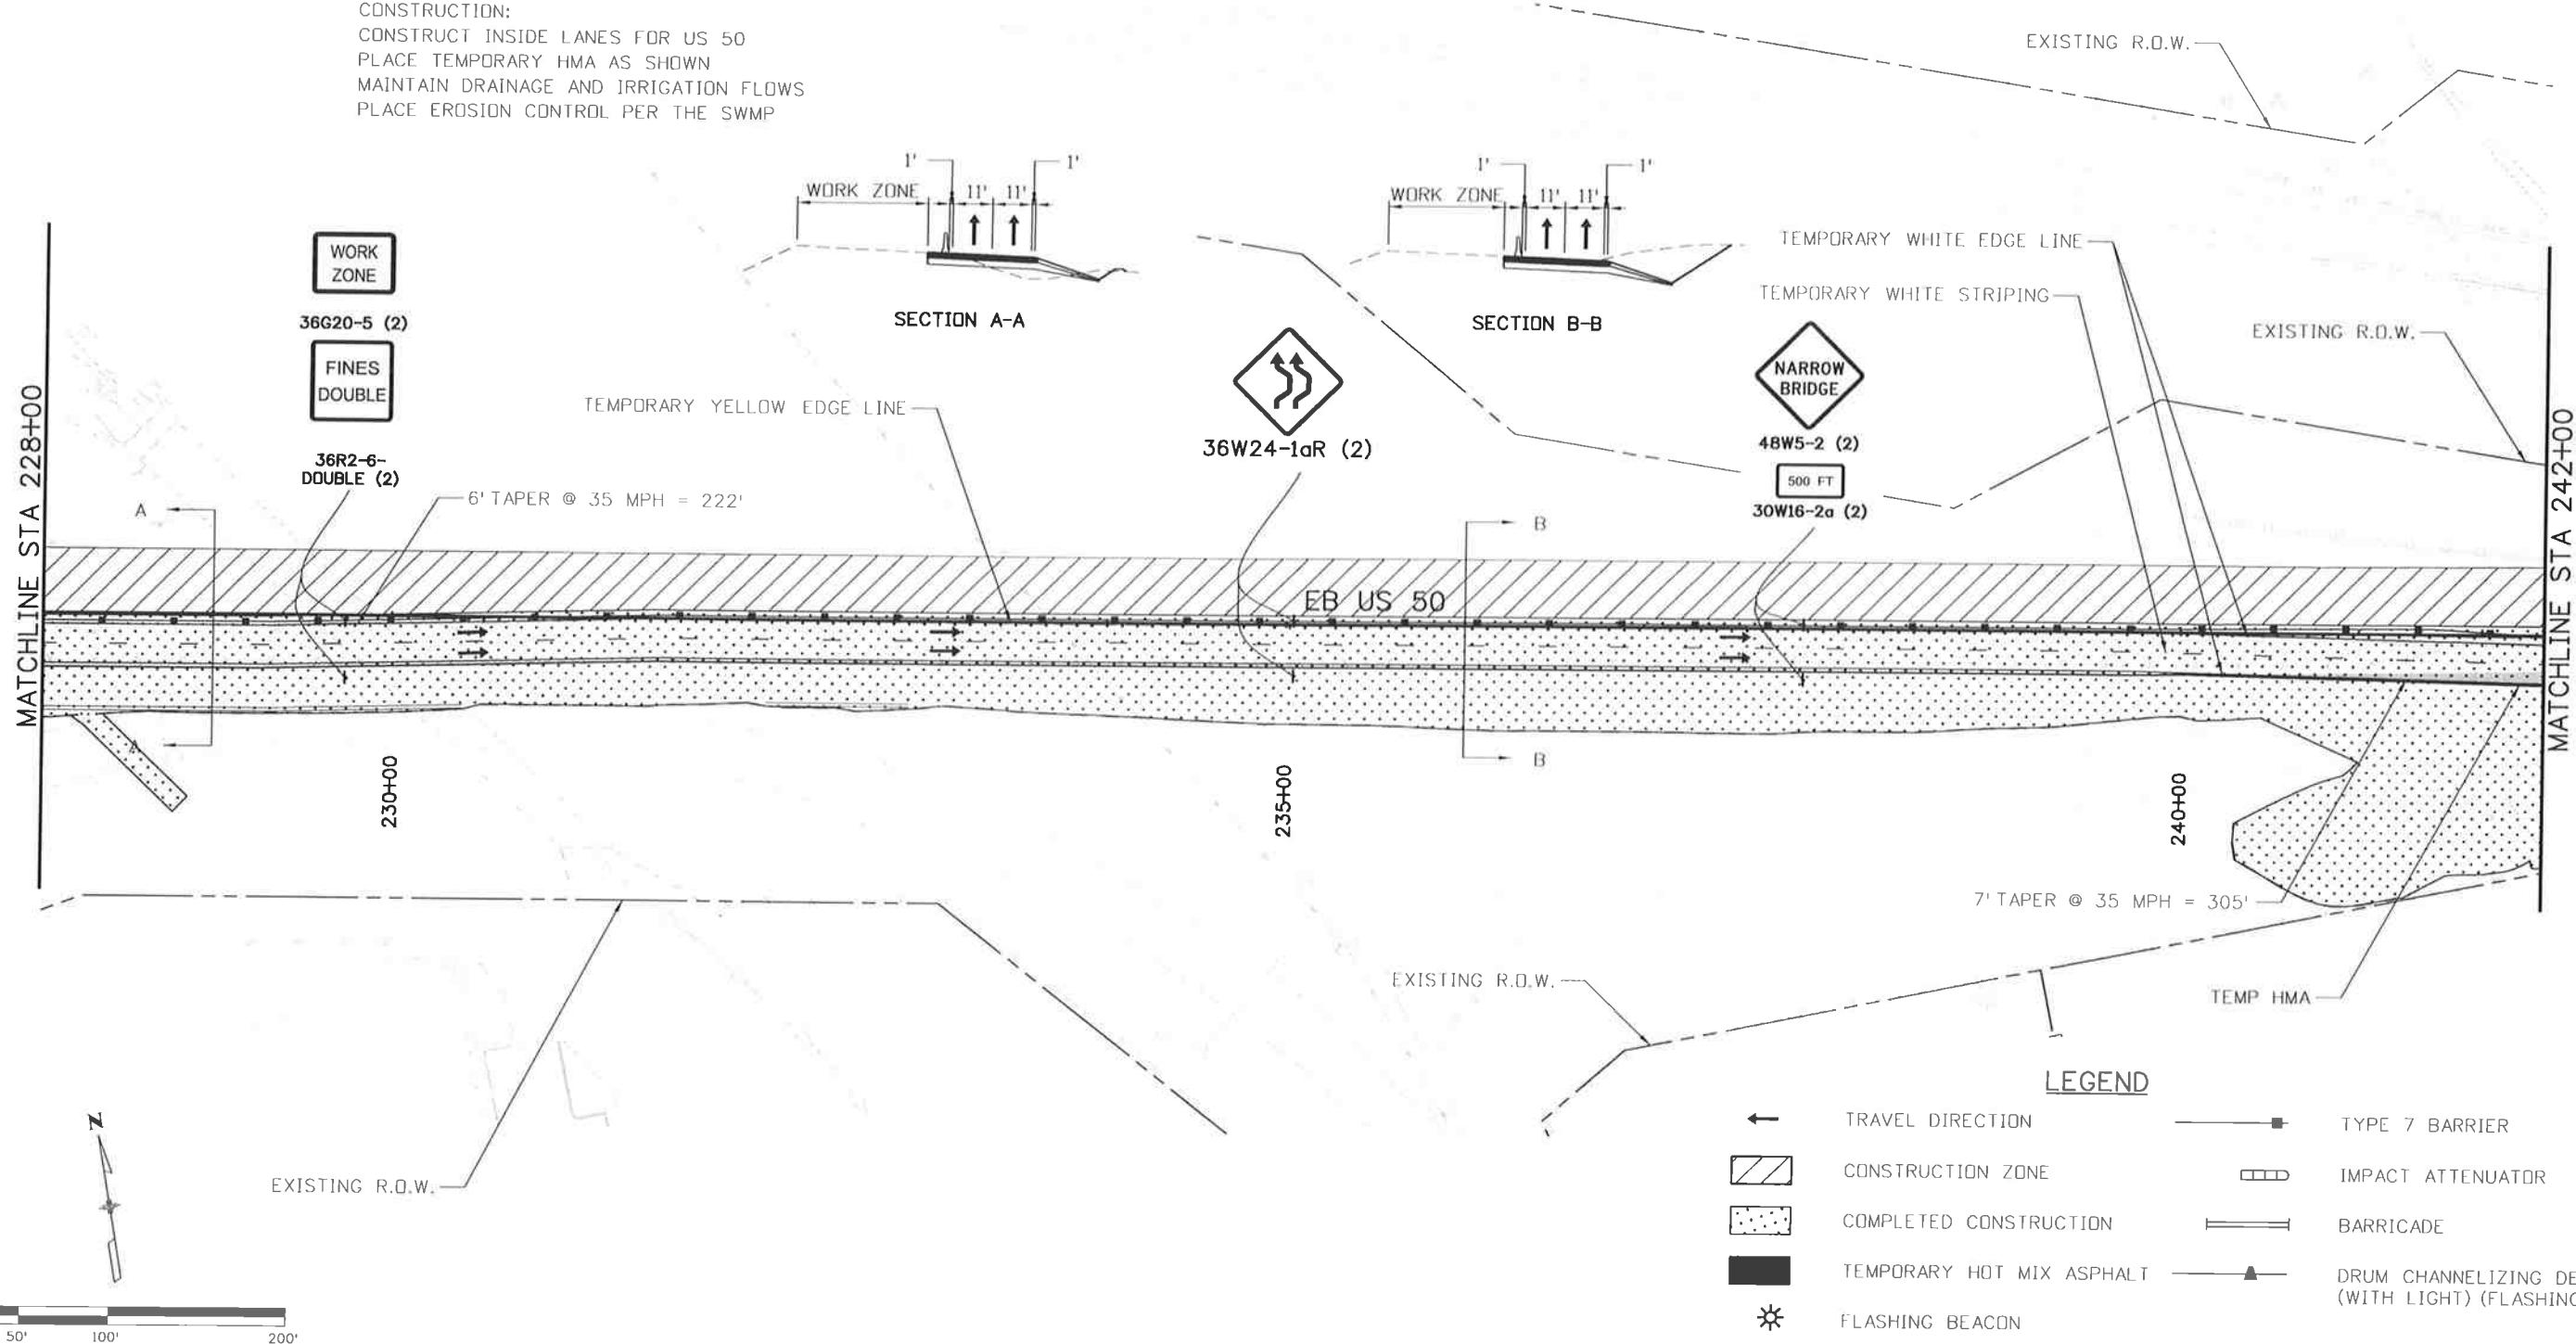
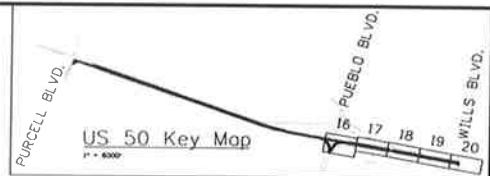
PHASE 2A

TRAFFIC CONTROL:

US 50 ON SHIFTED CONFIGURATION WITH TEMP. WIDENING
MAINTAIN 2 LANES ON US 50 EB

CONSTRUCTION:

CONSTRUCT INSIDE LANES FOR US 50
PLACE TEMPORARY HMA AS SHOWN
MAINTAIN DRAINAGE AND IRRIGATION FLOWS
PLACE EROSION CONTROL PER THE SWMP



Print Date: 10/9/2014

File Name: I9056DES_Construction Phasing2A_12.dgn

Horiz. Scale: 1:100 Vert. Scale: As Noted




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US 50 WEST
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CTC - PHASE 2A

Project No./Code

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Sheet Number 262



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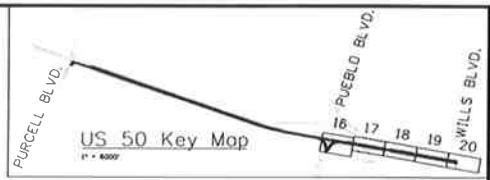
PHASE 2A

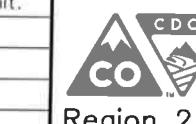TRAFFIC CONTROL:

US 50 TRAFFIC ON SHIFTED CONFIGURATION WITH TEMP. WIDENING
SHIFT TRAFFIC ON WIDENED BRIDGE (SEE BRIDGE CONSTRUCTION STAGING)
MAINTAIN 2 LANES ON US 50 EB

CONSTRUCTION:

CONSTRUCT OUTSIDE LANES FOR US 50
MODIFY EXISTING BRIDGE STATE 3, AS SHOWN IN BRIDGE CONSTRUCTION STAGING
PLACE TEMPORARY HMA AS SHOWN
MAINTAIN DRAINAGE AND IRRIGATION FLOWS
PLACE EROSION CONTROL PER THE SWMP



MOUNT ON BARRICADE
(TYPE 3M) (TEMP)



DIRECTION AS REQUIRED

60W1-6r (2)

SECTION A-A

EXISTING R.O.W.

WORK ZONE

1' 11' 11'

TEMPORARY STRIPING

TEMPORARY YELLOW
EDGE LINE

SECTION A-A

EXISTING R.O.W.

WB US 50

EB US 50

255+00

250+00

245+00

7' TAPER @ 35 MPH = 305'

10' TAPER @ 35 MPH = 151"

5' TAPER @ 35 MPH = 253'

SECTION A-A

CLOSE OFF ACCESS

SECTION A-A

CLOSE OFF ACCESS

SECTION A-A

EXISTING R.O.W.

WB US 50

EB US 50

255+00

250+00

245+00

7' TAPER @ 35 MPH = 305'

10' TAPER @ 35 MPH = 151"

5' TAPER @ 35 MPH = 253'

SECTION A-A

CLOSE OFF ACCESS

SECTION A-A

CLOSE OFF ACCESS

SECTION A-A

EXISTING R.O.W.

WB US 50

EB US 50

255+00

250+00

245+00

7' TAPER @ 35 MPH = 305'

10' TAPER @ 35 MPH = 151"

5' TAPER @ 35 MPH = 253'

SECTION A-A

CLOSE OFF ACCESS

SECTION A-A

CLOSE OFF ACCESS

SECTION A-A

EXISTING R.O.W.

WB US 50

EB US 50

255+00

250+00

245+00

7' TAPER @ 35 MPH = 305'

10' TAPER @ 35 MPH = 151"

5' TAPER @ 35 MPH = 253'

SECTION A-A

CLOSE OFF ACCESS

SECTION A-A

CLOSE OFF ACCESS

SECTION A-A

EXISTING R.O.W.

WB US 50

EB US 50

255+00

250+00

245+00

7' TAPER @ 35 MPH = 305'

10' TAPER @ 35 MPH = 151"

5' TAPER @ 35 MPH = 253'

SECTION A-A

CLOSE OFF ACCESS

SECTION A-A

CLOSE OFF ACCESS

SECTION A-A

EXISTING R.O.W.

WB US 50

EB US 50

255+00

250+00

245+00

7' TAPER @ 35 MPH = 305'

10' TAPER @ 35 MPH = 151"

5' TAPER @ 35 MPH = 253'

SECTION A-A

CLOSE OFF ACCESS

SECTION A-A

CLOSE OFF ACCESS

SECTION A-A

EXISTING R.O.W.

WB US 50

EB US 50

255+00

250+00

245+00

7' TAPER @ 35 MPH = 305'

10' TAPER @ 35 MPH = 151"

5' TAPER @ 35 MPH = 253'

SECTION A-A

CLOSE OFF ACCESS

SECTION A-A

CLOSE OFF ACCESS

SECTION A-A

EXISTING R.O.W.

WB US 50

EB US 50

255+00

250+00

245+00

7' TAPER @ 35 MPH = 305'

10' TAPER @ 35 MPH = 151"

5' TAPER @ 35 MPH = 253'

SECTION A-A

CLOSE OFF ACCESS

SECTION A-A

CLOSE OFF ACCESS

SECTION A-A

EXISTING R.O.W.

WB US 50

EB US 50

255+00

250+00

245+00

7' TAPER @ 35 MPH = 305'

10' TAPER @ 35 MPH = 151"

5' TAPER @ 35 MPH = 253'

SECTION A-A

CLOSE OFF ACCESS

SECTION A-A

CLOSE OFF ACCESS

SECTION A-A

EXISTING R.O.W.

WB US 50

EB US 50

255+00

250+00

245+00

7' TAPER @ 35 MPH = 305'

10' TAPER @ 35 MPH = 151"

5' TAPER @ 35 MPH = 253'

SECTION A-A

CLOSE OFF ACCESS

SECTION A-A

CLOSE OFF ACCESS

SECTION A-A

EXISTING R.O.W.

WB US 50

EB US 50

255+00

250+00

245+00

7' TAPER @ 35 MPH = 305'

10' TAPER @ 35 MPH = 151"

5' TAPER @ 35 MPH = 253'

SECTION A-A

CLOSE OFF ACCESS

SECTION A-A

CLOSE OFF ACCESS

SECTION A-A

EXISTING R.O.W.

WB US 50

EB US 50

255+00

250+00

245+00

7' TAPER @ 35 MPH = 305'

10' TAPER @ 35 MPH = 151"




**Know what's below.
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PHASE 2A

TRAFFIC CONTROL:
US 50 TRAFFIC ON SHIFTED CONFIGURATION
MAINTAIN 2 LANES ON US 50 EB

CONSTRUCTION



CONSTRUCT INSIDE LANES FOR US 50
MAINTAIN DRAINAGE AND IRRIGATION FLOWS
PLACE EROSION CONTROL PER THE SWMP

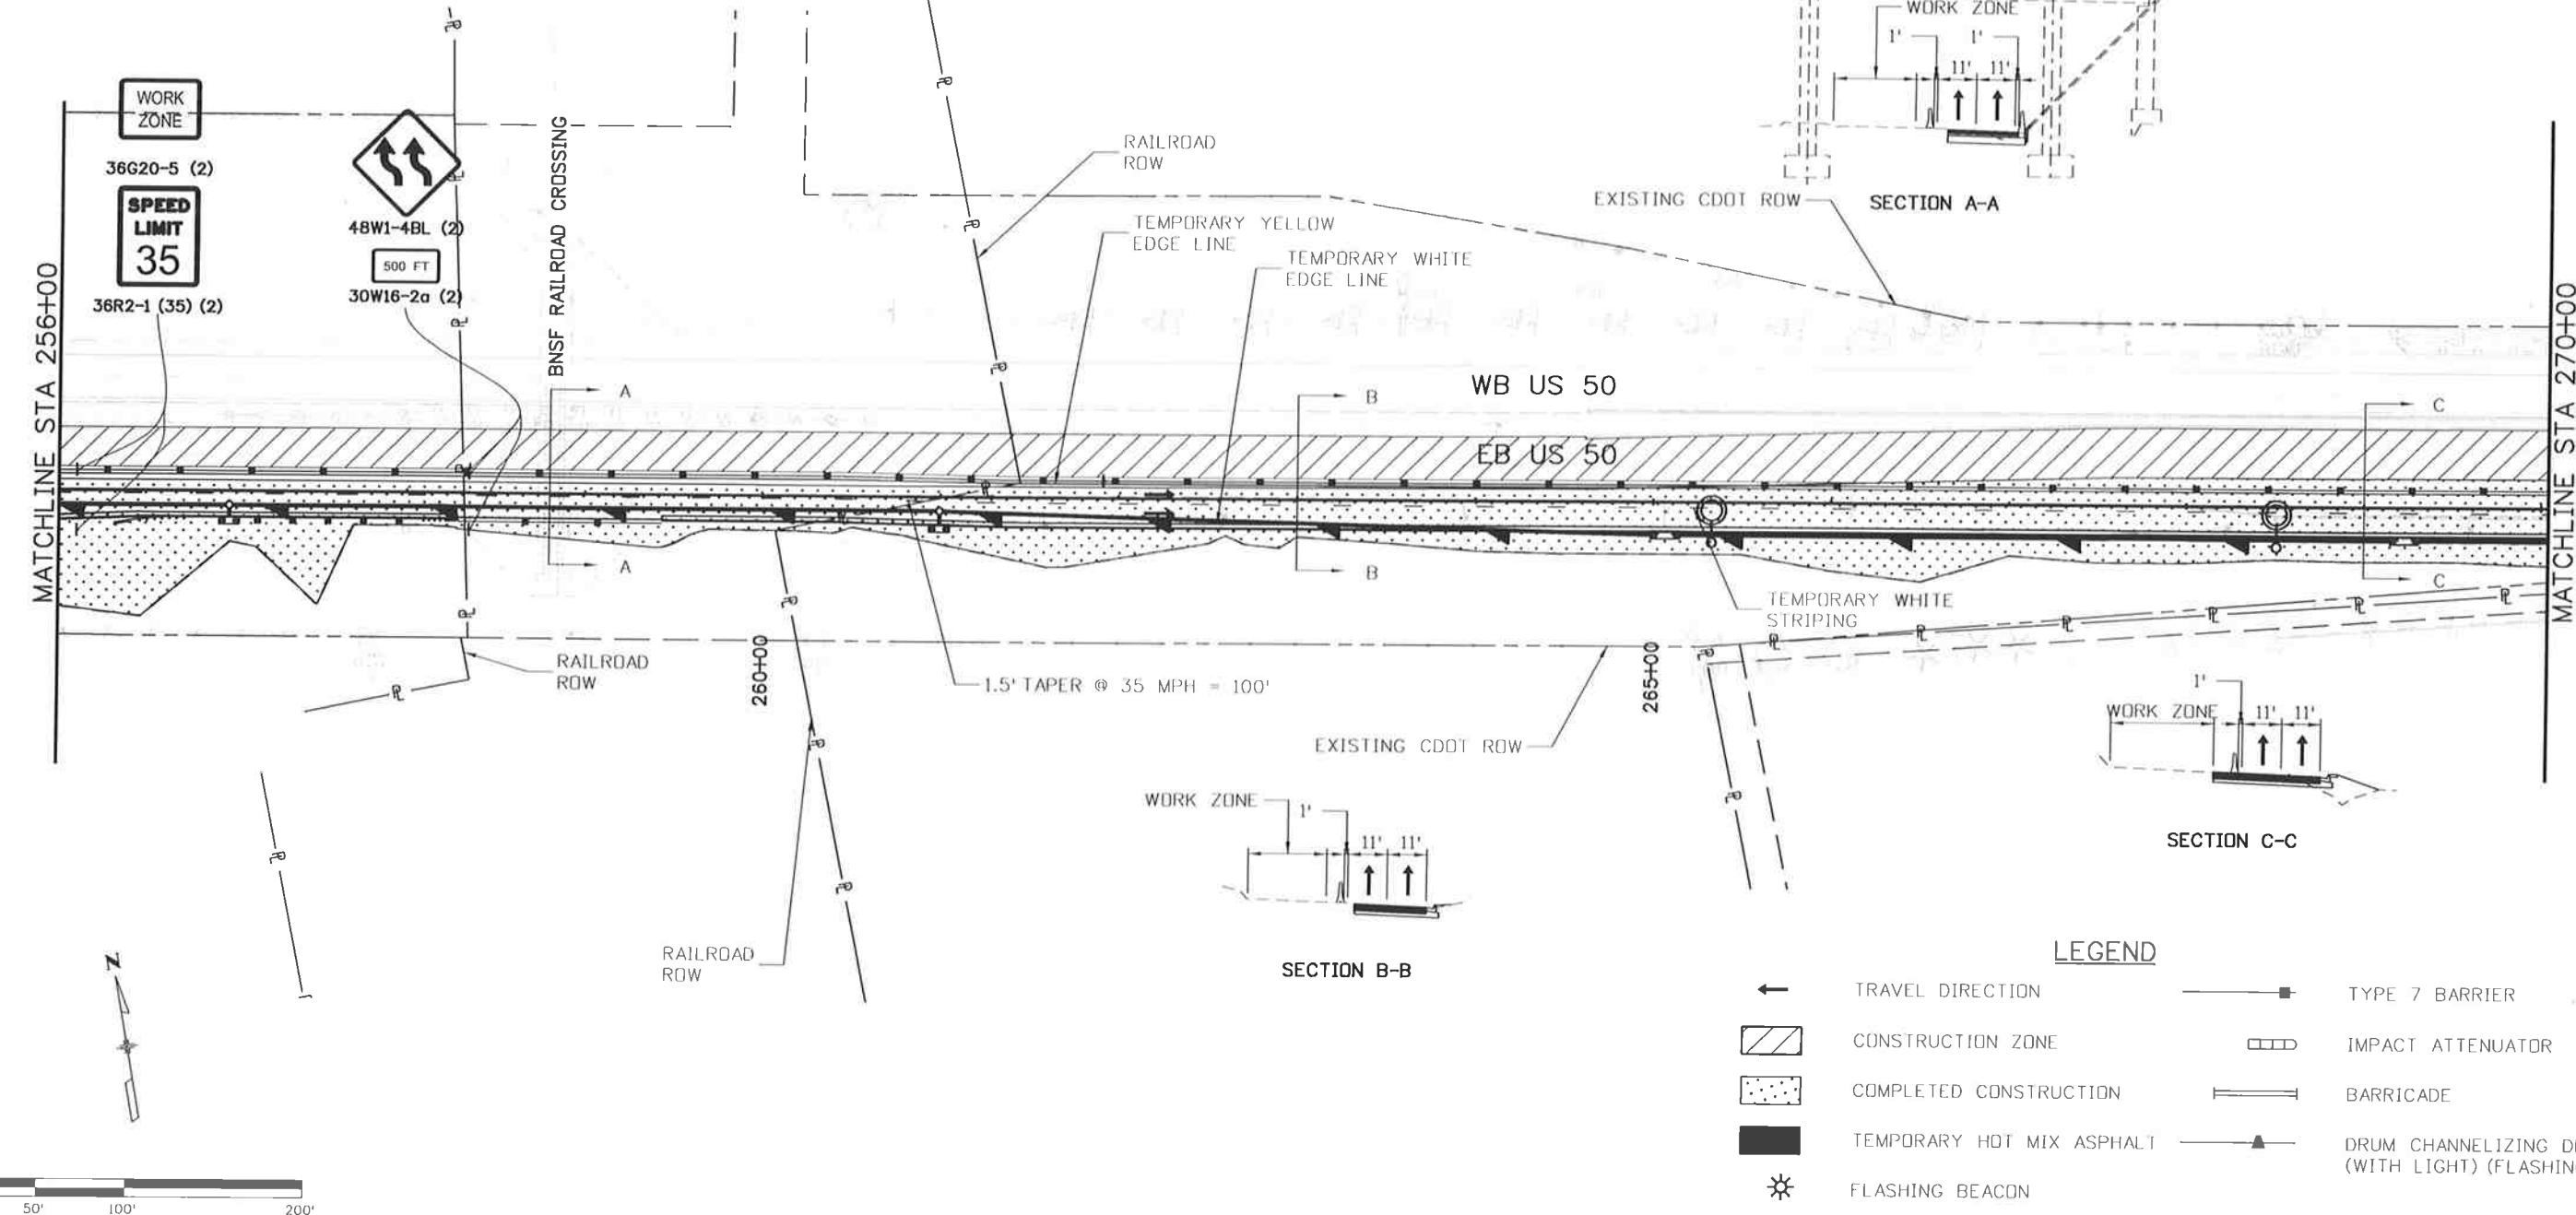

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Horiz. Scale: 1:100	Vert. Scale: As Noted		Date:	Comments	Init.						
JFS & A	J. F. SATO AND ASSOCIATES 5898 South Rapp Street Littleton, Colorado 80120										
									Designer: AB	Structure Numbers	
									Detailer: AB		
									Subset: CT	Subset Sheets: CT19 of 33	



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US 50 WEST
PURCELL BLVD. TO WILLS BLVD.
CTC - PHASE 2A

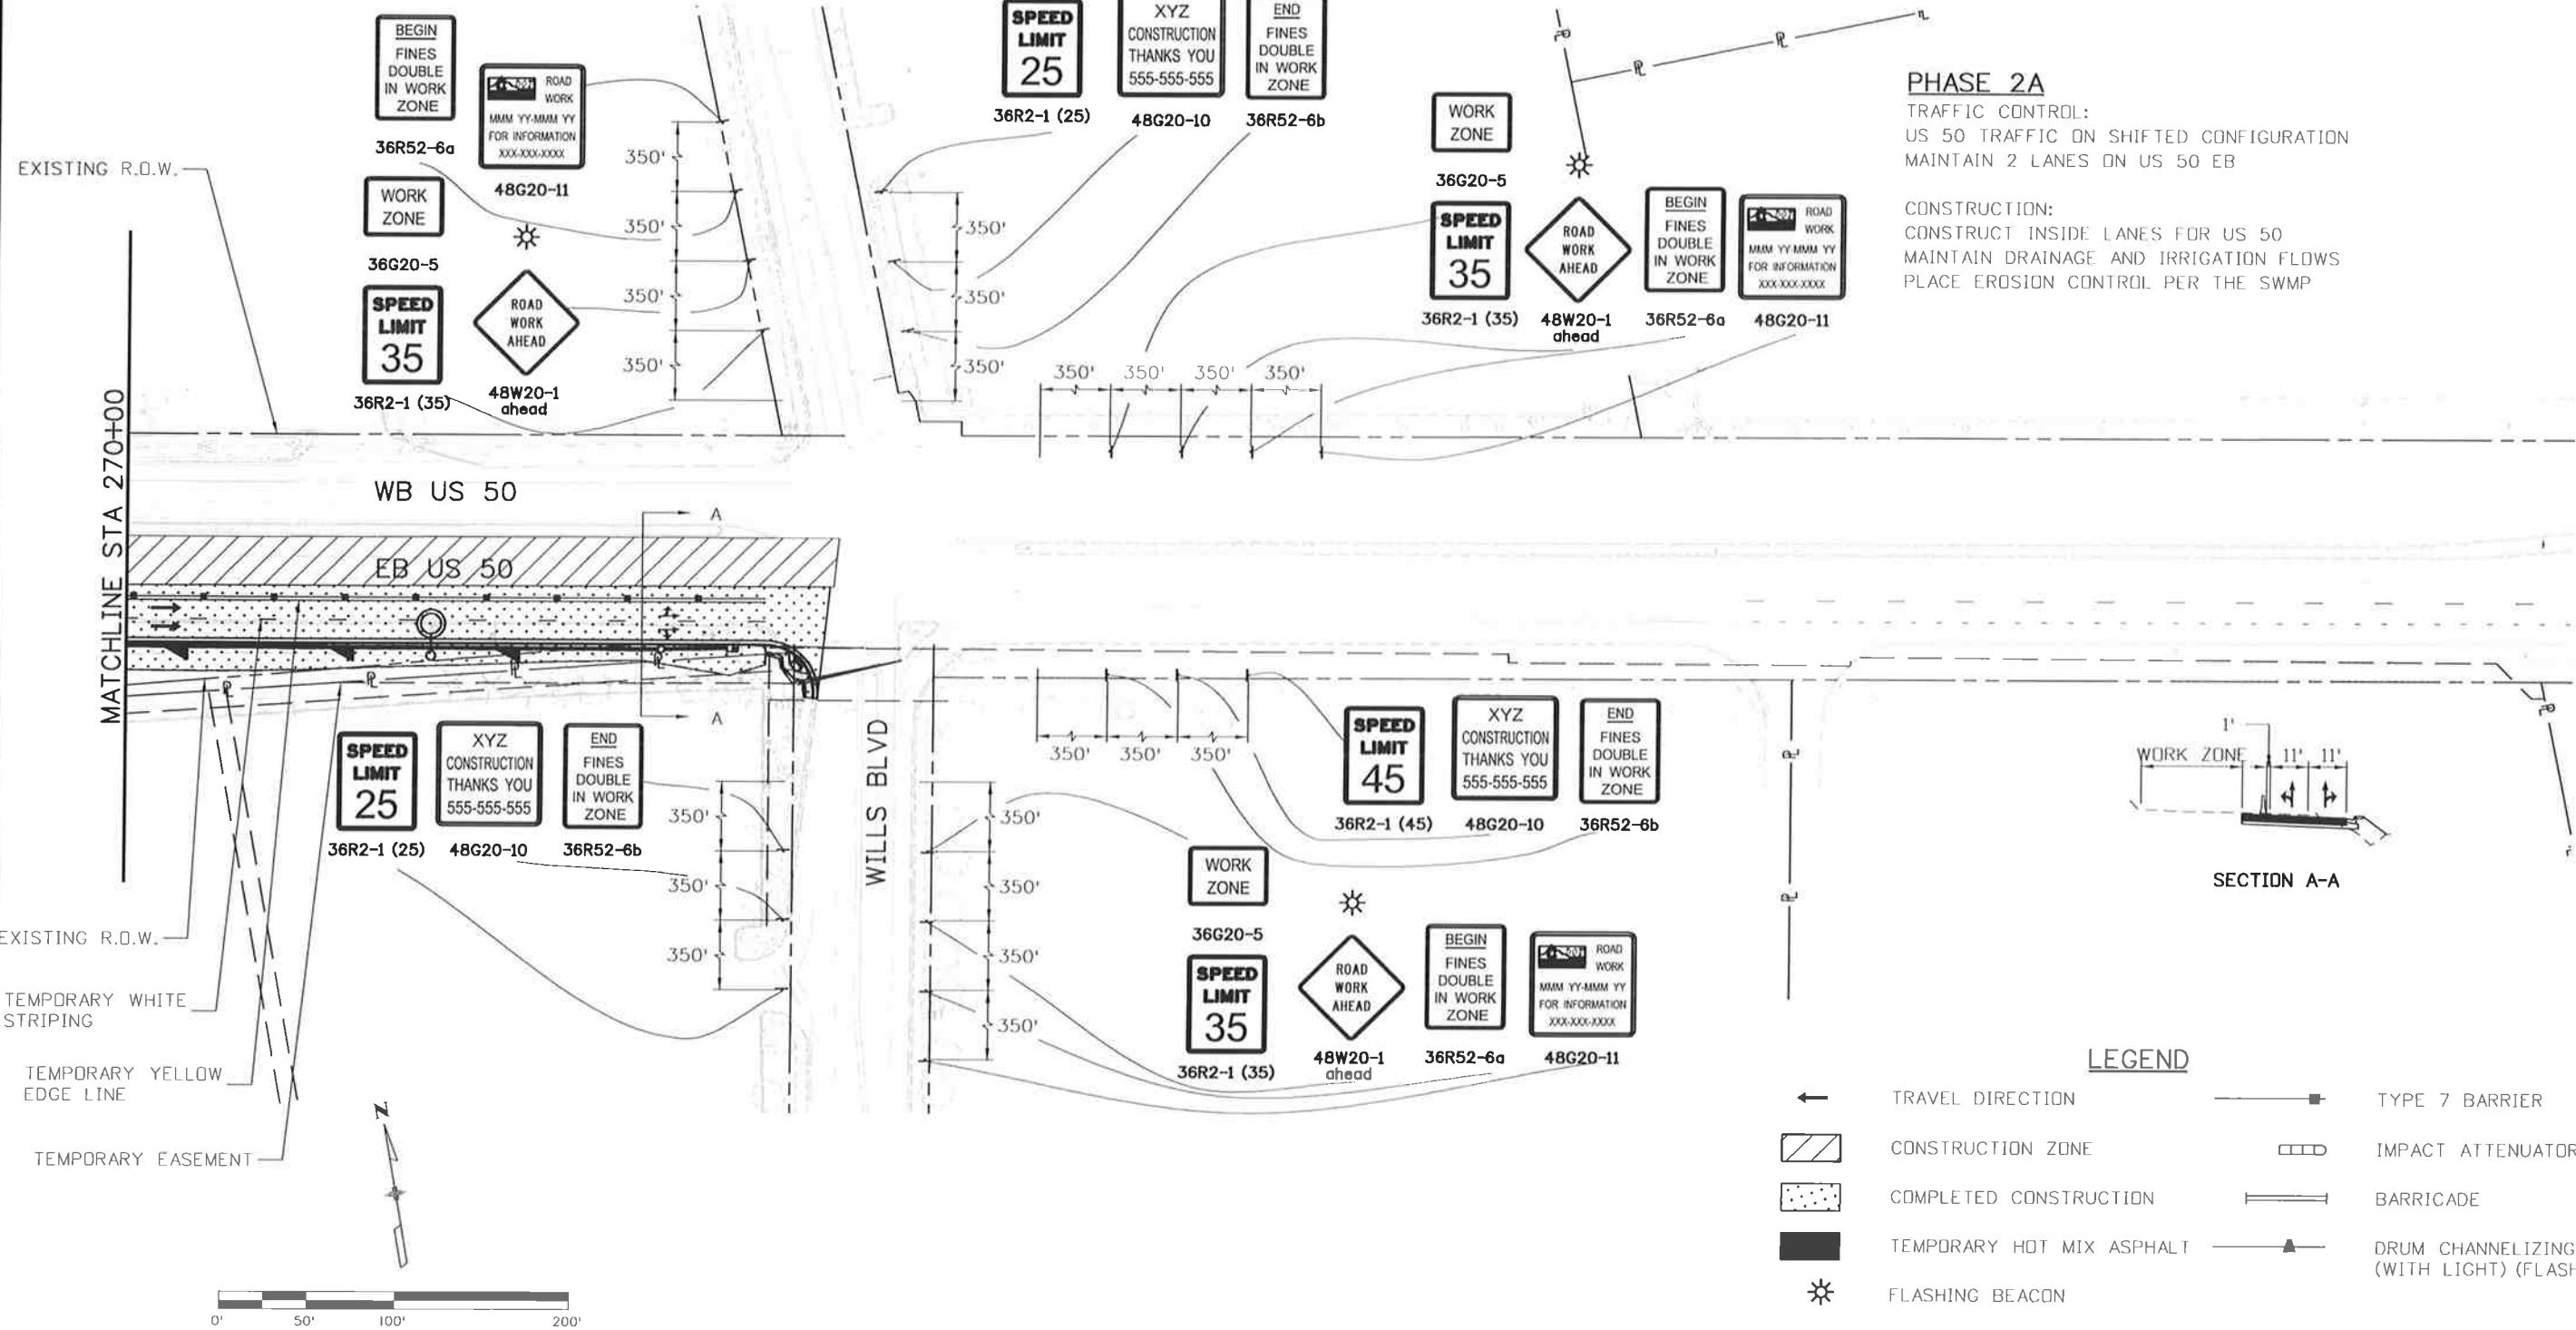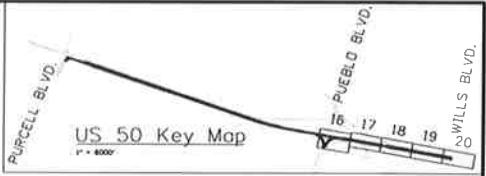Project No./Code

FSA 0503-081

19751


Sheet Number 265

Subset Sheets: CT20 of 33

PHASE 2A

TRAFFIC CONTROL:
US 50 TRAFFIC ON SHIFTED CONFIGURATION
MAINTAIN 2 LANES ON US 50 EB

CONSTRUCTION:
CONSTRUCT INSIDE LANES FOR US 50
MAINTAIN DRAINAGE AND IRRIGATION FLOWS
PLACE EROSION CONTROL PER THE SWMP

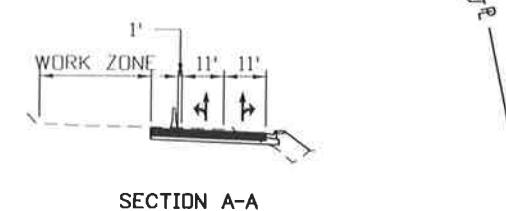

LEGEND

	TRAVEL DIRECTION		TYPE 7 BARRIER
	CONSTRUCTION ZONE		IMPACT ATTENUATOR
	COMPLETED CONSTRUCTION		BARRICADE
	TEMPORARY HOT MIX ASPHALT		DRUM CHANNELIZING DEVICE (WITH LIGHT) (FLASHING)
	FLASHING BEACON		





**Know what's below.
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PHASE 2B

TRAFFIC CONTROL:
US 50 TRAFFIC ON NEW CONFIGURATION

CONSTRUCTION:
MAINTAIN DRAINAGE AND IRRIGATION FLOWS
PLACE EROSION CONTROL PER THE SWMP

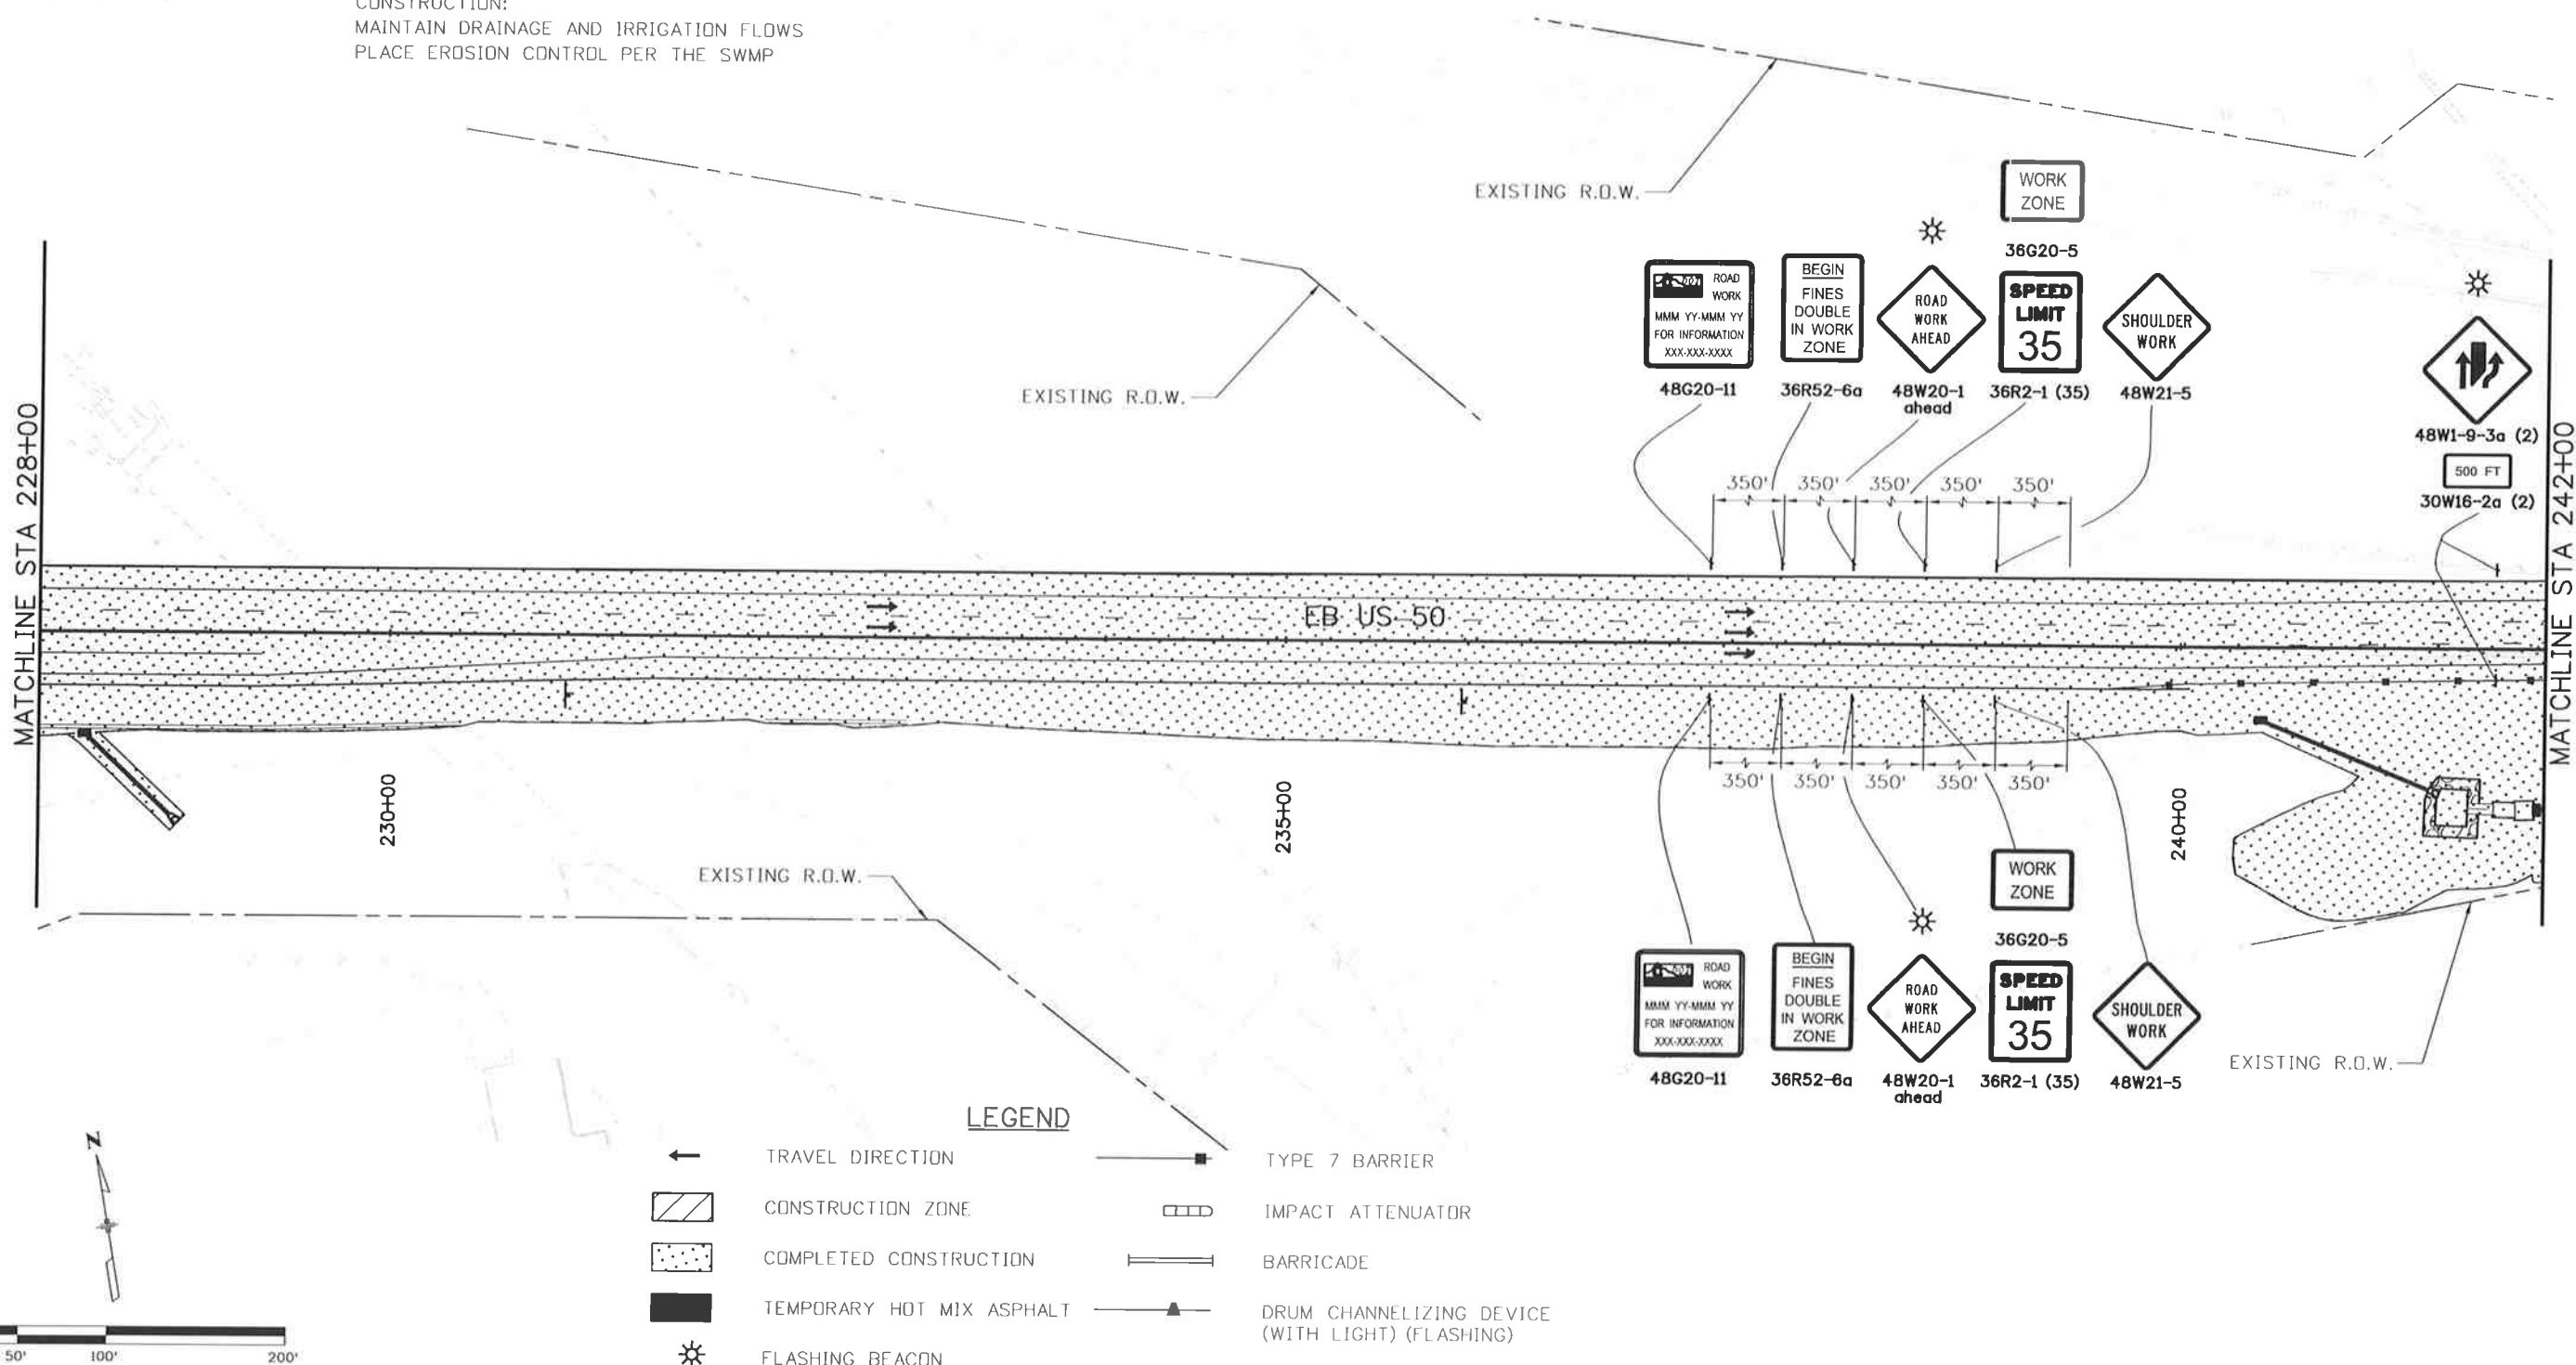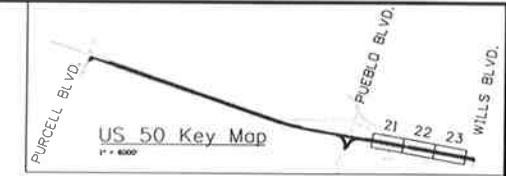

Print Date: 10/9/2014

File Name: 19056DES_Construction Phasing2B_2.dgn

Horiz. Scale: 1:100 Vert. Scale: As Noted



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CTC - PHASE 2B

Project No./Code

FSA 0503-081

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Sheet Number 266



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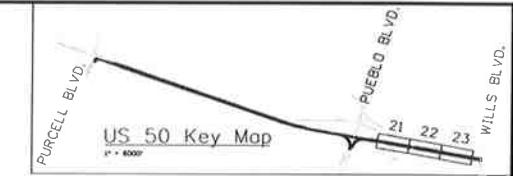
PHASE 2B

TRAFFIC CONTROL:

US 50 TRAFFIC ON NEW CONFIGURATION
SHIFTED FROM 3 LANES TO 2 LANES ON EB

CONSTRUCTION:


CONSTRUCT MIDDLE LANE FOR US 50 FROM STA 254+22 TO STA 266+22
MAINTAIN DRAINAGE AND IRRIGATION FLOWS
PLACE EROSION CONTROL PER THE SWMP
COMPLETE BRIDGE STAGE 4 & 5 (SEE BRIDGE CONSTRUCTION STAGING)



MOUNT ON BARRICADE
(TYPE 3M) (TEMP)



DIRECTION AS REQUIRED

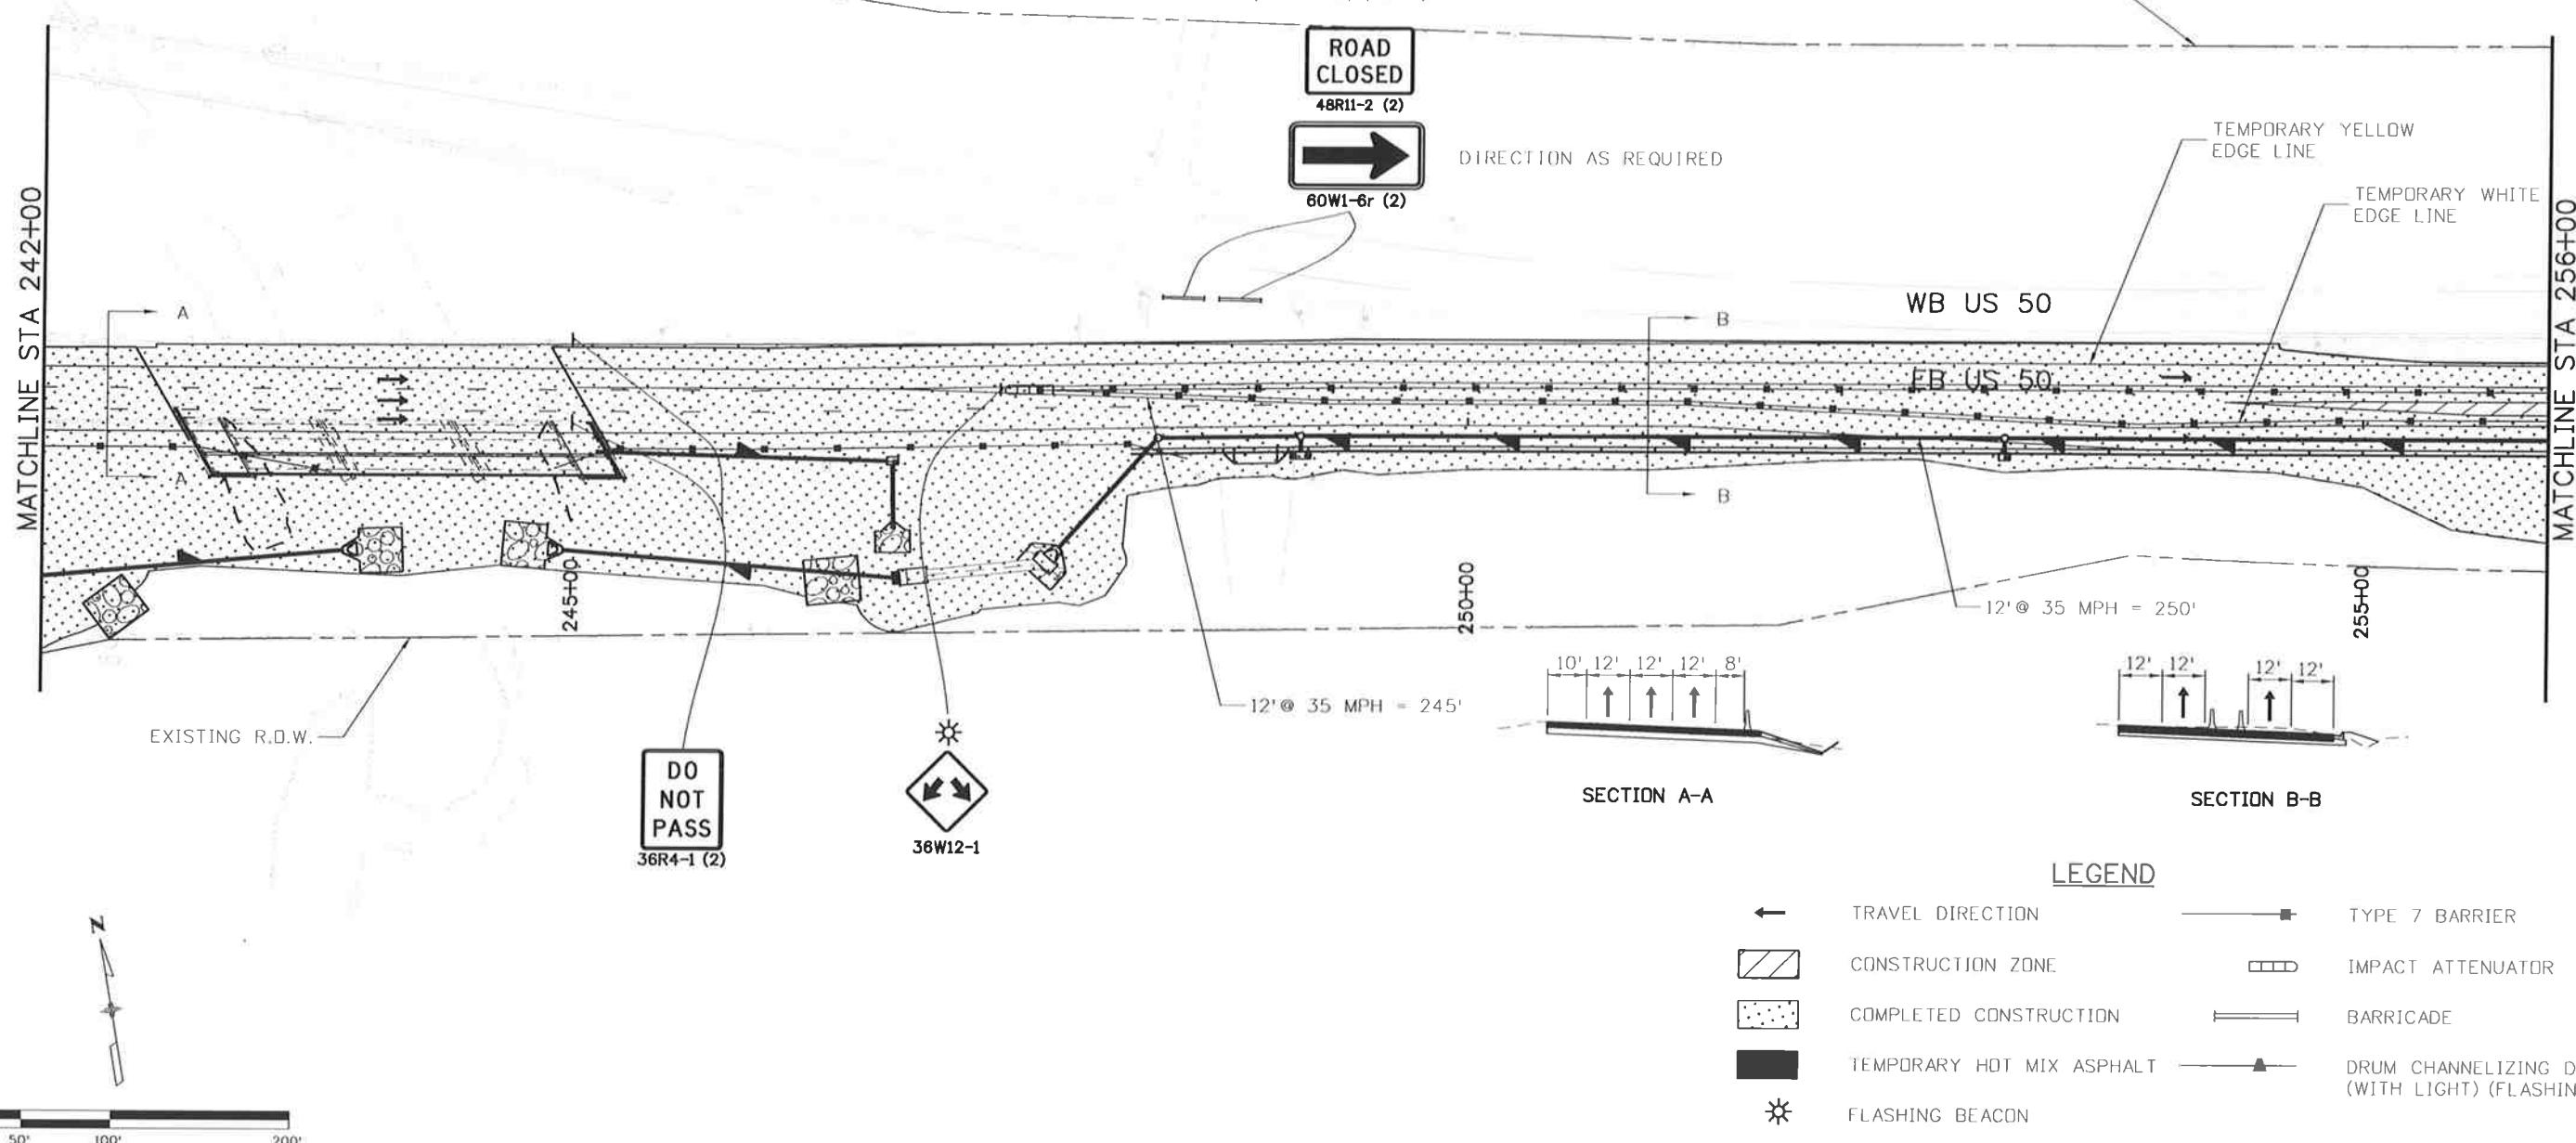

LEGEND

	TRAVEL DIRECTION		TYPE 7 BARRIER
	CONSTRUCTION ZONE		IMPACT ATTENUATOR
	COMPLETED CONSTRUCTION		BARRICADE
	TEMPORARY HOT MIX ASPHALT		DRUM CHANNELIZING DEVICE (WITH LIGHT) (FLASHING)
	FLASHING BEACON		

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CTC - PHASING 2B

Project No./Code

FSA 0503-081

19751

Sheet Number 267

DTD

Designer:	AB	Structure
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Detailer:	AB	Numbers
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Subsel:	CT	Subset Sheets: CT22 of 33
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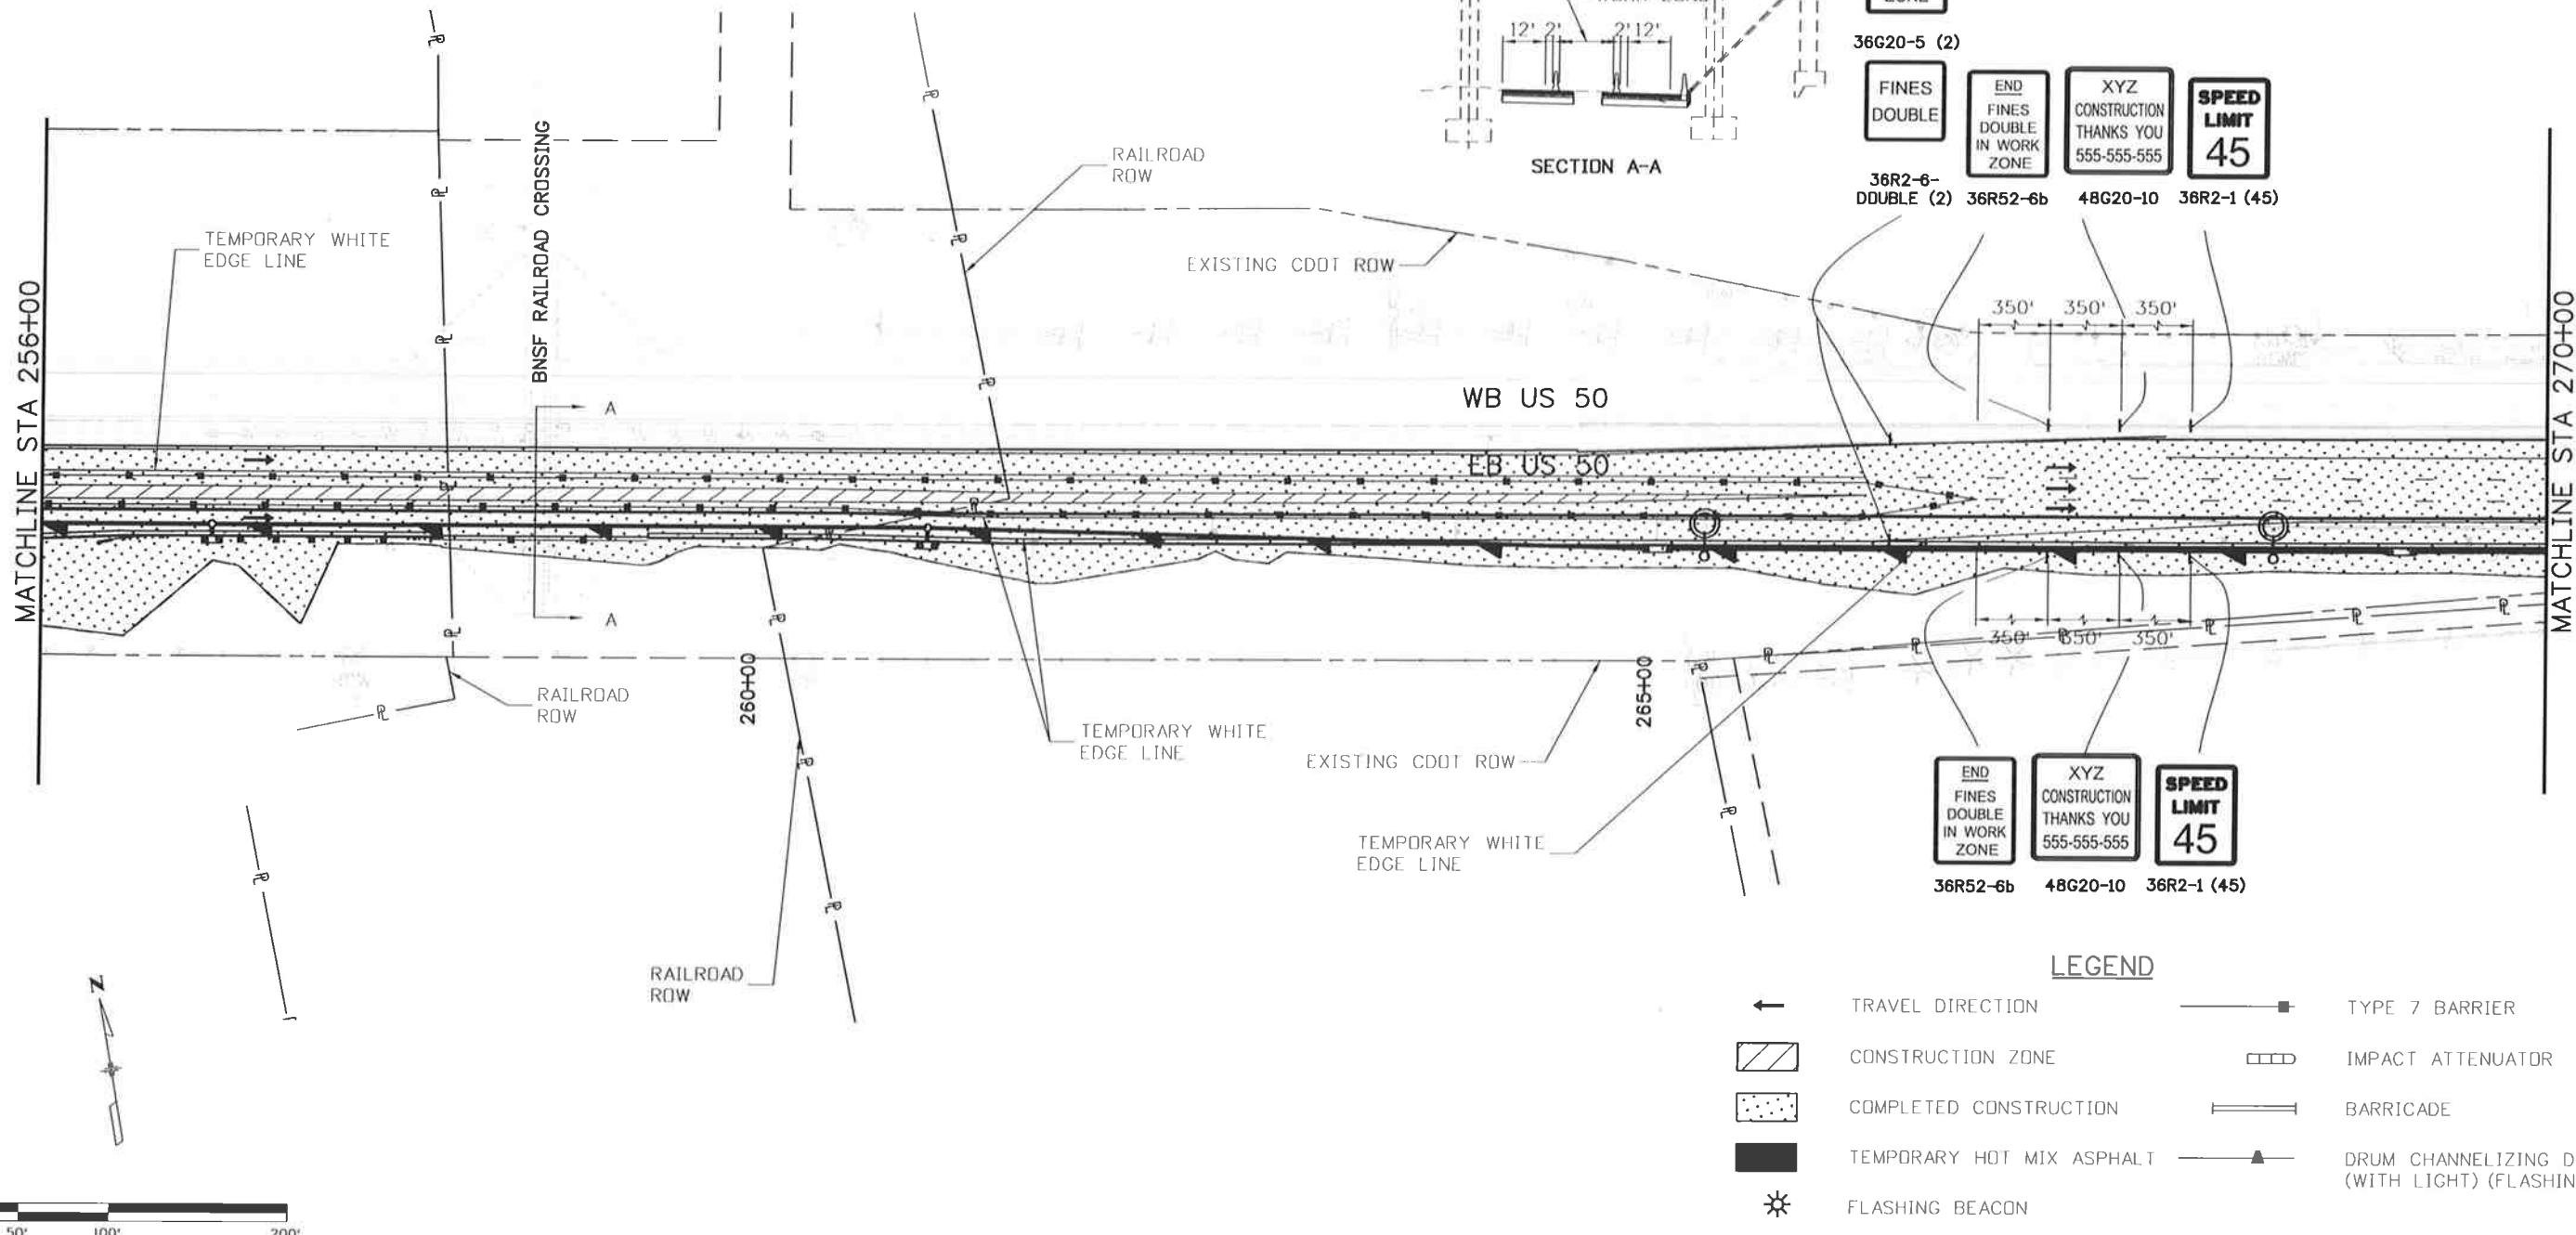
**Know what's below.
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PHASE 2B

TRAFFIC CONTROL:
US 50 TRAFFIC ON NEW CONFIGURATION
MAINTAIN 2 LANES ON EB

CONSTRUCTION:

CONSTRUCT MIDDLE LANE FOR US 50 FROM STA 254+22 TO STA 266+22
MAINTAIN DRAINAGE AND IRRIGATION FLOWS
PLACE EROSION CONTROL PER THE SWMP



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File Name: 19056DES_Construction Phasing2B_4.dgn

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Void:


US 50 WEST
PURCELL BLVD. TO WILLS BLVD.
CTC - PHASE 2B

Project No./Code

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Sheet Number 268



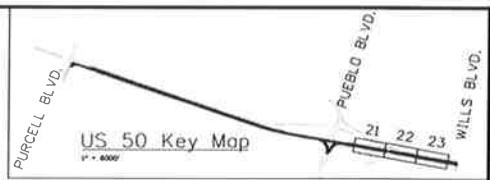

**Know what's below.
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0' 50' 100' 200'


PHASE 3

TRAFFIC CONTROL:

TRAFFIC ON NEW NBR TURN LANE AT PURCELL BLVD.
TRAFFIC ON EXISTING AND NEW LANES
MAINTAIN 2 LANES ON US 50 EB


CONSTRUCTION:

WIDEN US 50 INTO MEDIAN AS SHOWN FROM STA 105+59 TO STA 196+15
MAINTAIN DRAINAGE AND IRRIGATION FLOWS
PLACE EROSION CONTROL PER THE SWMP

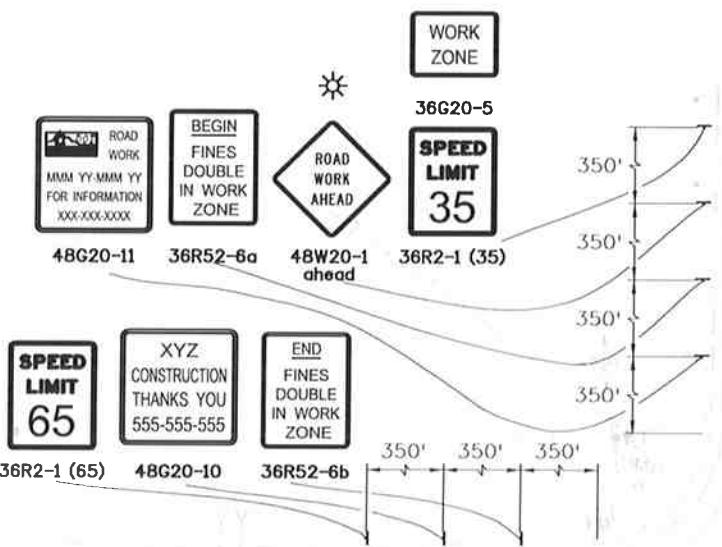

WB US 50

EB US 50


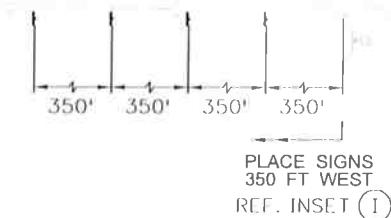


EXISTING R.O.W.

LEGEND

- ← TRAVEL DIRECTION
- TYPE 7 BARRIER
- ▨ CONSTRUCTION ZONE
- ▨▨▨▨ IMPACT ATTENUATOR
- COMPLETED CONSTRUCTION
- BARRICADE
- TEMPORARY HOT MIX ASPHALT
- DRUM CHANNELIZING DEVICE (WITH LIGHT) (FLASHING)
- ☀ FLASHING BEACON

PURCELL BLVD

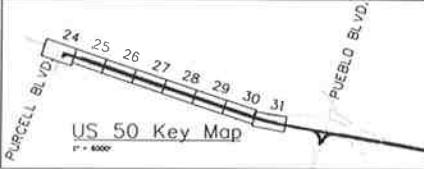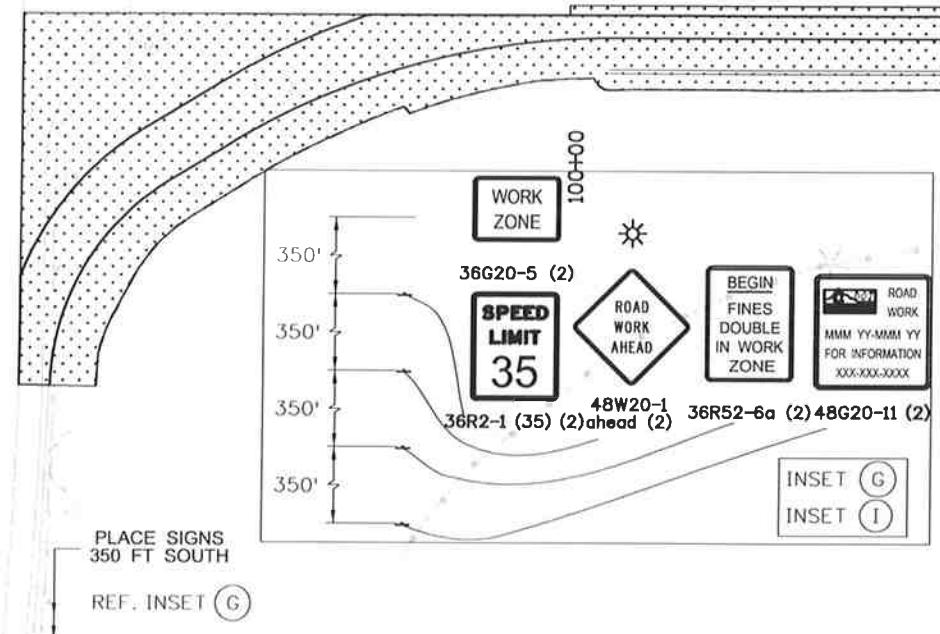

MATCHLINE STA 102+00

Print Date: 10/9/2014

File Name: 19056DES_Construction Phasing3_1.dgn

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Revised:

Void:

US 50 WEST
PURCELL BLVD. TO WILLS BLVD.
CTC - PHASE 3

Project No./Code

FSA 0503-081

19751

Sheet Number 269

Designer:	AB	Structure Numbers
Deleiler:	AB	Subset:
Subset:	CT	Subsel Sheets: CT24 of 33





**Know what's below.
Call before you dig.**

PHASE 3

TRAFFIC CONTROL:
TRAFFIC ON EXISTING AND NEW LANES
MAINTAIN 2 LANES ON US 50 EB

CONSTRUCTION:
WIDEN US 50 INTO MEDIAN AS SHOWN FROM STA 105+59 TO STA 196+15
MAINTAIN DRAINAGE AND IRRIGATION FLOWS
PLACE EROSION CONTROL PER THE SWMP

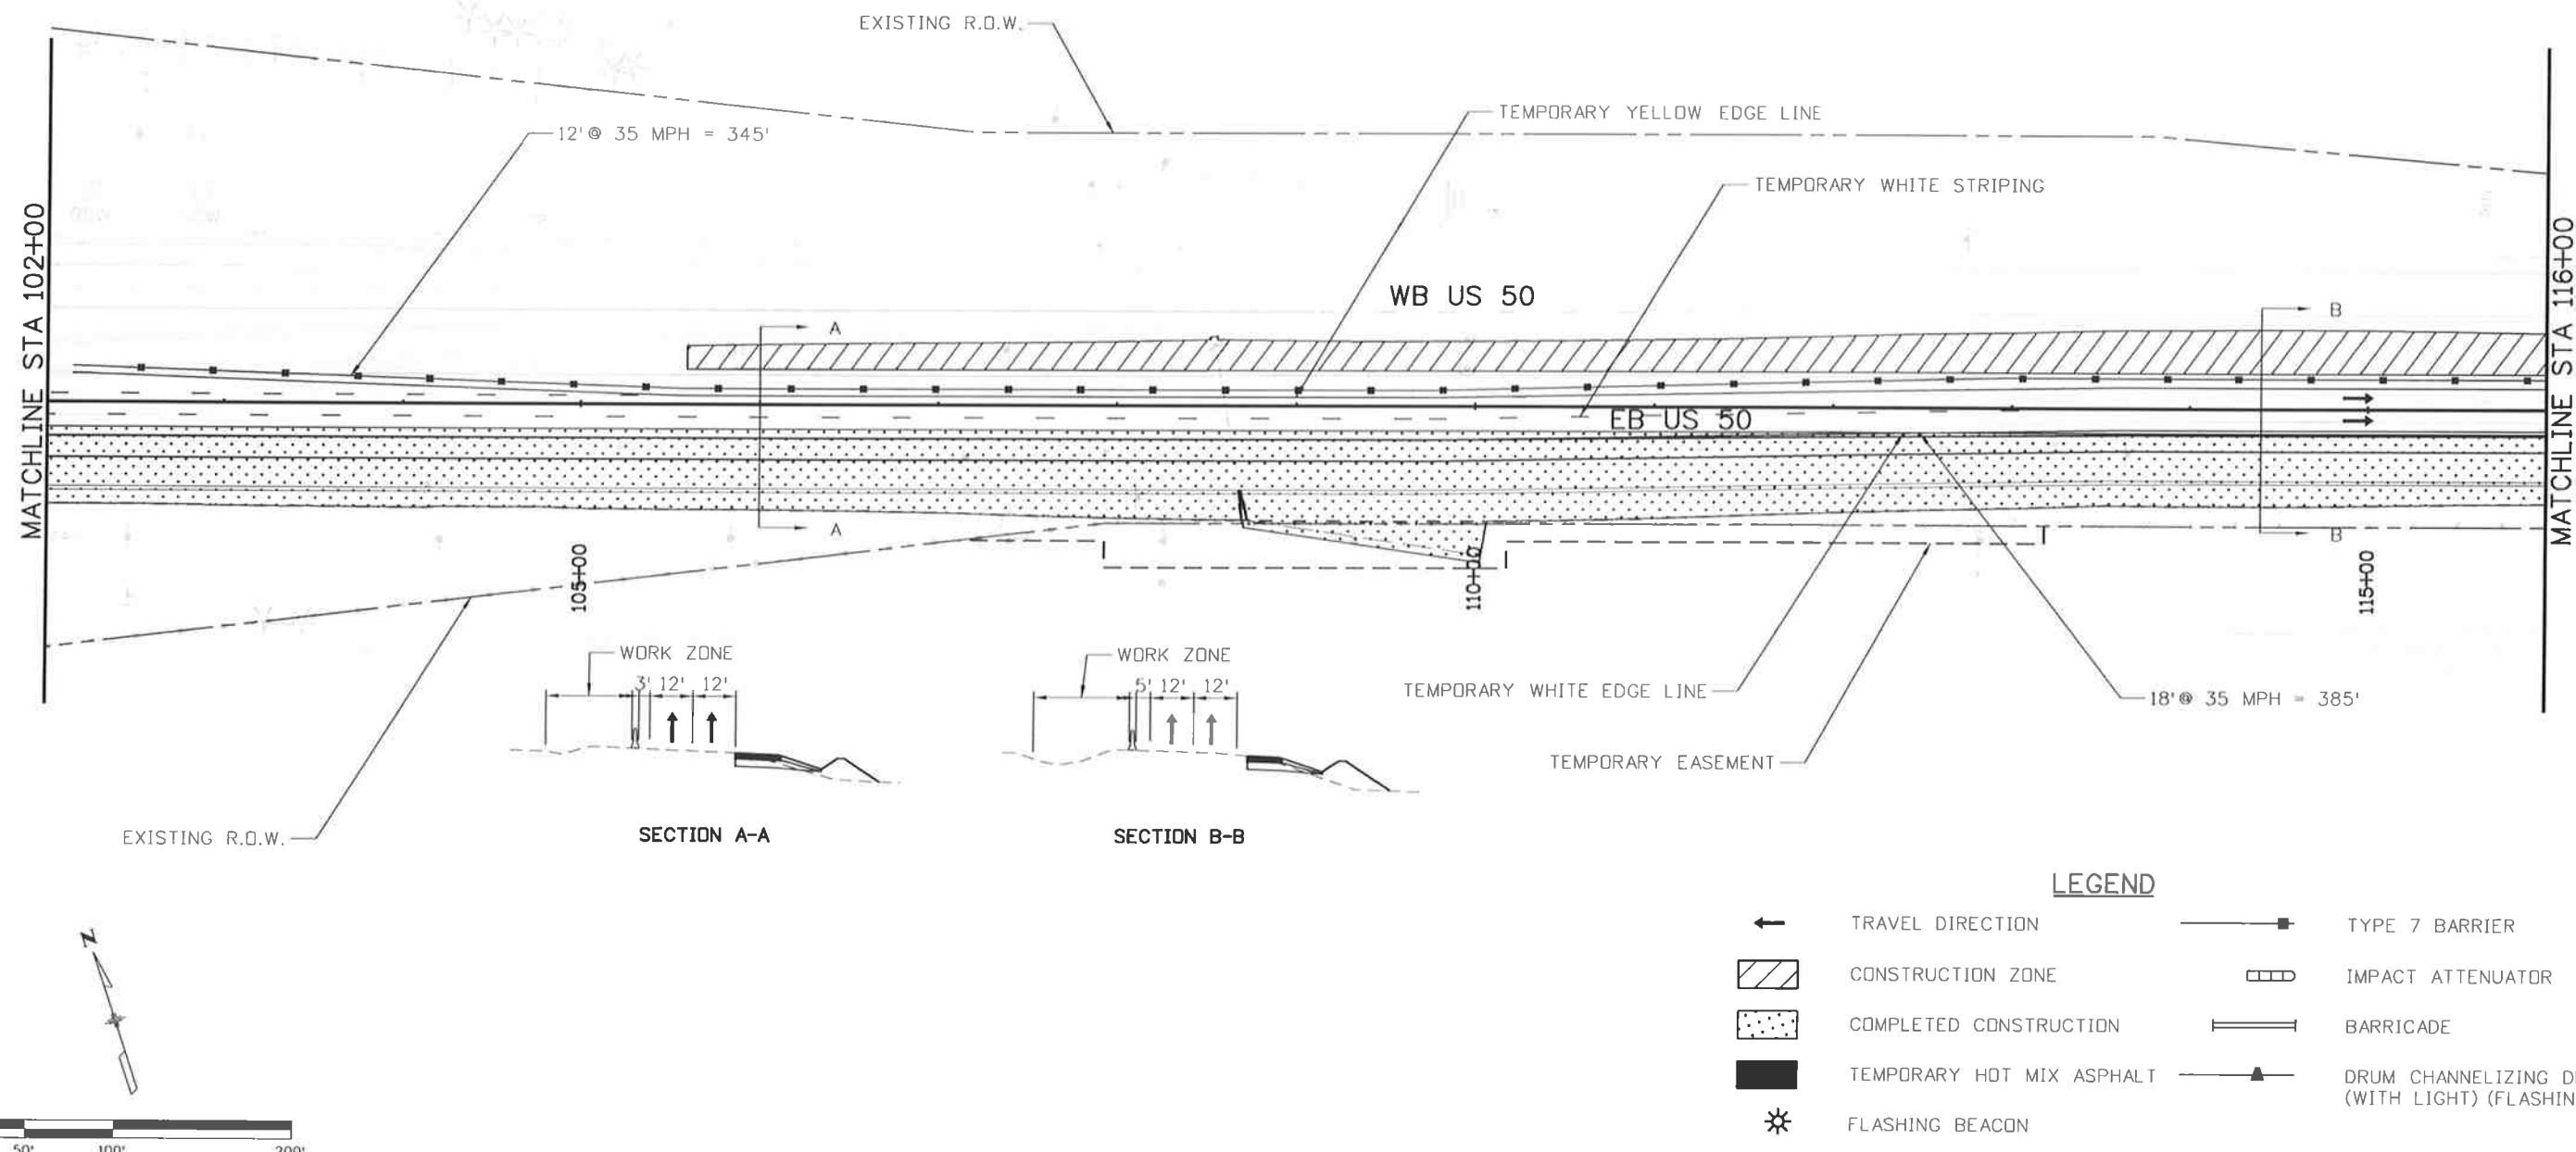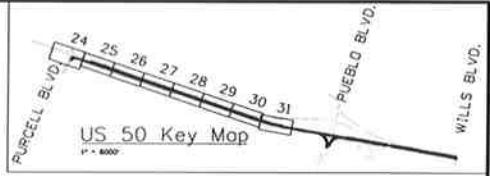

Print Date: 10/9/2014

File Name: 19056DES_Construction Phasing3_2.dgn

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Colorado Department of Transportation
Region 2
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902 Erie Avenue
Pueblo, CO 81001
Phone: 719-562-5509 FAX: 719-546-5702

As Constructed
No Revisions:
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US 50 WEST
PURCELL BLVD. TO WILLS BLVD.
CTC - PHASING 3

Project No./Code
FSA 0503-081
19751
Sheet Number 270

DTD





**Know what's below.
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PHASE 3

TRAFFIC CONTROL:
TRAFFIC ON EXISTING AND NEW LANES
MAINTAIN 2 LANES ON US 50 EB

CONSTRUCTION

WIDEN US 50 INTO MEDIAN AS SHOWN FROM STA 105+59 TO STA 196+15
EXTEND CROSS PIPE AND ADD NEW MEDIAN INLET AS SHOWN
MAINTAIN DRAINAGE AND IRRIGATION FLOWS
PLACE EROSION CONTROL PER THE SWMP



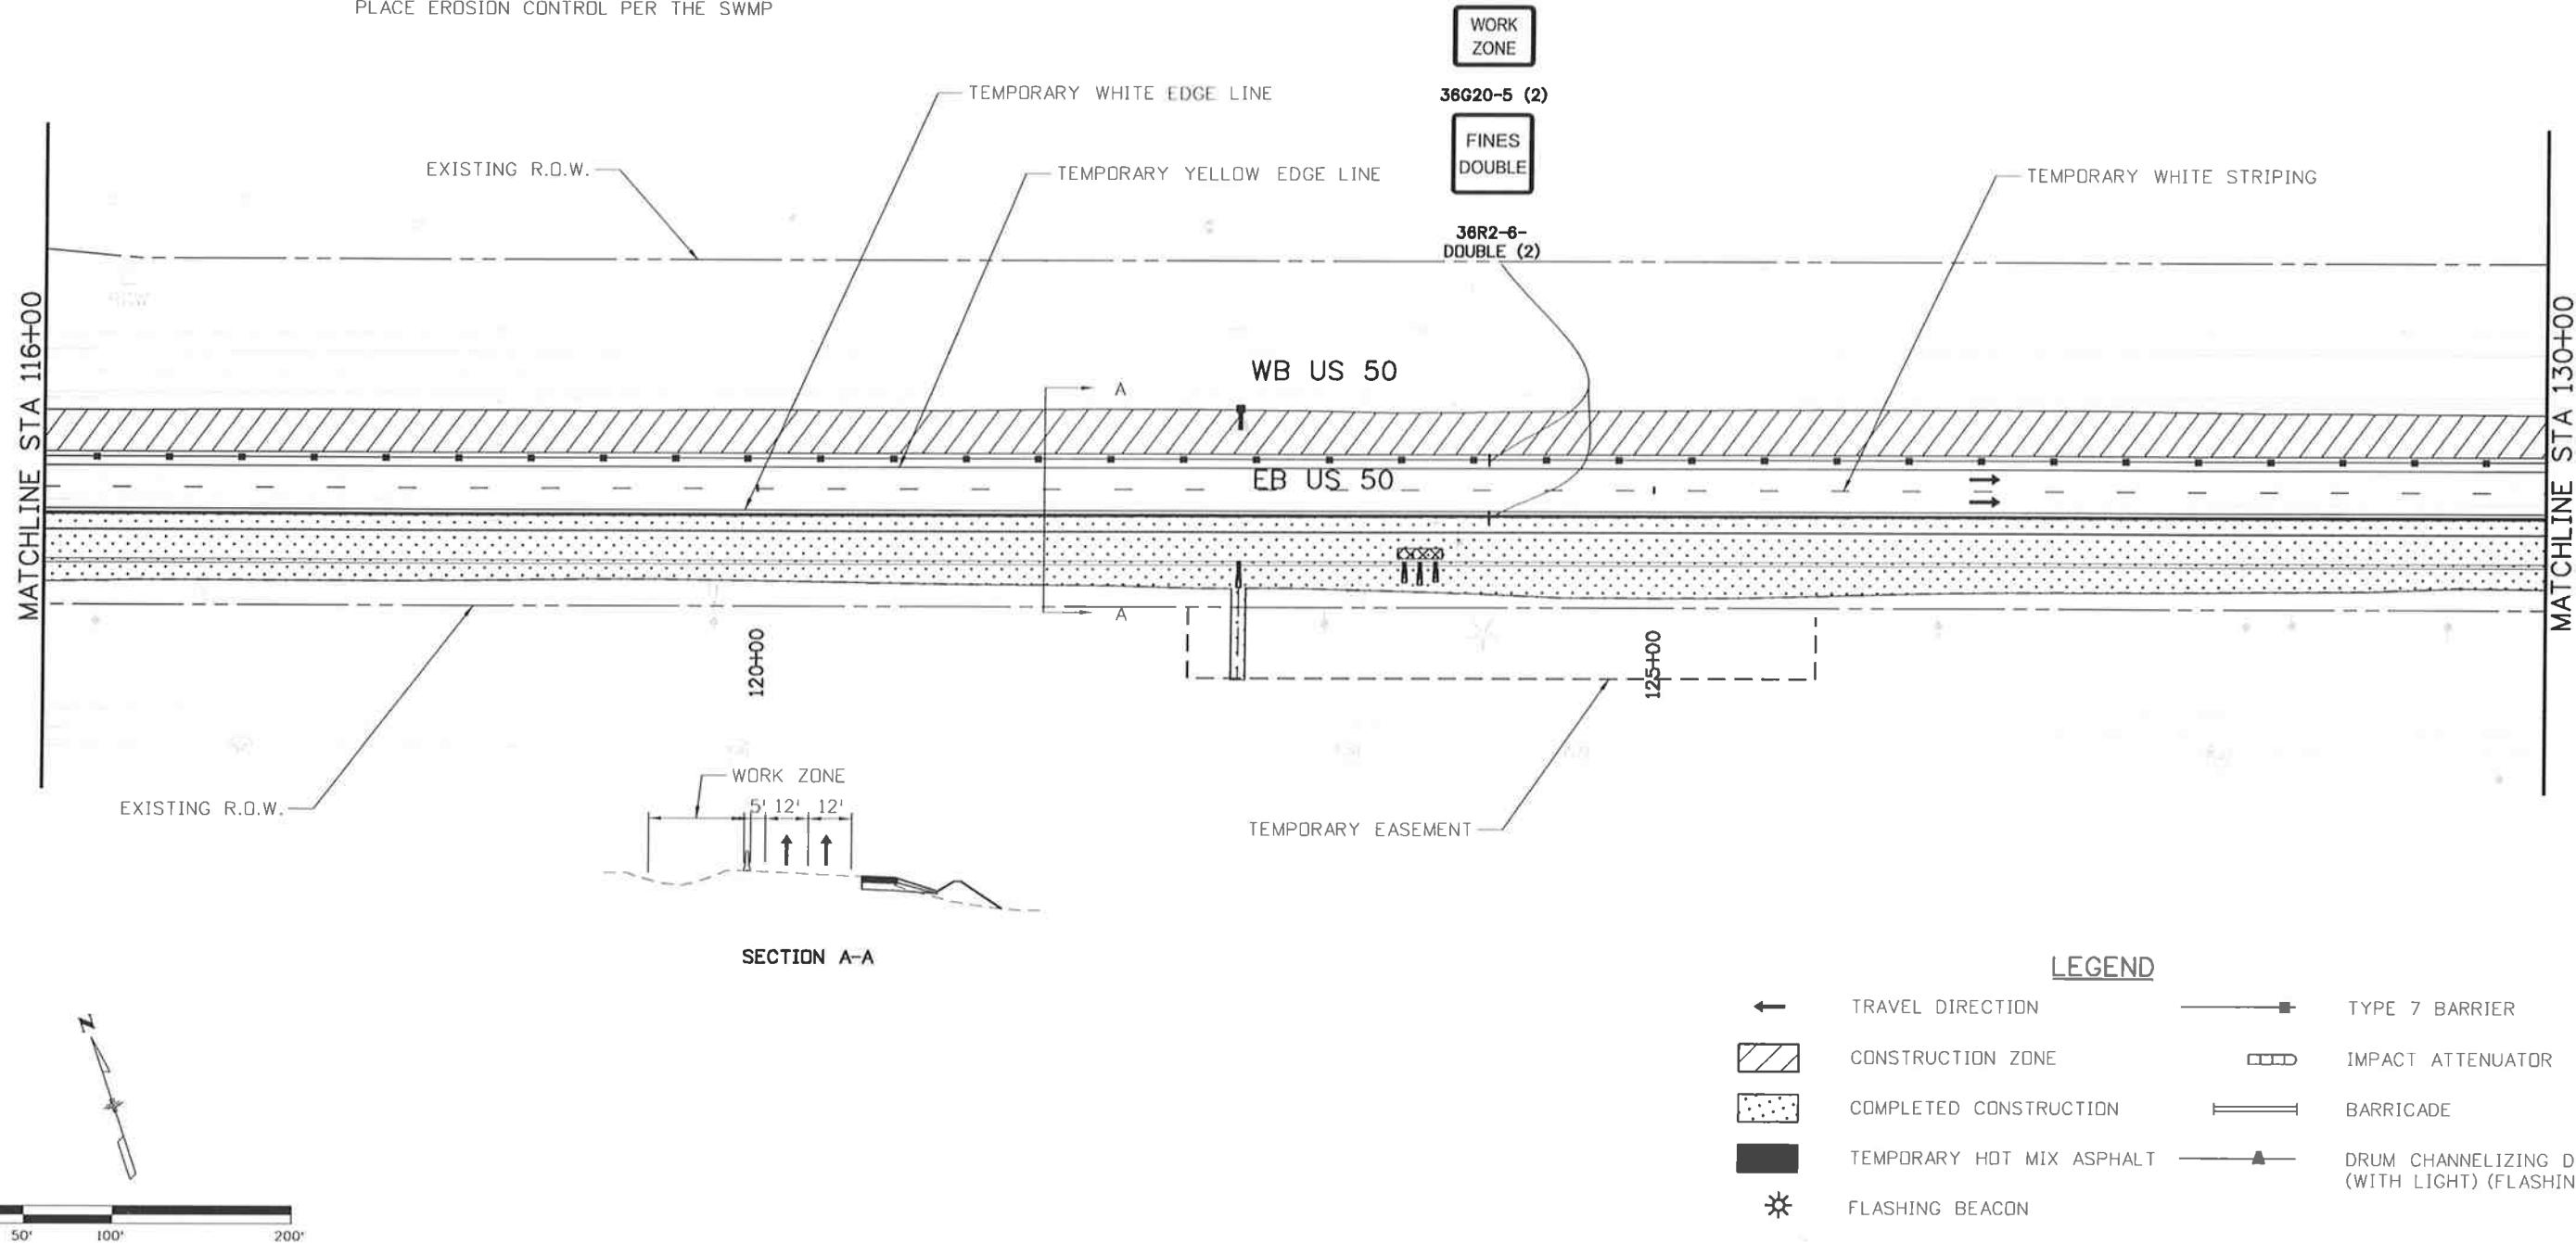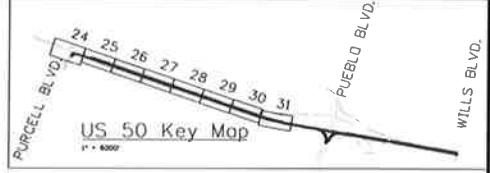

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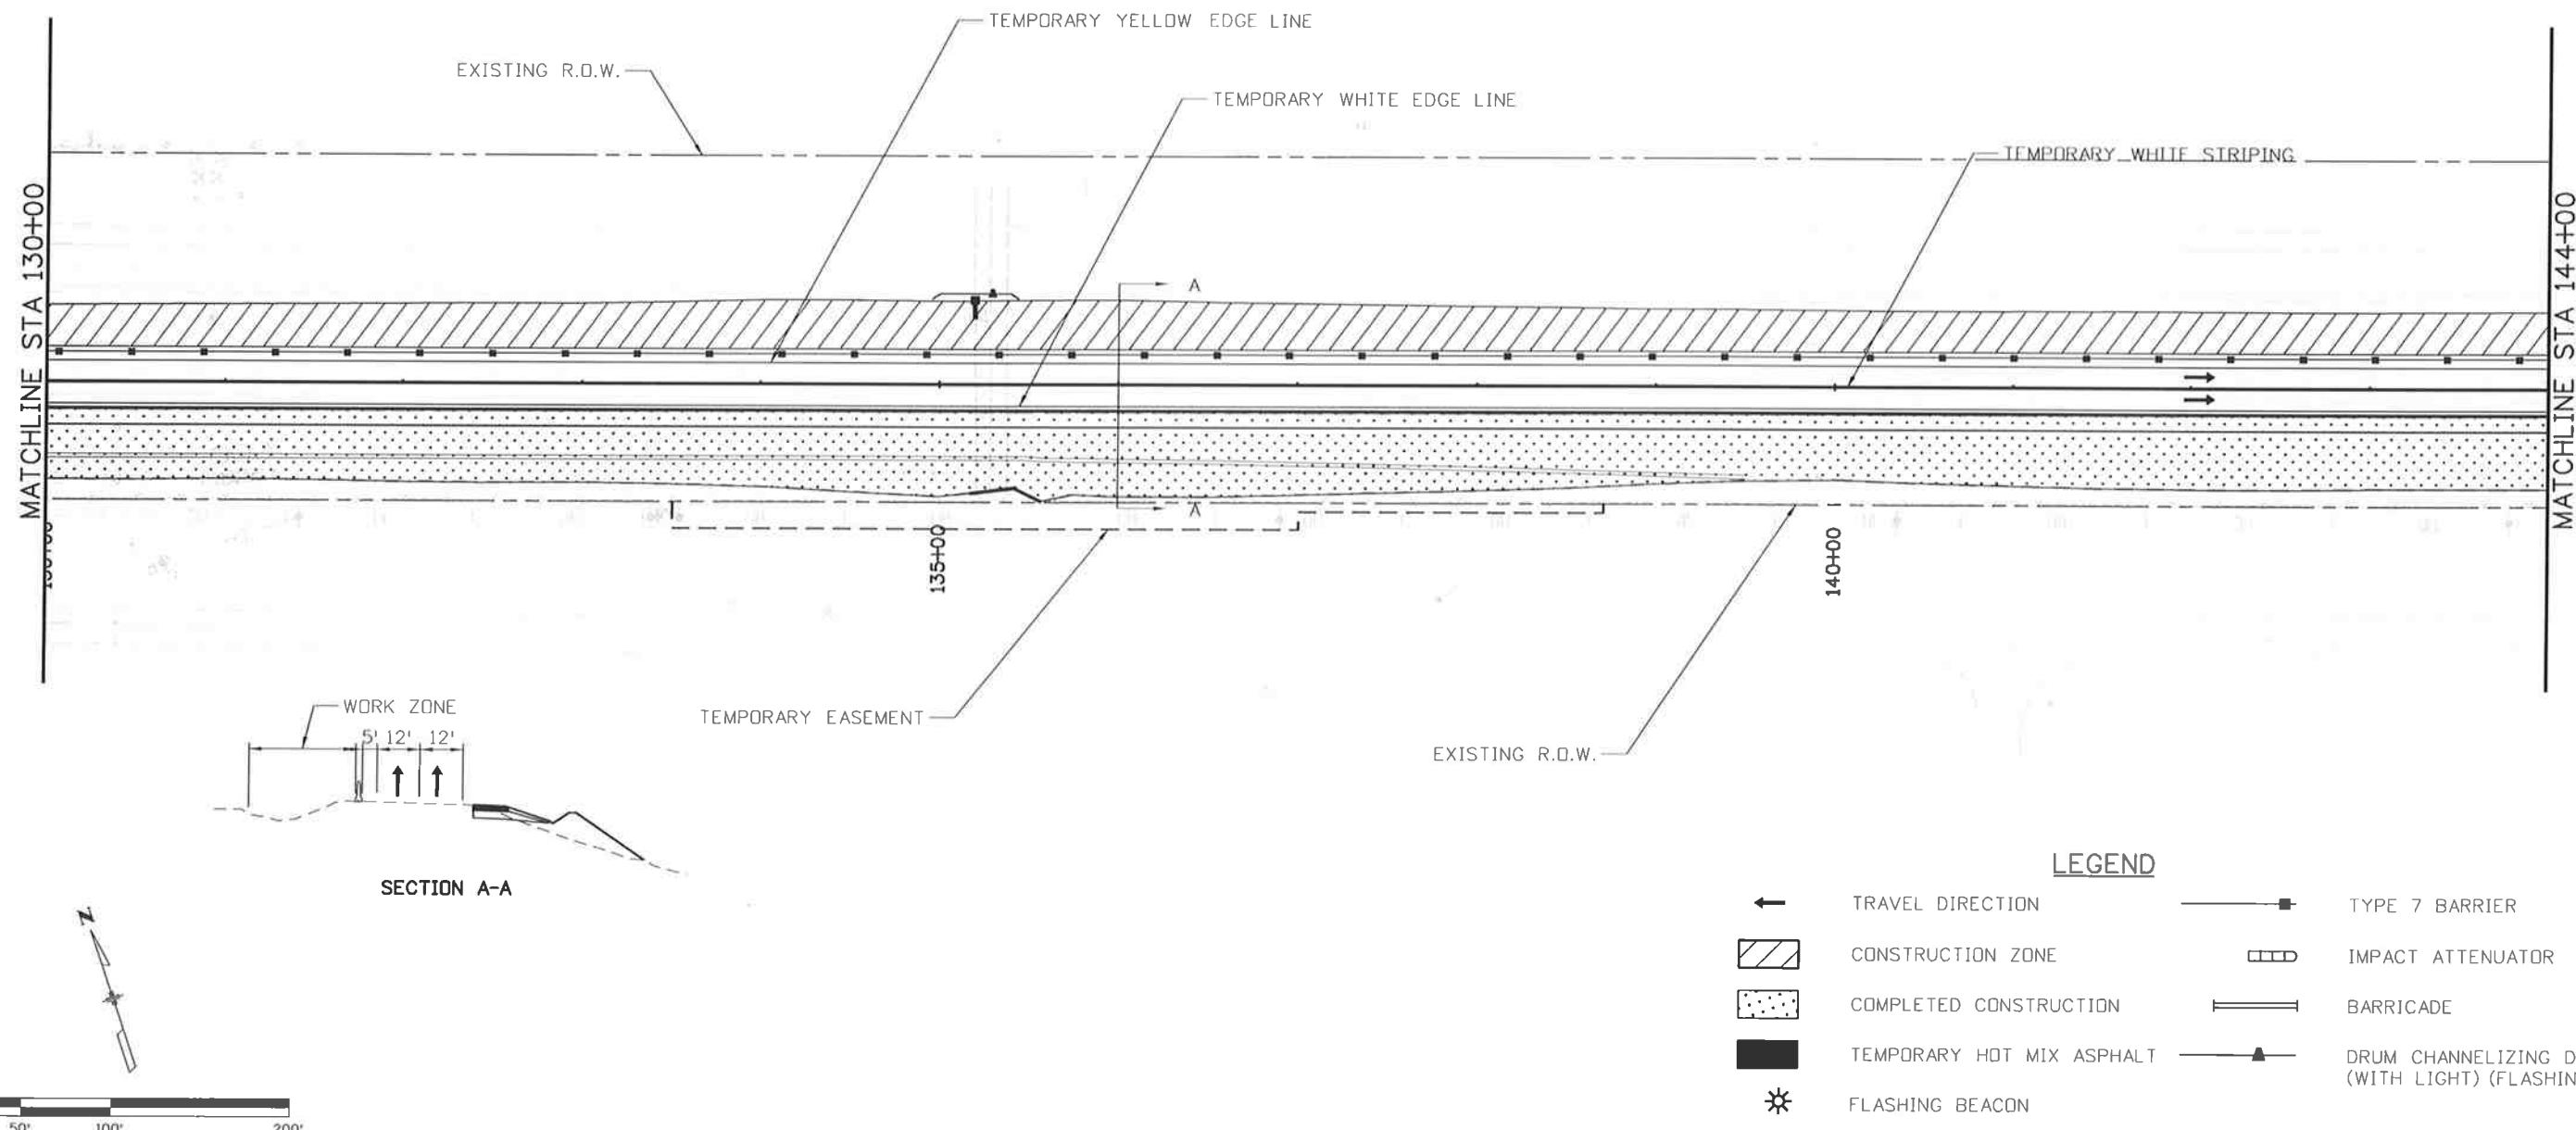
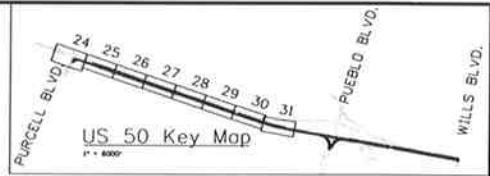
PHASE 3

TRAFFIC CONTROL:

TRAFFIC ON EXISTING AND NEW LANES
MAINTAIN 2 LANES ON US 50 EB

CONSTRUCTION:

WIDEN US 50 INTO MEDIAN AS SHOWN FROM STA 105+59 TO STA 196+15
EXTEND CROSS PIPE AND ADD NEW MEDIAN INLET AS SHOWN
MAINTAIN DRAINAGE AND IRRIGATION FLOWS
PLACE EROSION CONTROL PER THE SWMP



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US 50 WEST
PURCELL BLVD. TO WILLS BLVD.
CTC - PHASE 3

Project No./Code

FSA 0503-081

19751

Sheet Number 272





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PHASE 3

TRAFFIC CONTROL:
TRAFFIC ON EXISTING AND NEW LANES
MAINTAIN 2 LANES ON US 50 EB

CONSTRUCTION:

WIDEN US 50 INTO MEDIAN AS SHOWN FROM STA 105+59 TO STA 196+15
EXTEND CROSS PIPE AND ADD NEW MEDIAN INLET AS SHOWN
MAINTAIN DRAINAGE AND IRRIGATION FLOWS
PLACE EROSION CONTROL PER THE SWMP

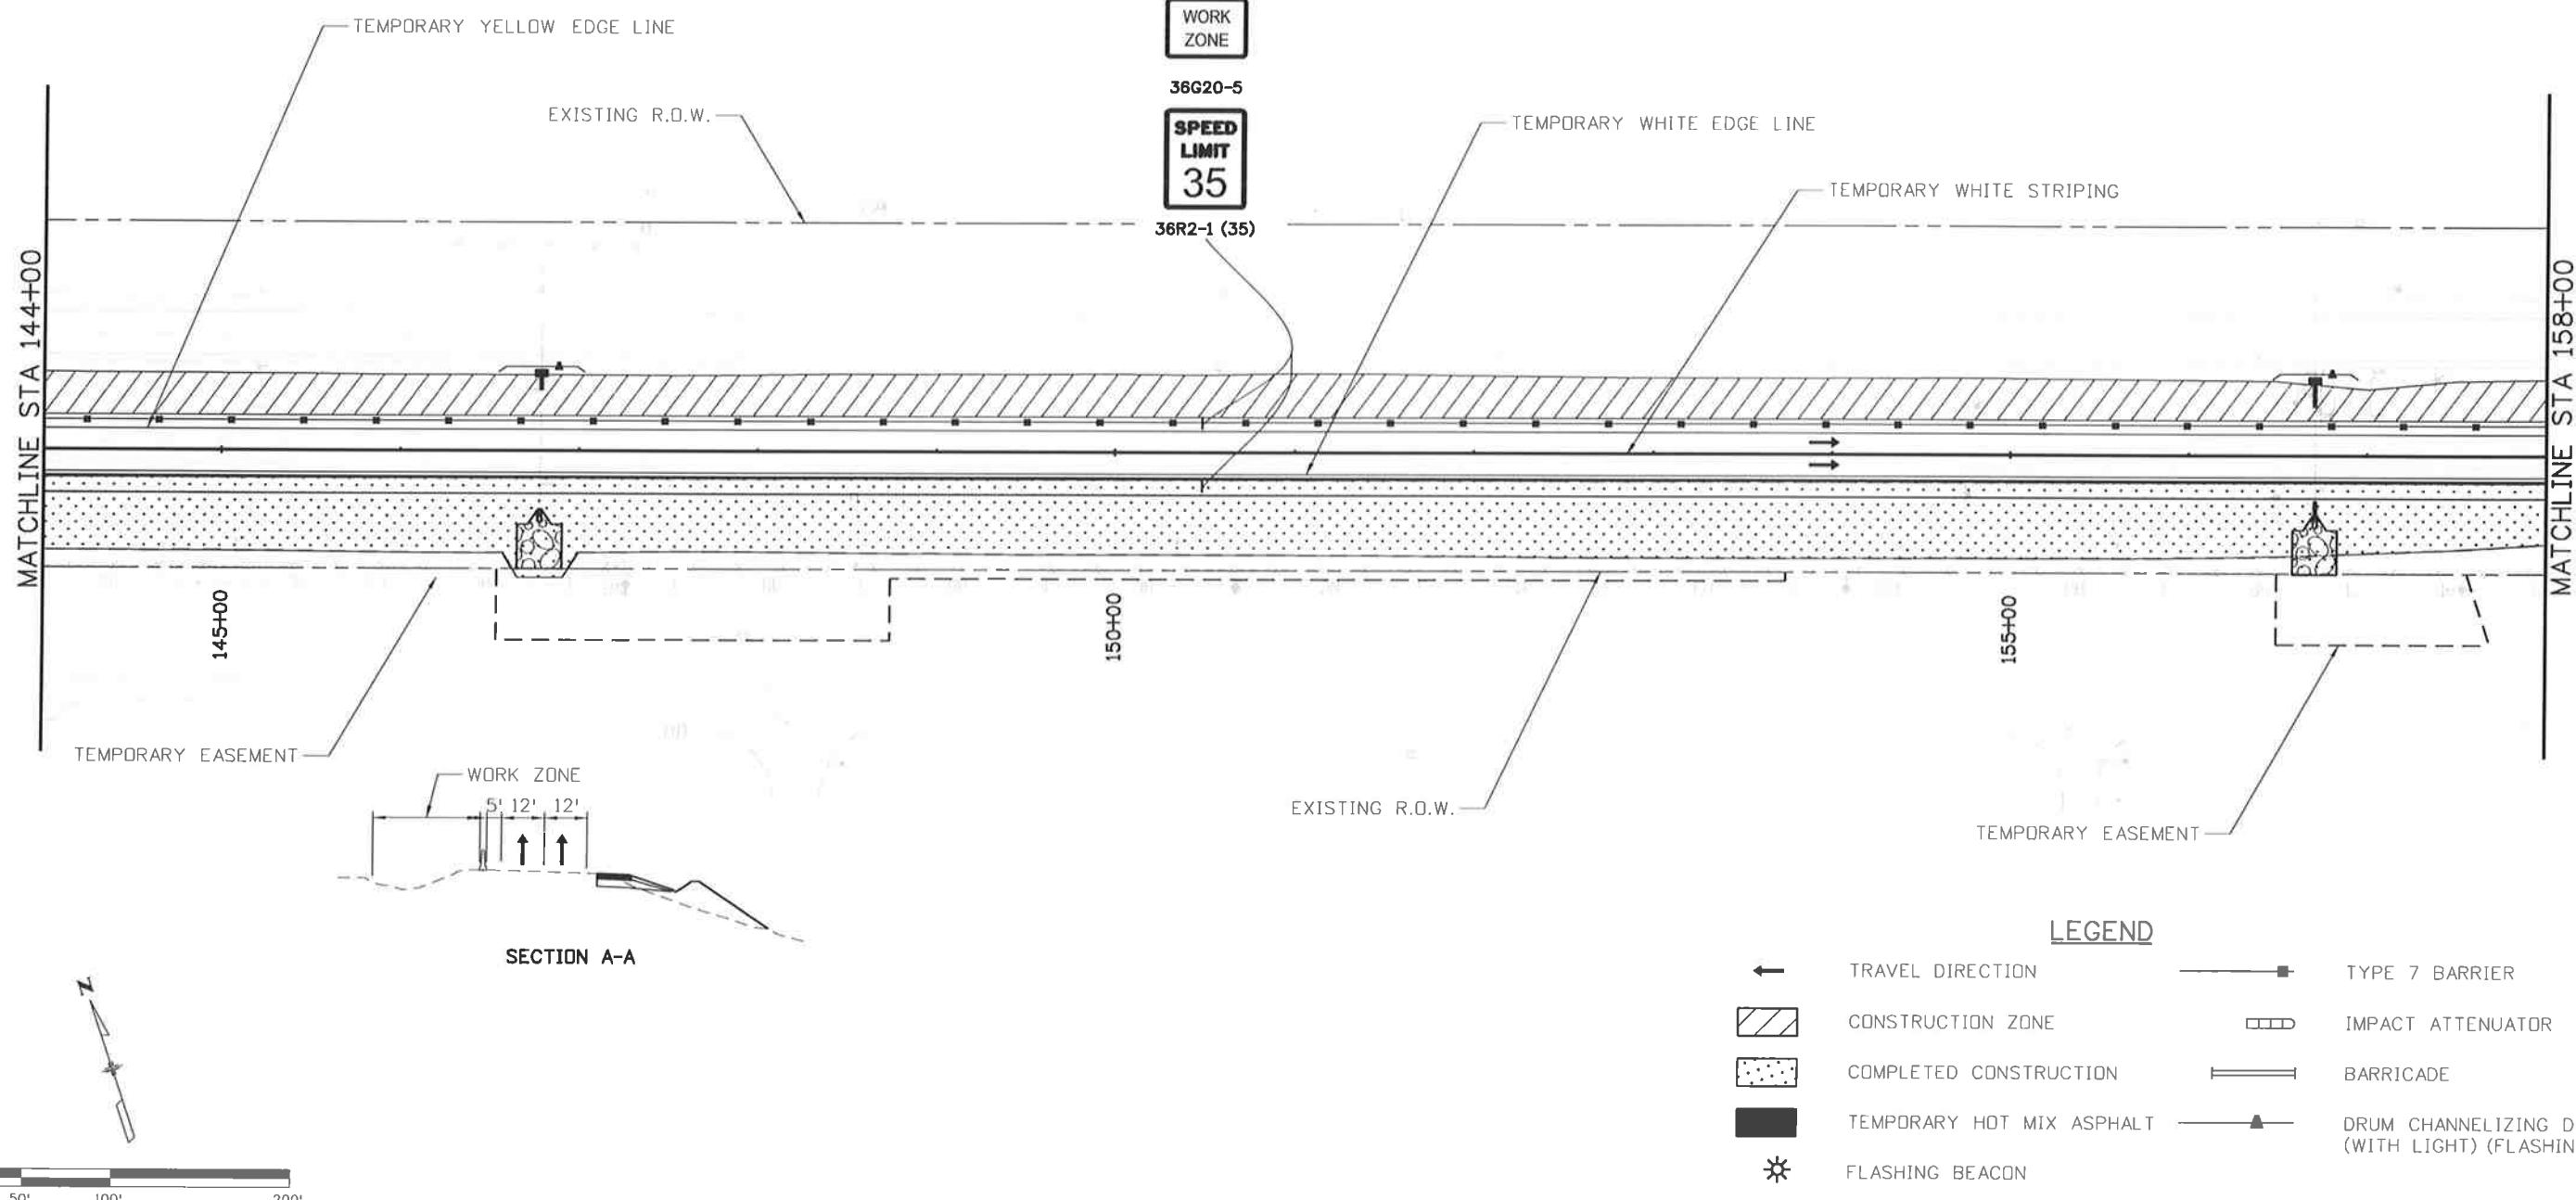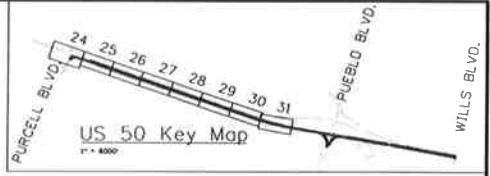

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US 50 WEST
PURCELL BLVD. TO WILLS BLVD.
CTC - PHASING 3

Project No./Code

FSA 0503-081

19751

Sheet Number 273

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Designer: AB Structure Numbers
Detailer: AB
Subset: CT Subset Sheets: CT28of 33




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PHASE 3


TRAFFIC CONTROL:
TRAFFIC ON EXISTING AND NEW LANES
MAINTAIN 2 LANES ON US 50 EB

CONSTRUCTION:

WIDEN US 50 INTO MEDIAN AS SHOWN FROM STA 105+59 TO STA 196+15
EXTEND CROSS PIPE AND ADD NEW MEDIAN INLET AS SHOWN
MAINTAIN DRAINAGE AND IRRIGATION FLOWS
PLACE EROSION CONTROL PER THE SWMP

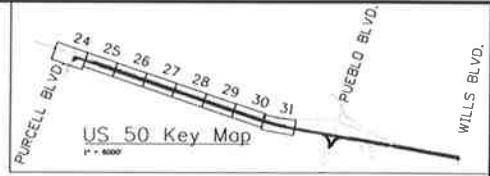

EXISTING R.D.W.

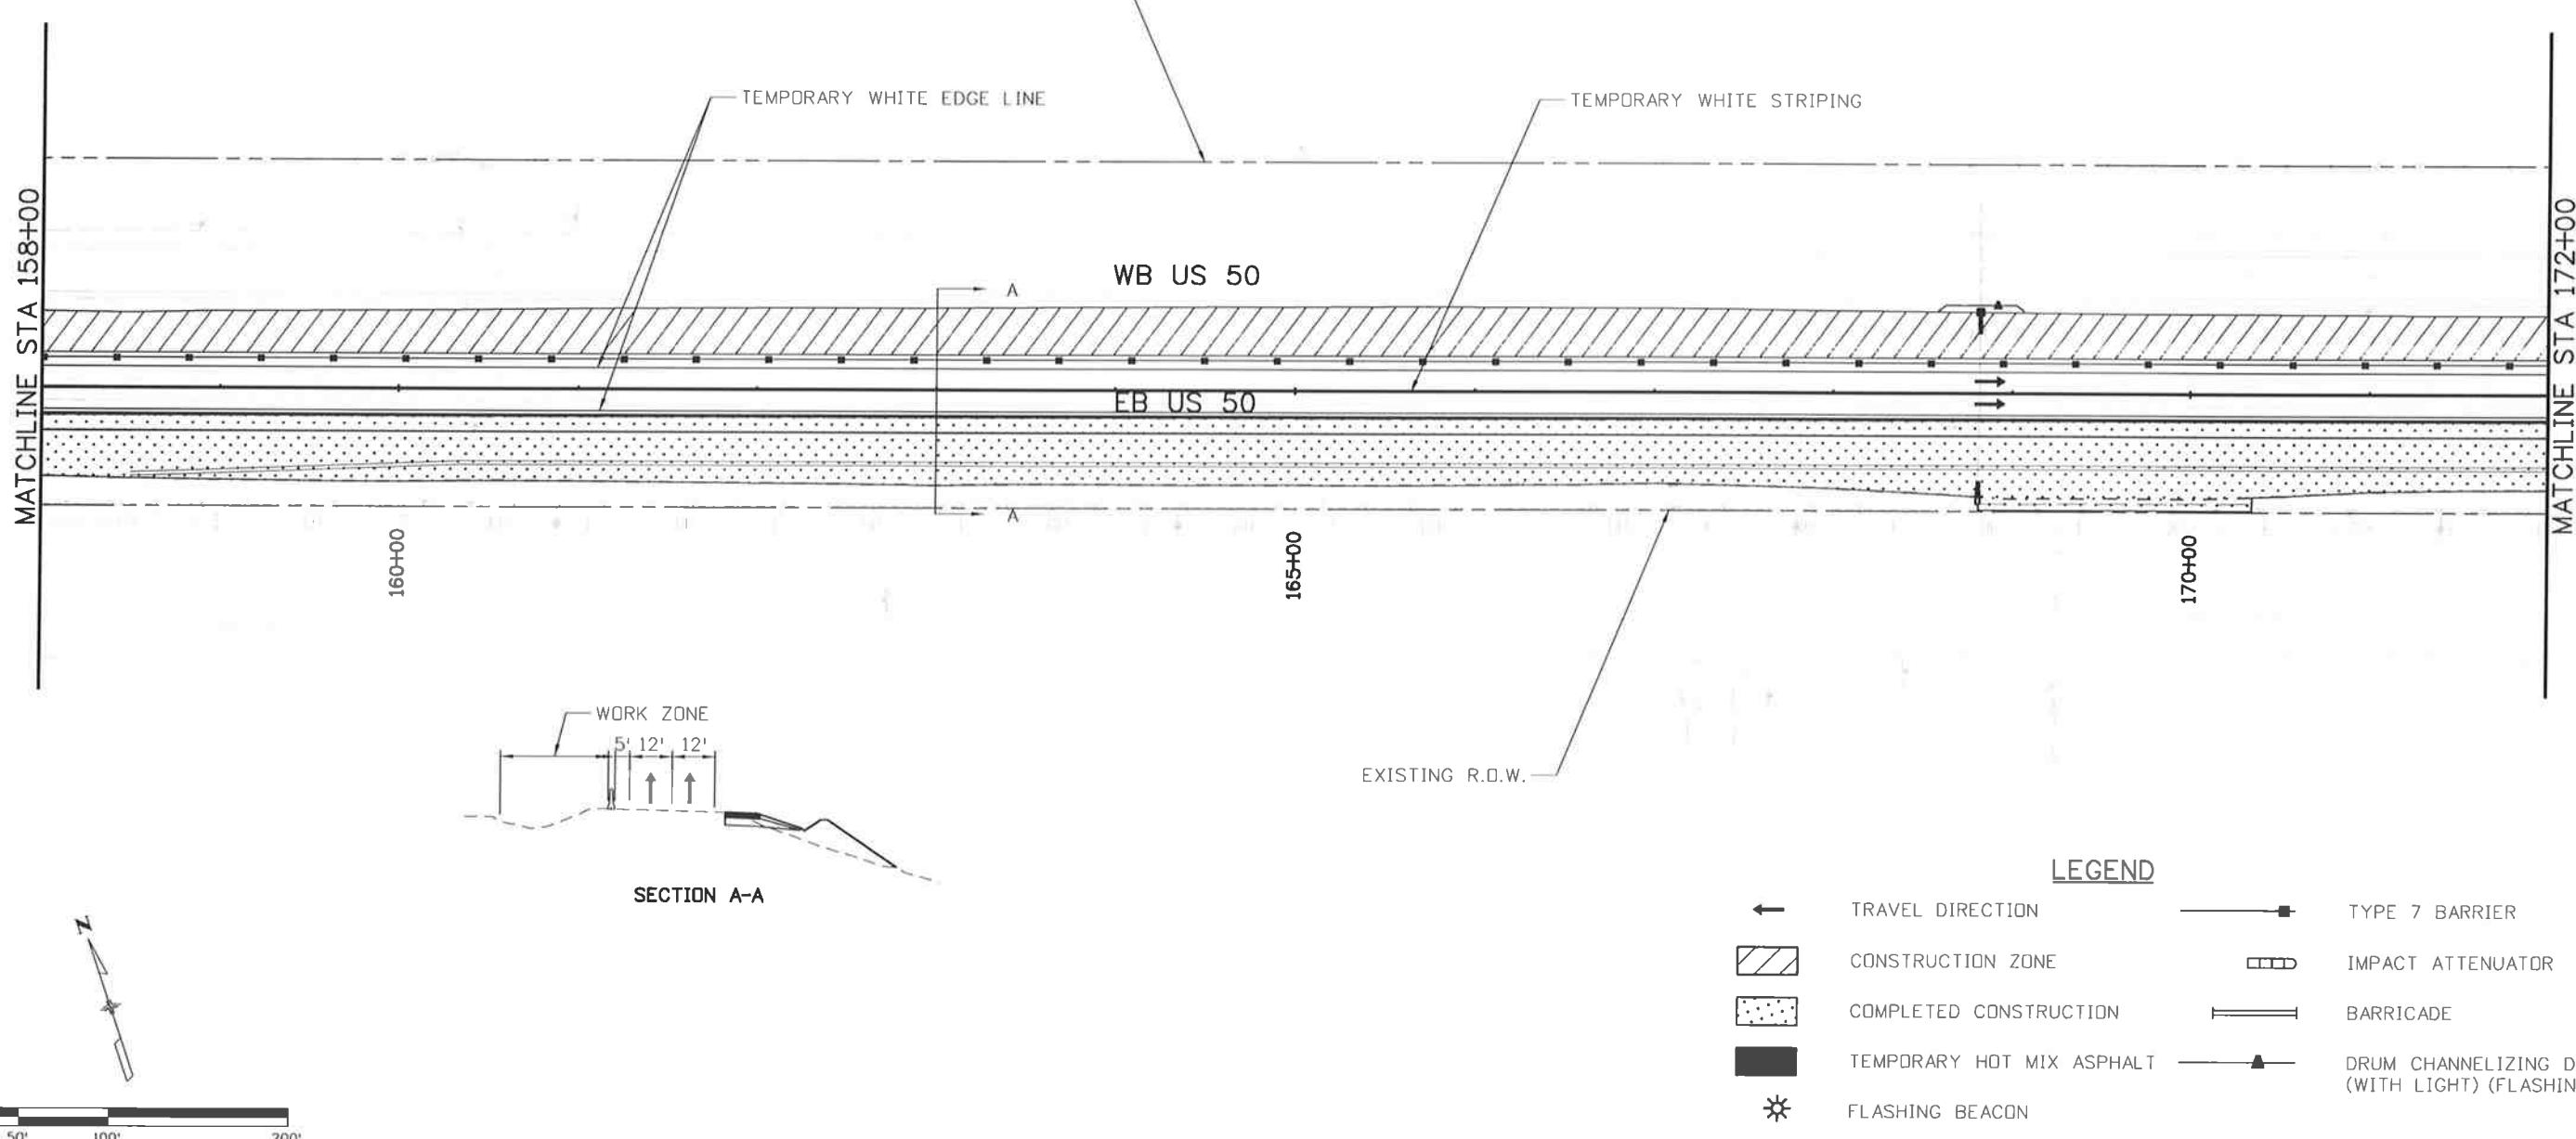

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US 50 WEST
PURCELL BLVD. TO WILLS BLVD.
CTC - PHASE 3

AB Structure
Detailer: AB Numbers
Subset: CT Subset Sheets: CT29of 33

Project No./Code

FSA 0503-081

19751

Sheet Number 274





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PHASE 3

TRAFFIC CONTROL:
TRAFFIC ON EXISTING AND NEW LANES
MAINTAIN 2 LANES ON US 50 EB

CONSTRUCTION:

WIDEN US 50 INTO MEDIAN AS SHOWN FROM STA 105+59 TO STA 196+15
EXTEND CROSS PIPE AND ADD NEW MEDIAN INLET AS SHOWN
MAINTAIN DRAINAGE AND IRRIGATION FLOWS
PLACE EROSION CONTROL PER THE SWMP

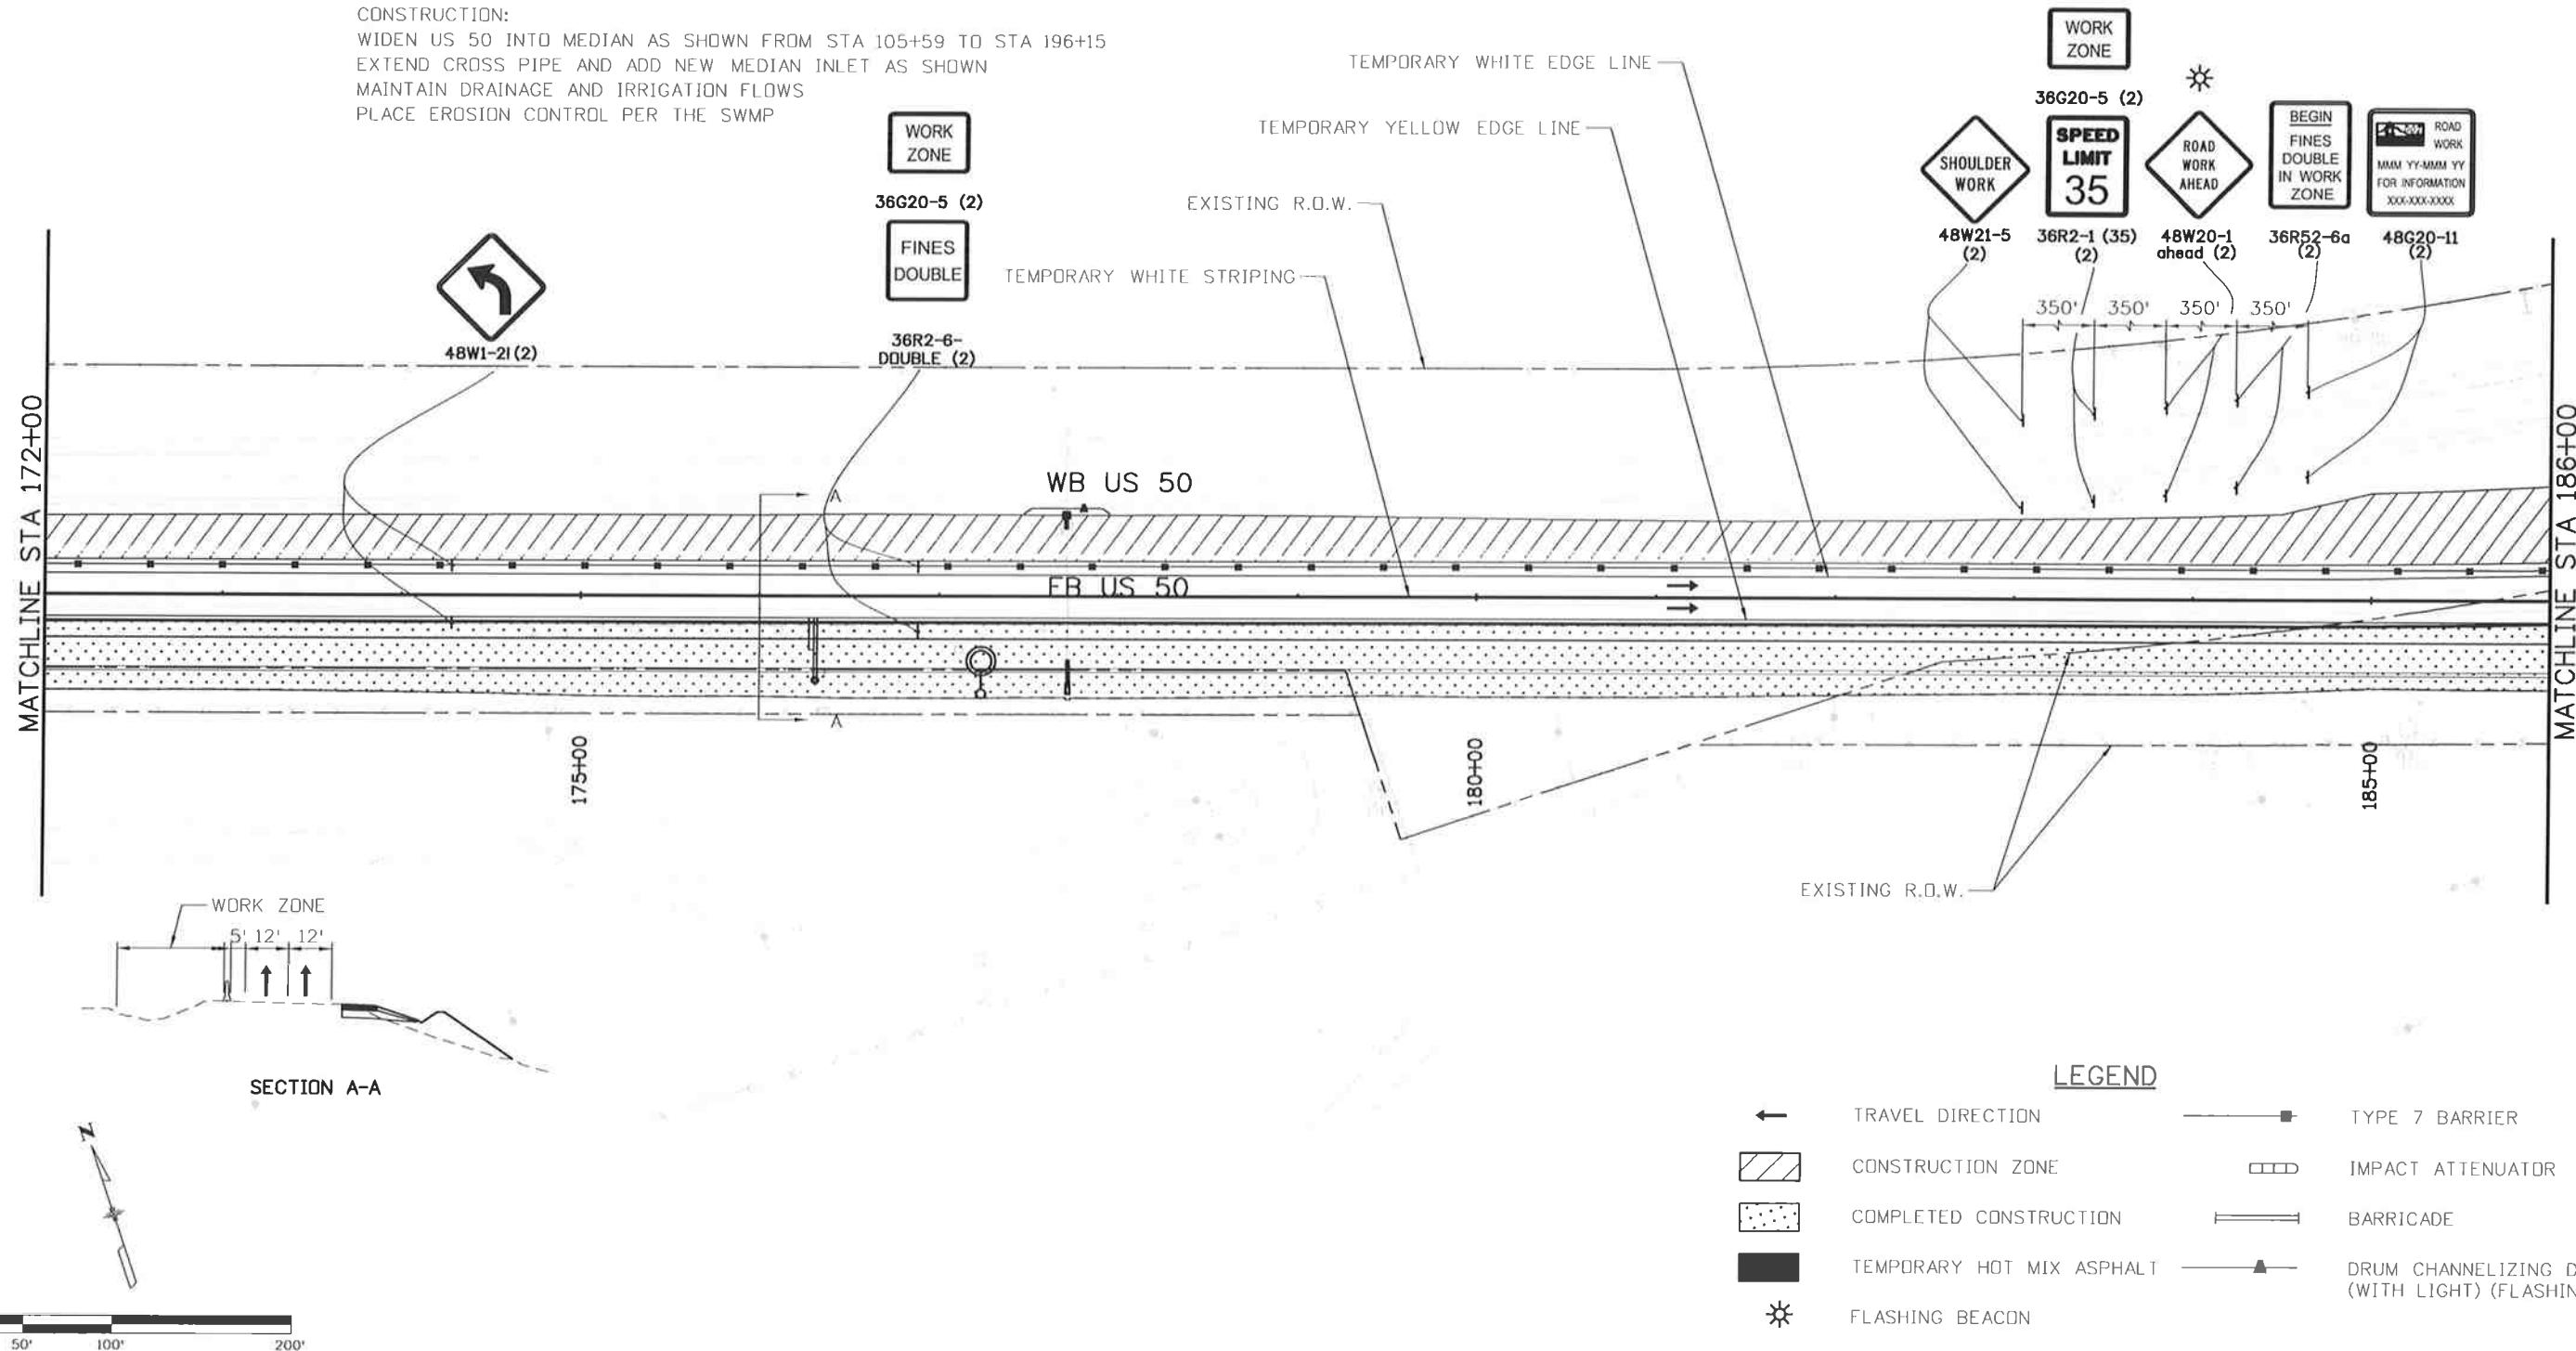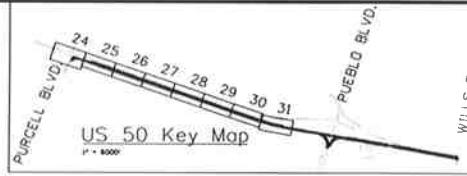

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File Name: I9056DES_Construction Phasing3_7.dgn

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US 50 WEST
PURCELL BLVD. TO WILLS BLVD.
CTC - PHASE 3

Designer:	AB	Structure Numbers
Detailer:	AB	
Subset:	CT	Subset Sheets: CT 30 of 33

Project No./Code

FSA 0503-081

19751

Sheet Number 275





Know what's below.
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PHASE 3

TRAFFIC CONTROL:
TRAFFIC ON EXISTING AND NEW LANES
MAINTAIN 2 LANES ON US 50 EB

CONSTRUCTION:

WIDEN US 50 INTO MEDIAN AS SHOWN FROM
STA 105+59 TO STA 196+15
EXTEND CROSS PIPE AND ADD NEW MEDIAN INLET AS SHOWN
MAINTAIN DRAINAGE AND IRRIGATION FLOWS
PLACE EROSION CONTROL PER THE SWMP

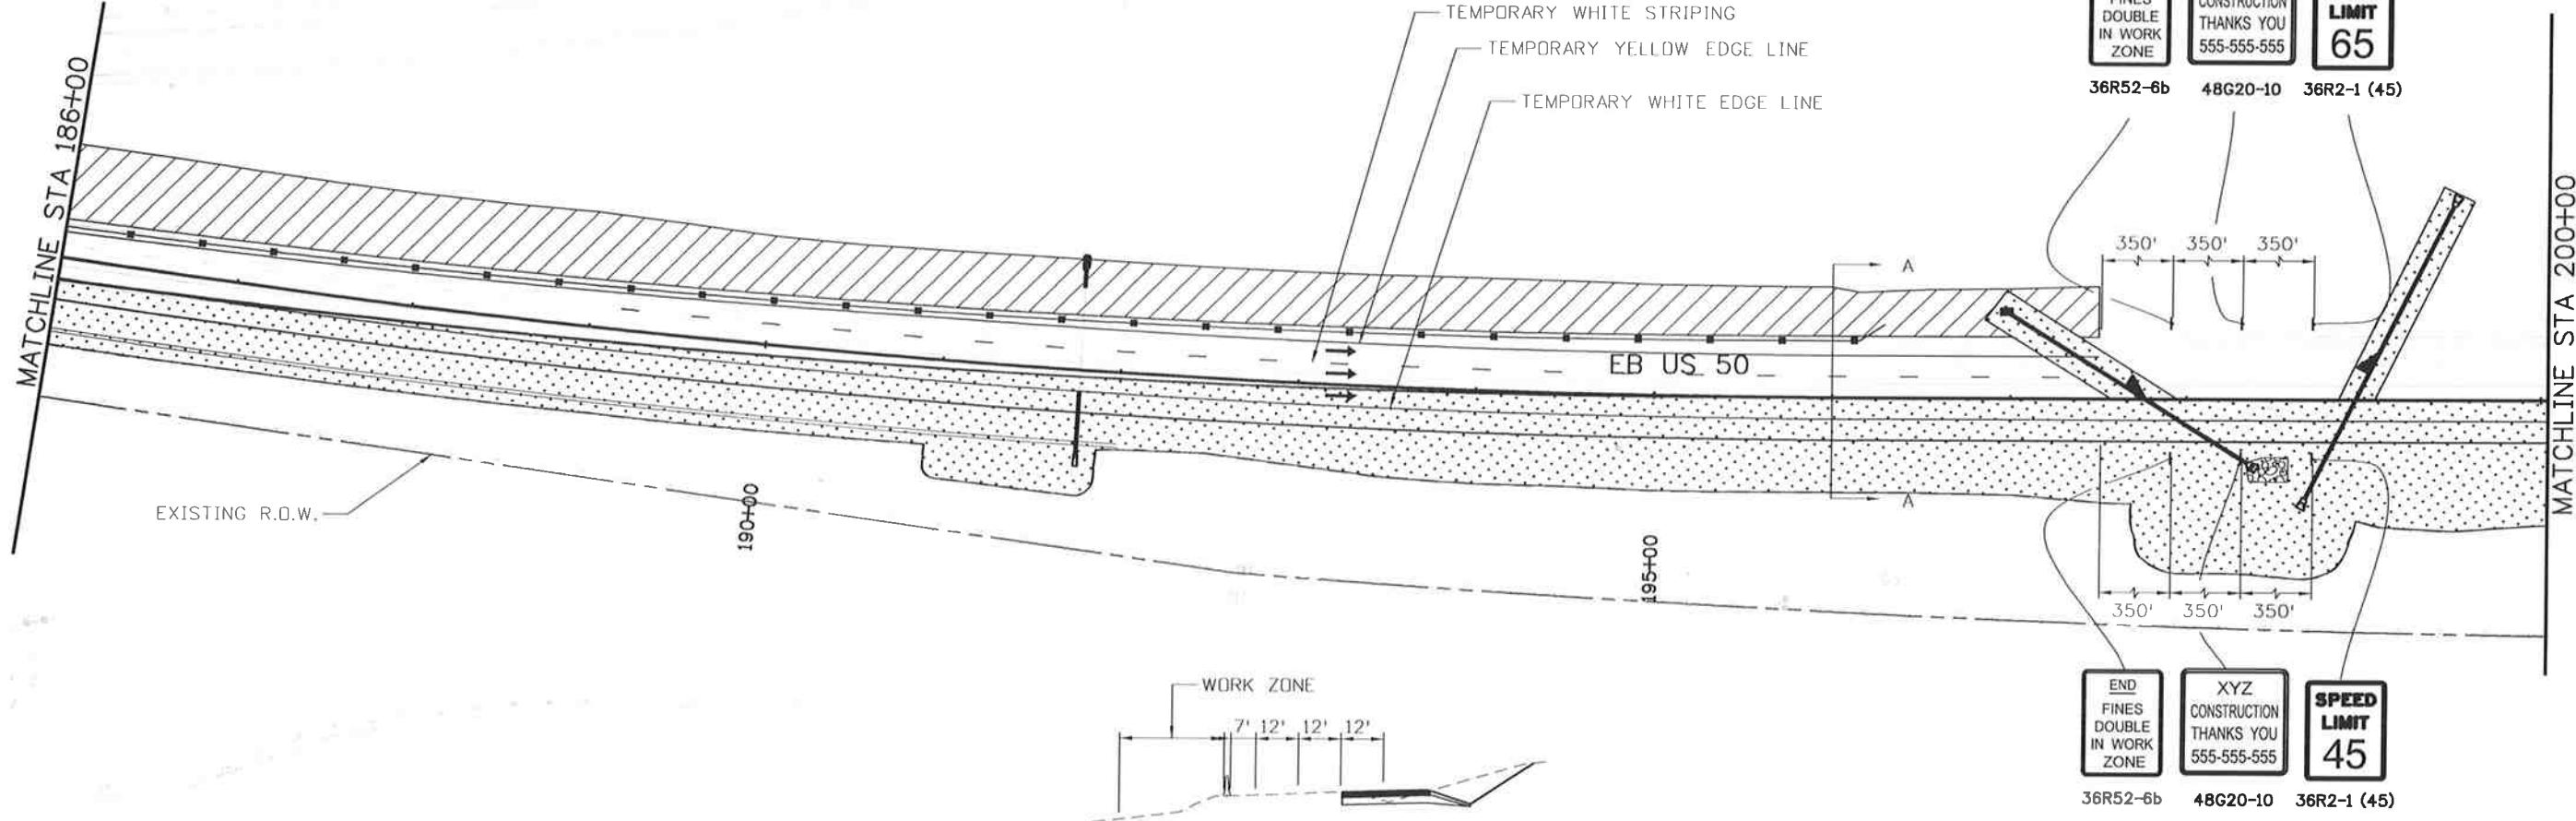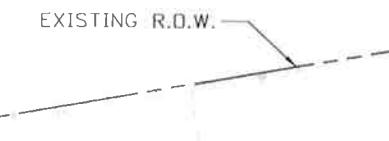

Print Date: 10/9/2014

File Name: 19056DES_Construction Phasing3_8.dgn

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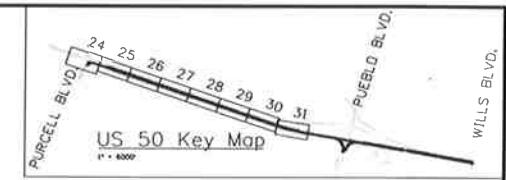
US 50 WEST
PURCELL BLVD. TO WILLS BLVD.
CTC - PHASE 3

Project No./Code

FSA 0503-081

19751

Sheet Number 276







**Know what's below.
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EB US 50



PLACE SIGNS
350 FT WEST
REF. INSET L

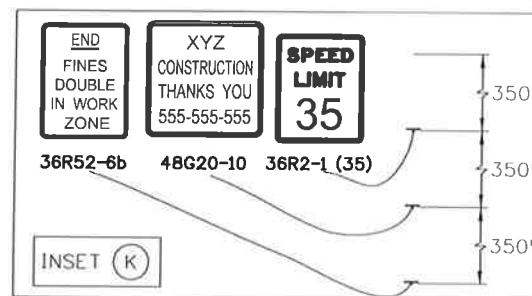

Print Date: 10/9/2014

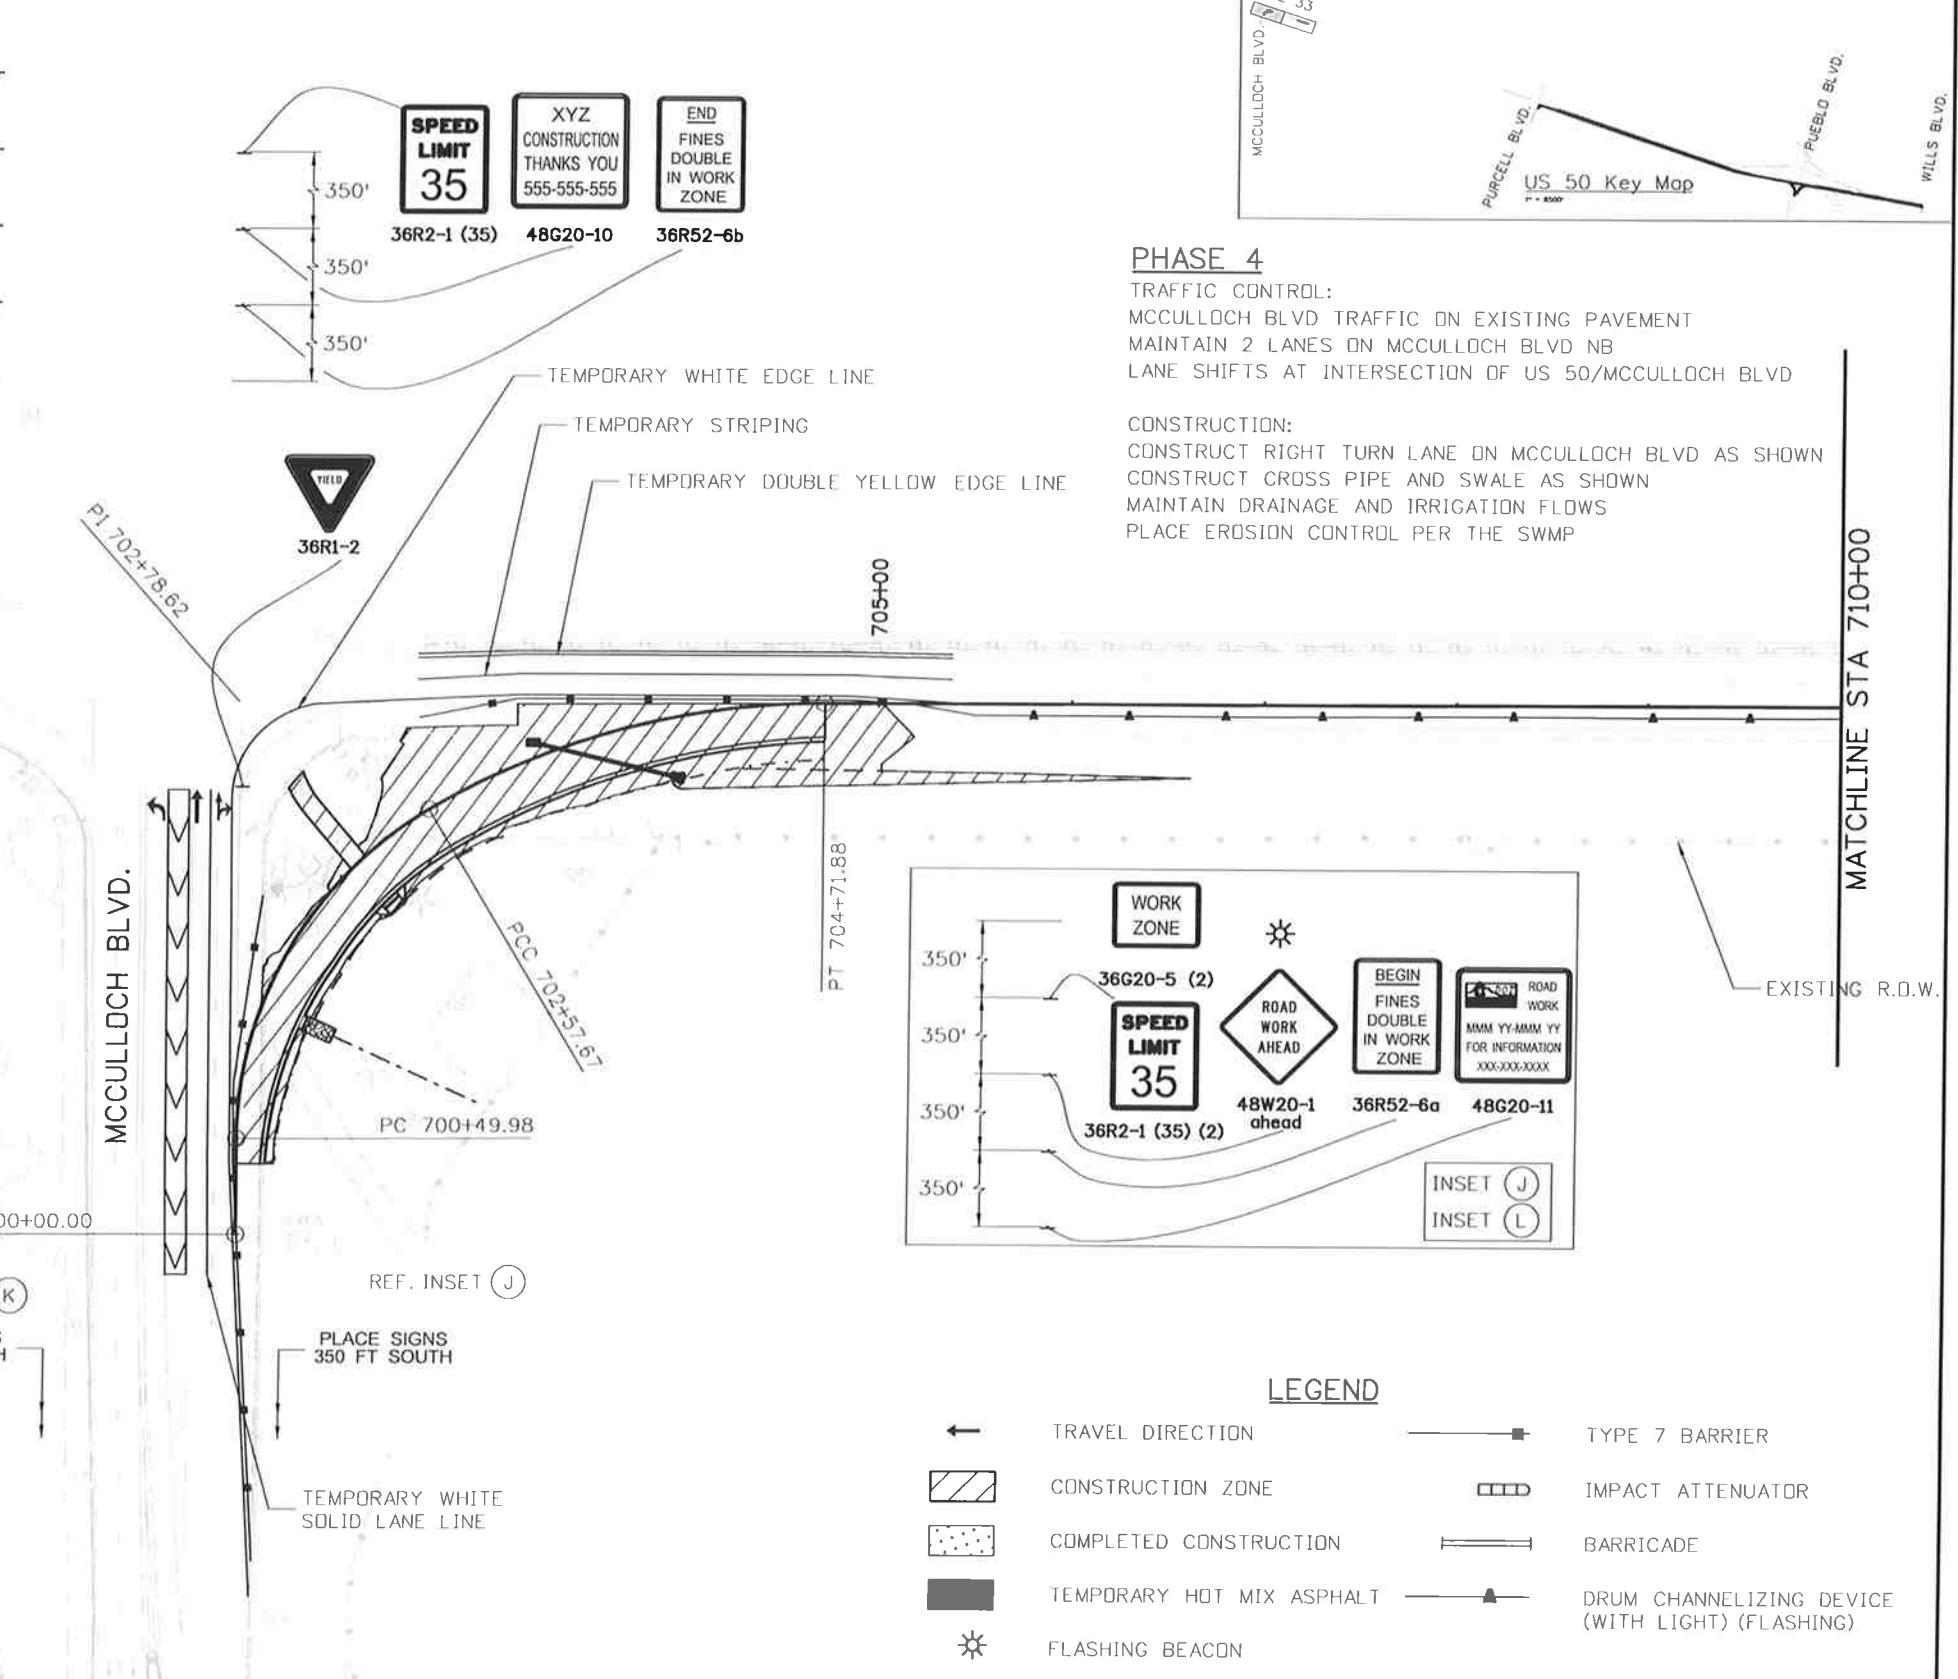File Name: 19056DES_Construction Phasing4_1.dgn

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Vert. Scale: As Noted



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US 50 WEST
MCCULLOCH BLVD.
CTC - PHASE 4

Project No./Code

FSA 0503-081

19751

Sheet Number 277

Designer:	AB	Structure Numbers
Detailer:	AB	
Subset:	CT	Subset Sheets: CT32 of 33




**Know what's below.
Call before you dig.**

PHASE 4

TRAFFIC CONTROL:
US 50 TRAFFIC ON EXISTING PAVEMENT
MAINTAIN 2 LANES ON US 50 EB
CLOSE EXISTING ACCELERATION LANE

CONSTRUCTION:

CONSTRUCT SHOULDER AS SHOWN
MAINTAIN DRAINAGE AND IRRIGATION FLOWS
PLACE EROSION CONTROL PER THE SWMP

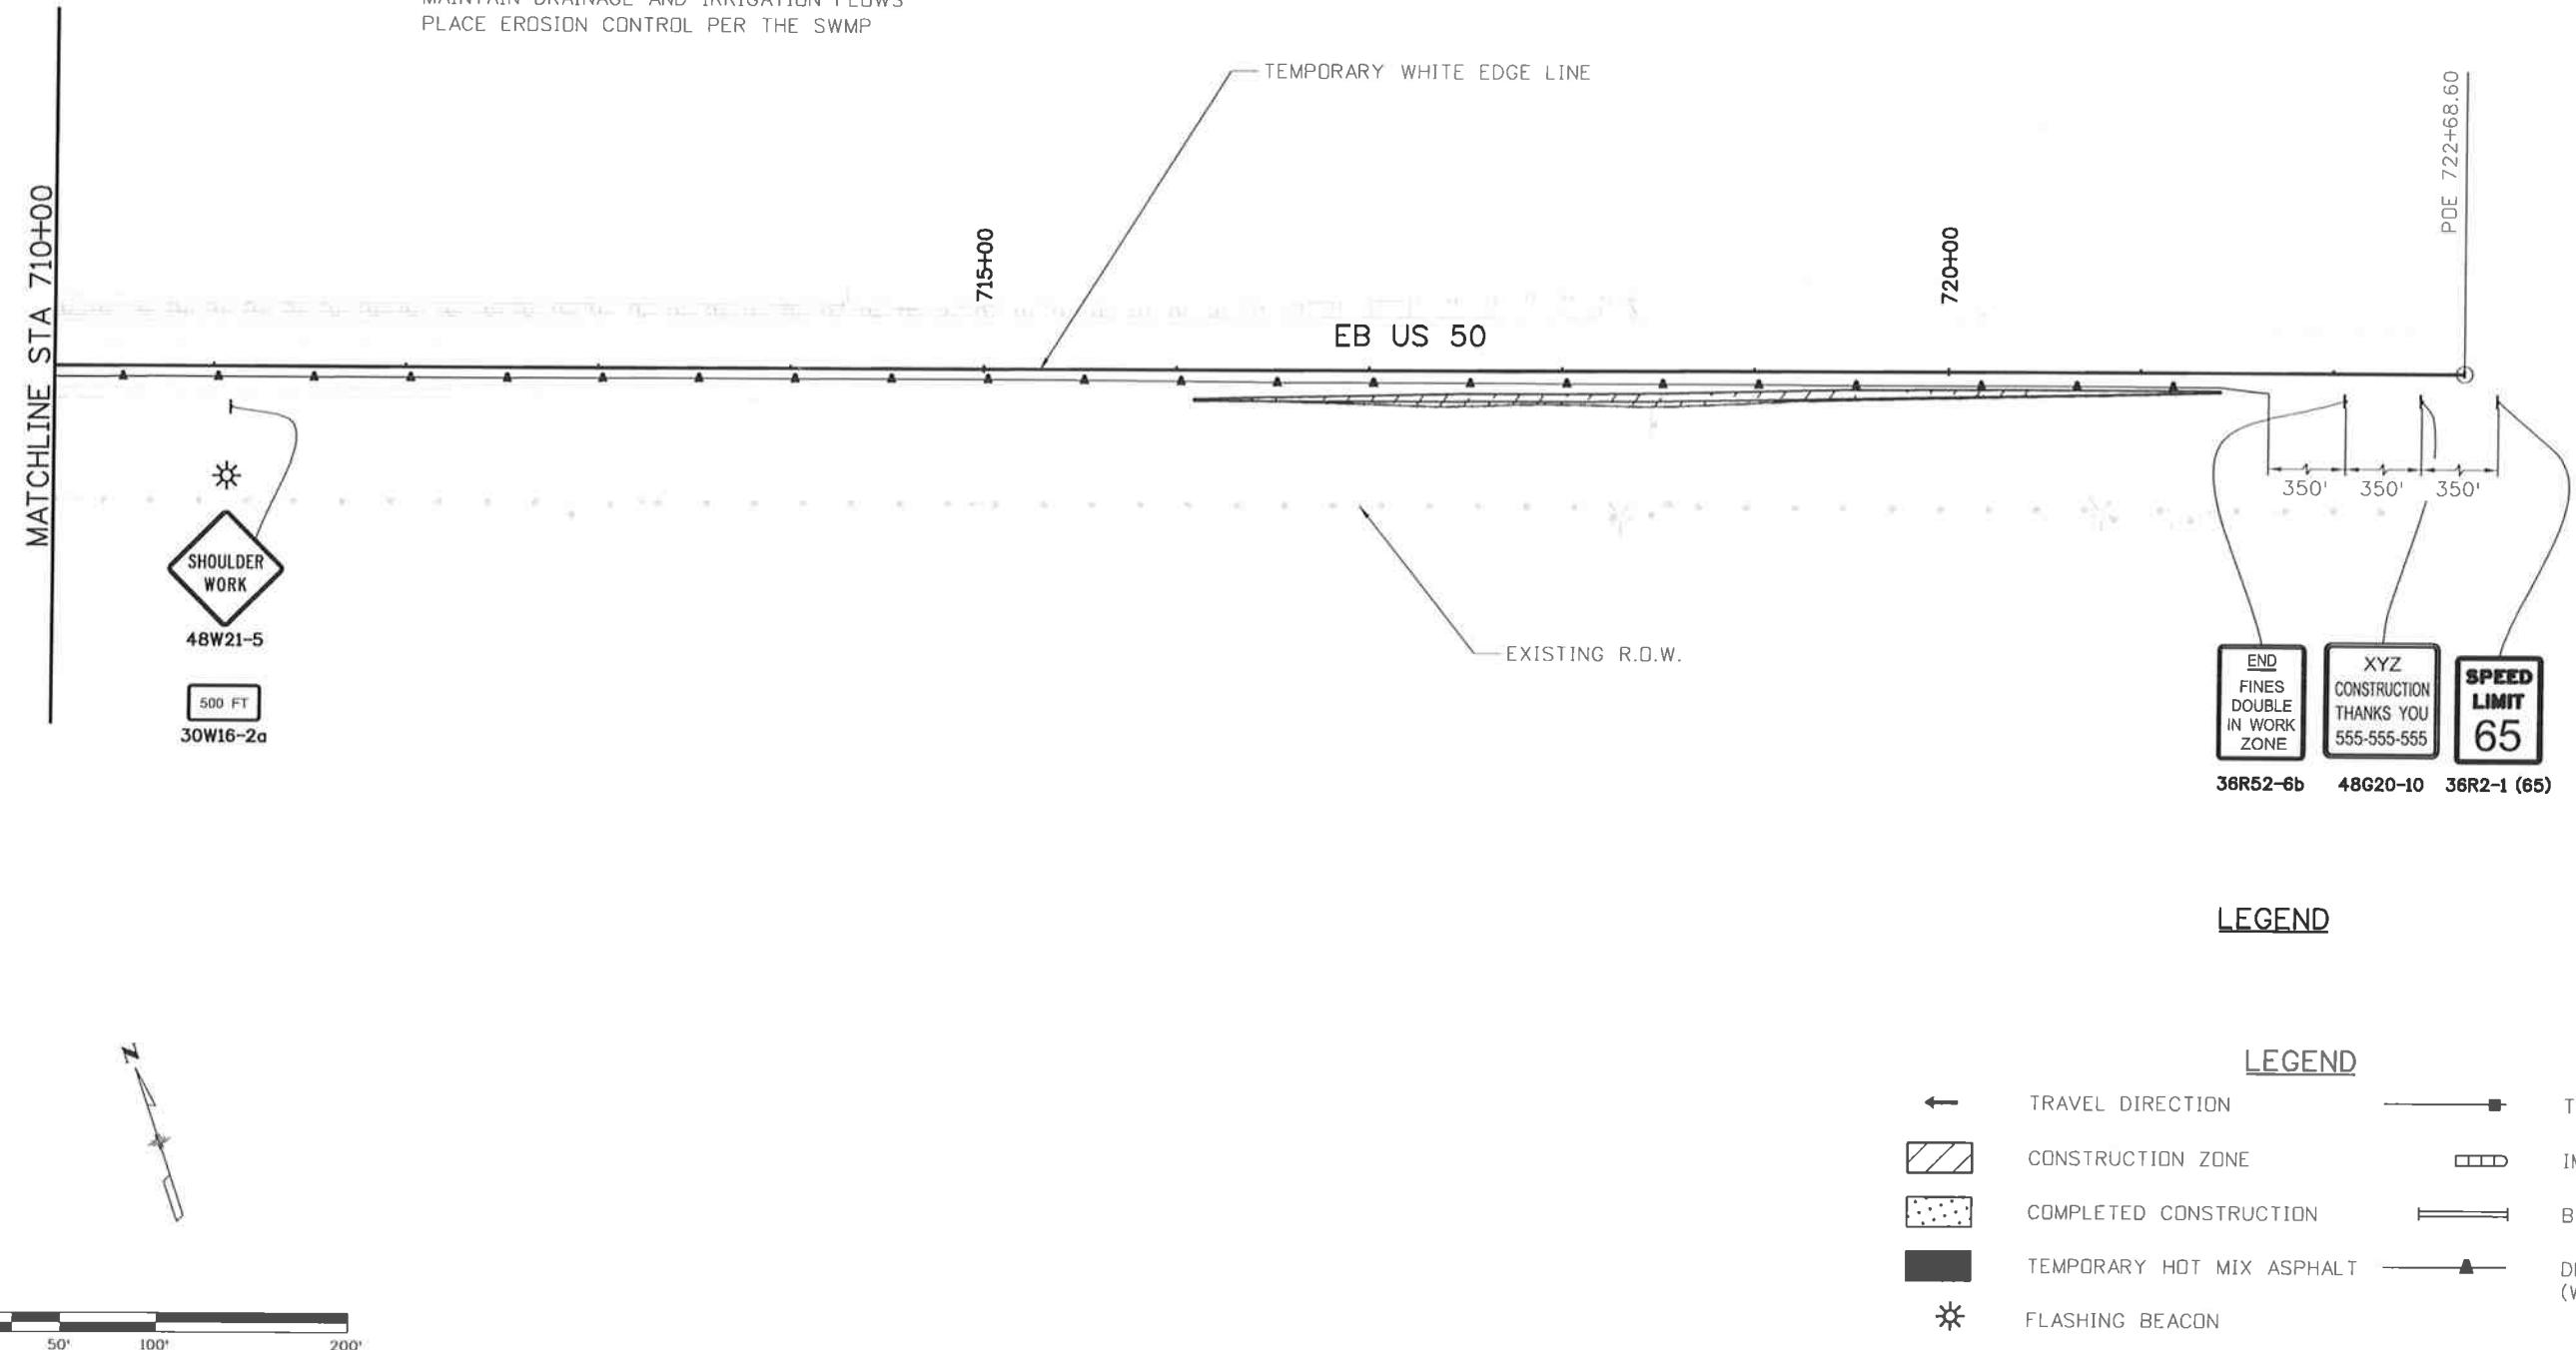

LEGEND

	TRAVEL DIRECTION		TYPE 7 BARRIER
	CONSTRUCTION ZONE		IMPACT ATTENUATOR
	COMPLETED CONSTRUCTION		BARRICADE
	TEMPORARY HOT MIX ASPHALT		DRUM CHANNELIZING DEVICE (WITH LIGHT) (FLASHING)
	FLASHING BEACON		

Print Date: 10/9/2014

File Name: 19056DES_Construction Phasing4_2.dgn

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Sheet Revisions

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Region 2 902 Erie Avenue
Pueblo, CO 81001
Phone: 719-562-5509 FAX: 719-546-5702

As Constructed

No Revisions:

Revised:

Void:


US 50 WEST
MCCULLOCH BLVD.
CTC - PHASE 4

Project No./Code

FSA 0503-081

19751

Sheet Number 278

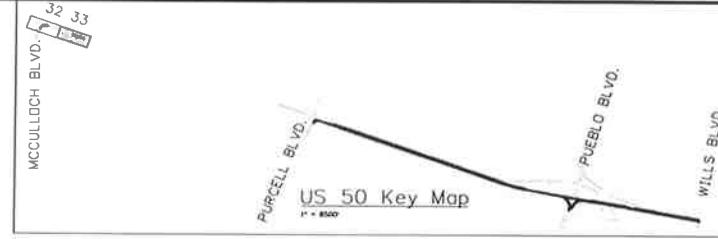

TRAFFIC SIGNAL GENERAL NOTES AND TABULATION OF SIGNAL QUANTITIES

1. Traffic Signal Materials and Installation shall comply with the "State of Colorado - Standard Specifications for Road and Bridge Construction", The "State of Colorado - Standard Plans, M and S Standards (Latest Edition), the "Manual of Uniform Traffic Control Devices", the "National Electric Code", and all local ordinances and regulations that apply, except as noted on the plans or special provisions.
2. The Contractor shall adhere to the following requirements regarding Traffic Signal construction and maintenance personnel. Current Certificates showing qualifications shall be submitted at the pre-construction meeting.
 - a. For any work inside the traffic signal cabinet, Signal and Signal Bench Technicians shall be minimum IMSA Level II certified. This includes the completion of training in construction, corrective maintenance and signal turn-on.
 - b. For all work external to the signal cabinet, a- minimum IMSA Level I Traffic Signal Field Technician/Electrician - or Traffic Signal Bench Technician/Signal Technician - is required. An IMSA Level II Traffic Signal Electrician - shall be on the job site at all times that signalization work is taking place to ensure proper construction. A maximum ratio of four IMSA Level-I to one IMSA Level-II will be allowed for work external to the signal cabinet.
 - c. The United States Department of Labor - Bureau of Apprenticeship and Training may be substituted for the IMSA Level I Traffic Signal Electrician requirement.
3. All vehicle and pedestrian indications shall be approved solid state LED type. All vehicle and pedestrian head housings shall be yellow in color. Luminaires shall be LED (8500 Lumens) at 40-foot mounting height.
4. Traffic signals that are mounted on mast arms shall be furnished with mounting brackets and black louvered backing plates. All signal heads to be centered over outbound lanes as per plans. Signal backplates shall include yellow retroreflective border.
5. Installation shall include ADA pedestrian push buttons. Pedestrian push button signs shall conform to MUTCD or r103b.
6. The signal shall not be put in flash mode or made fully operational until CDOT has inspected and approved the installation, and all pavement markings are in place. The existing or temporary traffic signal shall remain operational until the new signal is tested and approved by the engineer for operational service. Contact Dave Pierce, Region 2 (719-546-5499)
7. All used or excess signal equipment shall remain the property of CDOT and delivered to the Region 2 signal shop; contact Dave Pierce, Region 2 (719-546-5499).
8. Measurement and payment of traffic signal construction items shall conform to the project specifications.
9. All items not shown in the traffic signal quantities shall be considered incidental to the construction of the traffic signals and will not be paid & measured separately. All quantities are approximate. The contractor shall be responsible for all work necessary to complete the construction shown on the plans to build a complete and functioning system.
10. The contractor shall field verify all mast arm lengths with Dave Pierce (719-546-5499), prior to ordering the mast arms.
11. Should contractor incur water in the caisson excavation, any de-watering methods & necessary permits shall be included in the cost of the caisson.
12. All conduits shall have a pull rope left in them when construction is completed. All conduit under the roadway shall be directionally bored a minimum of 3' below existing pavement. Directionally bored conduit and fittings shall be HDPE 3408.
13. All signal cable shall be continuous from connections made in the hand-hole compartment of signal pole base to the terminal compartment in the controller cabinet. Splicing shall not be permitted.
14. Signal heads shall be bagged with a heavy black plastic until ready for operation.
15. All removed luminaires and poles shall remain property of CDOT.
16. All camera detector lead-in cables are continuous from the controller to the camera detectors. No splices will be permitted. Camera detectors shall be mounted in accordance with the manufacturer recommendations and approved by CDOT. All cameras shall be mounted on signal mast arms with a 5' extension arm (to be included in the cost).
17. Contractor shall complete all work necessary for the operation of the system, and shall contact CDOT traffic operations. Contact Eric Lundberg, Region 2 (719-546-5405), to schedule a compliance inspection prior to flash operation. Upon completion of the inspection, the field operation testing shall begin. The complete traffic system shall be fully operational and fully tested at the completion of the project.
18. Traffic signals will need to run for a minimum of 15 days without any issues, as identified by Region 2 Traffic Operations (Contact Eric Lundberg, at 719-546-5405), before the project will be accepted.
19. Pull box locations are approximate. Actual locations shall be verified in the field by the engineer. All pull boxes shall be flush with finished ground surface. Pull boxes shall not be spaced farther than 200' apart.
20. Prior to all milling or planing operation at signalized intersections, all video detection equipment called out in the plans shall be in place and shall be operational. All video detection changes during milling or planing operations and striping reconfiguration will not be measured and paid for separately but shall be included in the work.
21. No excavation shall be permitted until underground utilities have been located to the satisfaction of all parties. The Contractor shall be responsible for protecting all utilities above and below ground during construction. Contact the Utility Notification Center of Colorado (UNCC) to have locations of UNCC registered lines marked by member companies. Call 811 for all locations. For location of CDOT utilities, contact Joe Trevizo at 719-546-574. All other utilities shall be located by contacting the respective company.
22. Two or more weeks prior to the start of construction, the Contractor shall submit temporary phasing and timing signal plans to the Engineer for approval.
23. Contractor's signal electrician is required to be on site, at a minimum, during AM & PM peak hours following the next day a signal is turned on to observe operation and make adjustments as needed. Signal electrician's additional hours may be required by the Engineer. This applies to both permanent and temporary installations.
24. The Contractor shall provide CDOT with at least four (4) sets of equipment specifications/descriptions and obtain approvals prior to ordering the equipment.
25. The Contractor shall adjust the existing traffic signal interconnects in the project area, as necessary.
26. All manuals, installation guides and associated equipment shall be provided to the Engineer at time of inspection.

ITEM NO.	DESCRIPTION	UNIT	US 50 INTERSECTION				TOTAL
			McCULLOCH BLVD	PURCELL BLVD	PUEBLO BLVD	WILLS BLVD	
202-00040	REMOVAL OF ELECTRICAL CONDUIT	LF				30	30
202-00750	REMOVAL OF LUMINAIRE	EA			2	1	3
202-00825	REMOVAL OF FLASING BEACON	EA	1	1			2
202-00827	REMOVAL OF PULL BOX	EA			2	2	4
202-00831	REMOVAL OF TRAFFIC SIGNAL HEAD	EA		2			2
202-00840	REMOVAL OF TRAFFIC SIGNAL POLE	EA			2	1	3
202-00858	REMOVAL OF PEDESTAL POLE	EA				1	1
202-00860	REMOVAL OF PEDESTRIAN PUSH BUTTON	EA		2			2
210-00476	RESET MICROWAVE VEHICLE RADAR DETECTOR (MVRD)	EA		1	1	1	3
210-00815	RESET SIGN PANEL	EA				1	1
210-00890	RESET INTERSECTION DETECTION SYSTEM (CAMERA)	EA			2	4	6
503-00012	DRILLED CAISSON (12 INCH)	LF				2	7
503-00018	DRILLED CAISSON (18 INCH)	LF	4				4
503-00036	DRILLED CAISSON (36 INCH)	LF				19	19
503-00048	DRILLED CAISSON (48 INCH)	LF				21	21
613-00206	2 INCH ELECTRICAL CONDUIT (BORED)	LF	234		300	125	659
613-00306	3 INCH ELECTRICAL CONDUIT (BORED)	LF			600	200	800
613-07023	PULL BOX (24"X36"X24") *	EA		1	3	2	6
613-10000	WIRING **	LS	0.25			0.25	0.75
613-13006	LUMINARE (LED) (8500 LUMENS)	EA			2	1	3
614-00011	SIGN PANEL (CLASS I)	SF	15.0		53.5	33.1	102
614-70150	PEDESTRIAN SIGNAL FACE (16) (COUNTDOWN)	EA			6	2	8
614-70336	TRAFFIC SIGNAL FACE (12-12-12)	EA			8	3	11
614-70448	TRAFFIC SIGNAL FACE (12-12-12-12)	EA			2	1	3
614-72860	PEDESTRIAN PUSH BUTTON	EA			6	1	7
614-72863	PEDESTRIAN PUSH BUTTON POST ASSEMBLY	EA					
614-81150	TRAFFIC SIGNAL-LIGHT POLE STEEL (1-50 FOOT MAST ARM)	EA			1		1
614-81160	TRAFFIC SIGNAL-LIGHT POLE STEEL (1-60 FOOT MAST ARM)	EA			1	1	2

* PULL BOX QTY INCLUDES (1) PULL BOX EACH AT PURCELL BLVD AND PUEBLO BLVD FOR FLASHING BEACON RESETS (SEE SIGNING AND STRIPING PLAN FOR LOCATION).

** QTY INCLUDES WIRING FOR ITEMS SUCH AS DETECTION SYS. (CAMERA) AND FLASHING BEACON; REMAINING WIRING LS QUANTITY FOR VMS.

TAB. OF SIG. QTY- CARRIED FORWARD TO SUMMARY OF TRAFFIC ENGINEERING ITEMS AND PROVIDED HERE FOR INFO ONLY

Print Date: 10/9/2014

File Name: 19056_Traffic_Signal_Gen_Notes.dgn

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US 50 WEST
PURCELL BLVD. TO WILLS BLVD.
TRAFFIC SIGNAL PLANS
Designer: ACE
Detailer: ACE
Subset: SIG
Subset Sheets: SIG1 of 4

Project No./Code
FSA 0503-081
19751
Sheet Number 279



Know what's below.
Call before you dig.

REMOVE EXISTING PEDESTRIAN SIGNAL HEAD
AND PUSH BUTTON ACROSS CROSS
WALK

NOTE:
MAINTAIN EXISTING POWER SOURCE.
EXISTING TRAFFIC SIGNAL EQUIPMENT (EXCEPT PEDESTRIAN SIGNALS) TO REMAIN IN PLACE.
CONTRACTOR TO RESET MICROWAVE VEHICLE RADAR DETECTOR AND TO ENSURE THAT ALL
EXISTING TRAFFIC DETECTION STRATEGIES (AT THE INTERSECTION AS WELL AS THE
CORRIDOR) ARE ADJUSTED TO ACCOMMODATE ADDITIONAL LANE.

REMOVE EXISTING PEDESTRIAN SIGNAL HEAD
AND PUSH BUTTON

EXISTING SIGNAL POLE, PULL BOX
AND CONDUIT TO REMAIN IN PLACE

REMOVE EXISTING CROSS
WALK STRIPING

RESET FLASHING BEACON IN-PLACE
WITH PROPOSED PULL BOX
(24"X36"X24") AT STA 105+85; 35' RT.
REFER SIGNING PLANS

EB US 50

96+00

97+00

99+00

100+00

PURCELL BLVD.




0' 15' 30' 60'

ABANDON ELECTRICAL
CONDUIT IN PLACE

REMOVE FLASHING BEACON

LEGEND

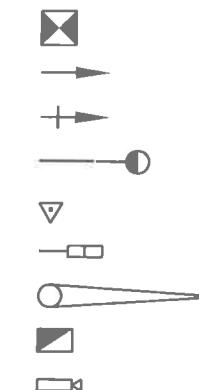

- CONTROLLER CABINET
- SIGNAL FACE WITHOUT BACKPLATE
- SIGNAL FACE WITH BACKPLATE
- LUMINAIRE (LED) (8500 LUMENS)
- PEDESTRIAN PUSH BUTTON
- PEDESTRIAN SIGNAL FACE
- SIGNAL POLE MAST ARM
- PULL BOX
- VIDEO DETECTION CAMERA

Print Date: 10/9/2014

File Name: I9056INT-SIG-02.dgn

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US 50 WEST
PURCELL BLVD.
TRAFFIC SIGNAL PLANS

Project No./Code

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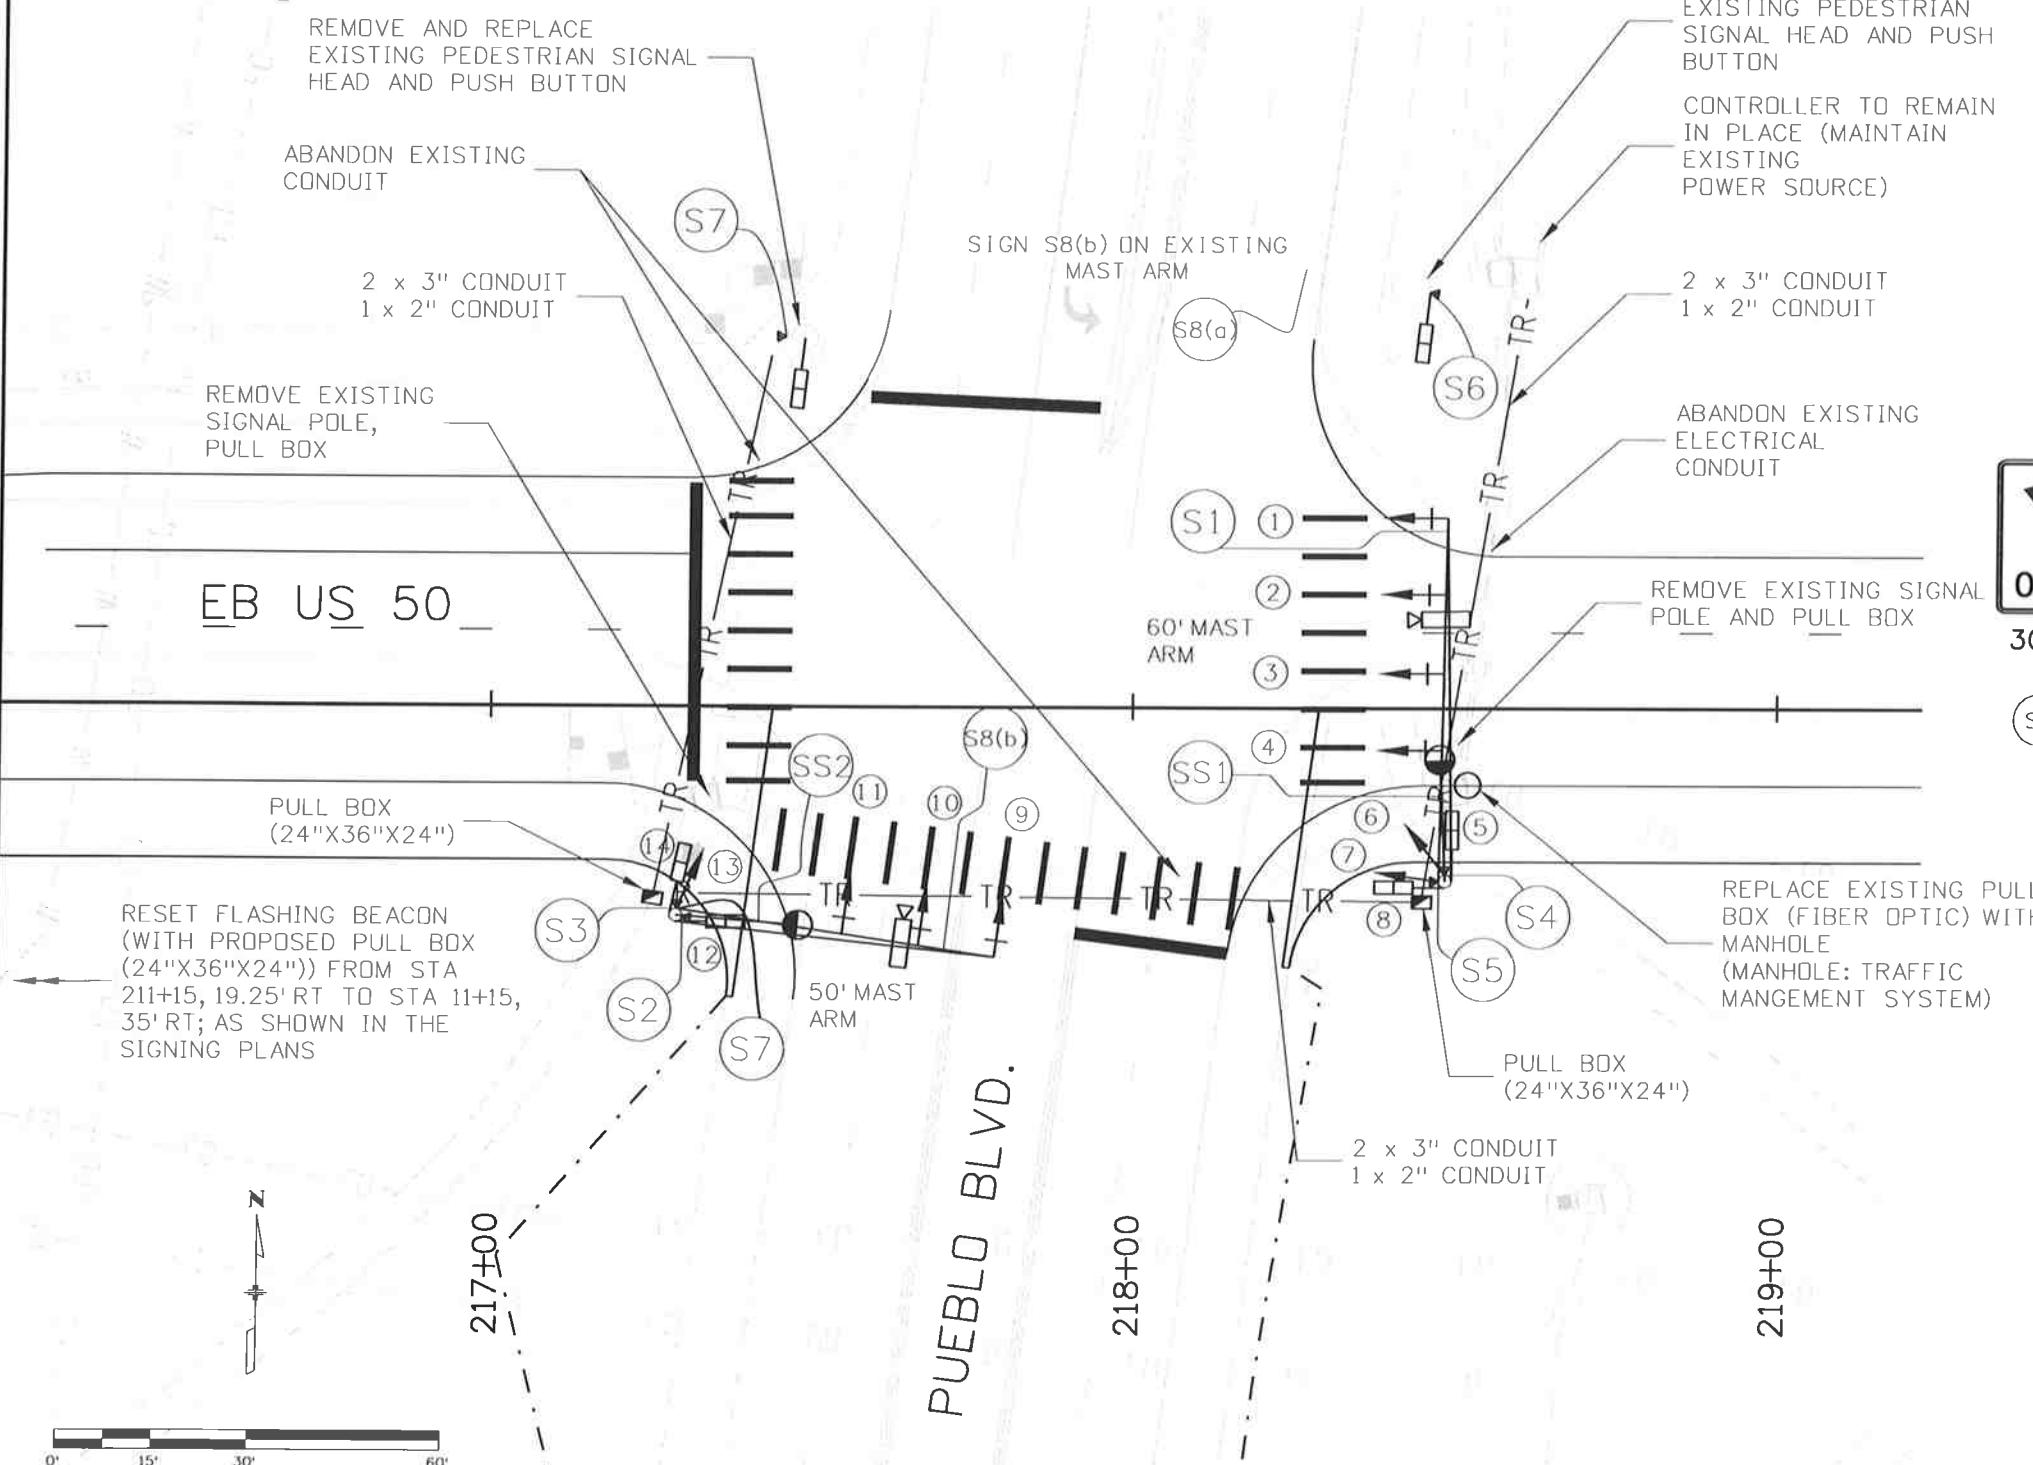
Sheet Number 280

Subset: SIG Subset Sheets: SIG2 of 4




Know what's below.
Call before you dig.


NOTE:
MAINTAIN EXISTING POWER SOURCE.
EXISTING SIGNAL CONTROLLER TO REMAIN IN PLACE.
MAINTAIN EXISTING SIGNAL PHASING.
CONTRACTOR TO RESET CAMERA AND MICROWAVE VEHICLE RADAR DETECTORS AND TO ENSURE THAT ALL EXISTING TRAFFIC DETECTION STRATEGIES (AT THE INTERSECTION AND ALONG THE US 50 CORRIDOR) ARE ADJUSTED TO ACCOMMODATE ADDITIONAL LANE.



TRAFFIC SIGNAL HEADS

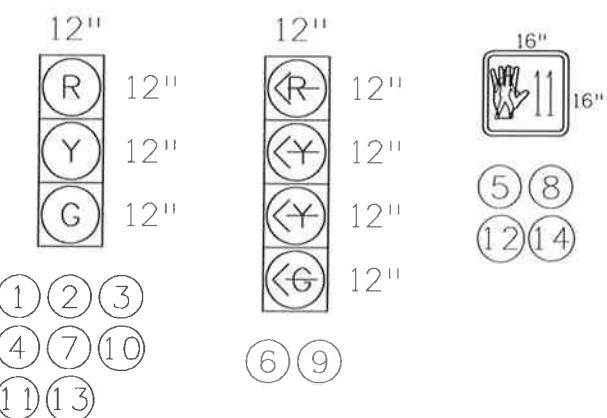

SIGNS

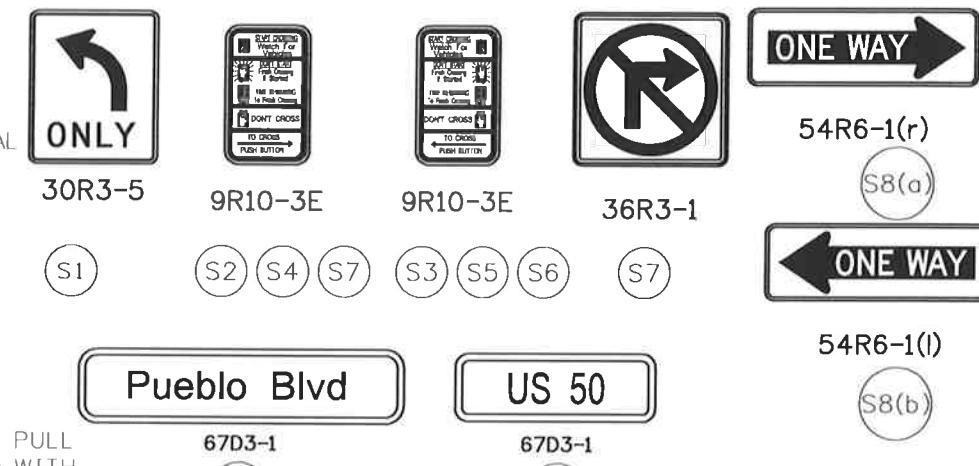

LEGEND

- CONTROLLER CABINET
- SIGNAL FACE WITHOUT BACKPLATE
- ↔ SIGNAL FACE WITH BACKPLATE
- LUMINAIRE (LED) (8500 LUMENS)
- ▼ PEDESTRIAN PUSH BUTTON
- PEDESTRIAN SIGNAL FACE
- SIGNAL POLE MAST ARM
- PULL BOX
- VIDEO DETECTION CAMERA

Print Date: 10/9/2014

File Name: 19056INT-SIG-03.dgn

Horiz. Scale: 1:30

Vert. Scale: As Noted



J. F. SATO AND ASSOCIATES
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Sheet Revisions

Date:	Comments	Init.

Colorado Department of Transportation



902 Erie Avenue
Pueblo, CO 81001
Phone: 719-562-5509 FAX: 719-546-5702

DTD

As Constructed

No Revisions:

Revised:

Void:

US 50 WEST PUEBLO BLVD. TRAFFIC SIGNAL PLANS

Project No./Code

FSA 0503-081



19751

Sheet Number 281




**Know what's below.
Call before you dig.**

NOTE:
MAINTAIN EXISTING POWER SOURCE.
EXISTING SIGNAL CONTROLLER TO REMAIN IN PLACE.
MAINTAIN EXISTING SIGNAL PHASING.
CONTRACTOR TO RESET CAMERA AND MICROWAVE VEHICLE RADAR
DETECTORS AND TO ENSURE THAT ALL EXISTING TRAFFIC DETECTION
STRATEGIES (AT THE INTERSECTION AS WELL AS THE US 50
CORRIDOR) ARE ADJUSTED TO ACCOMMODATE ADDITIONAL LANE.
SURVEY SHOWN FOR EAST SIDE OF INTERSECTION IS NOT CURRENT.

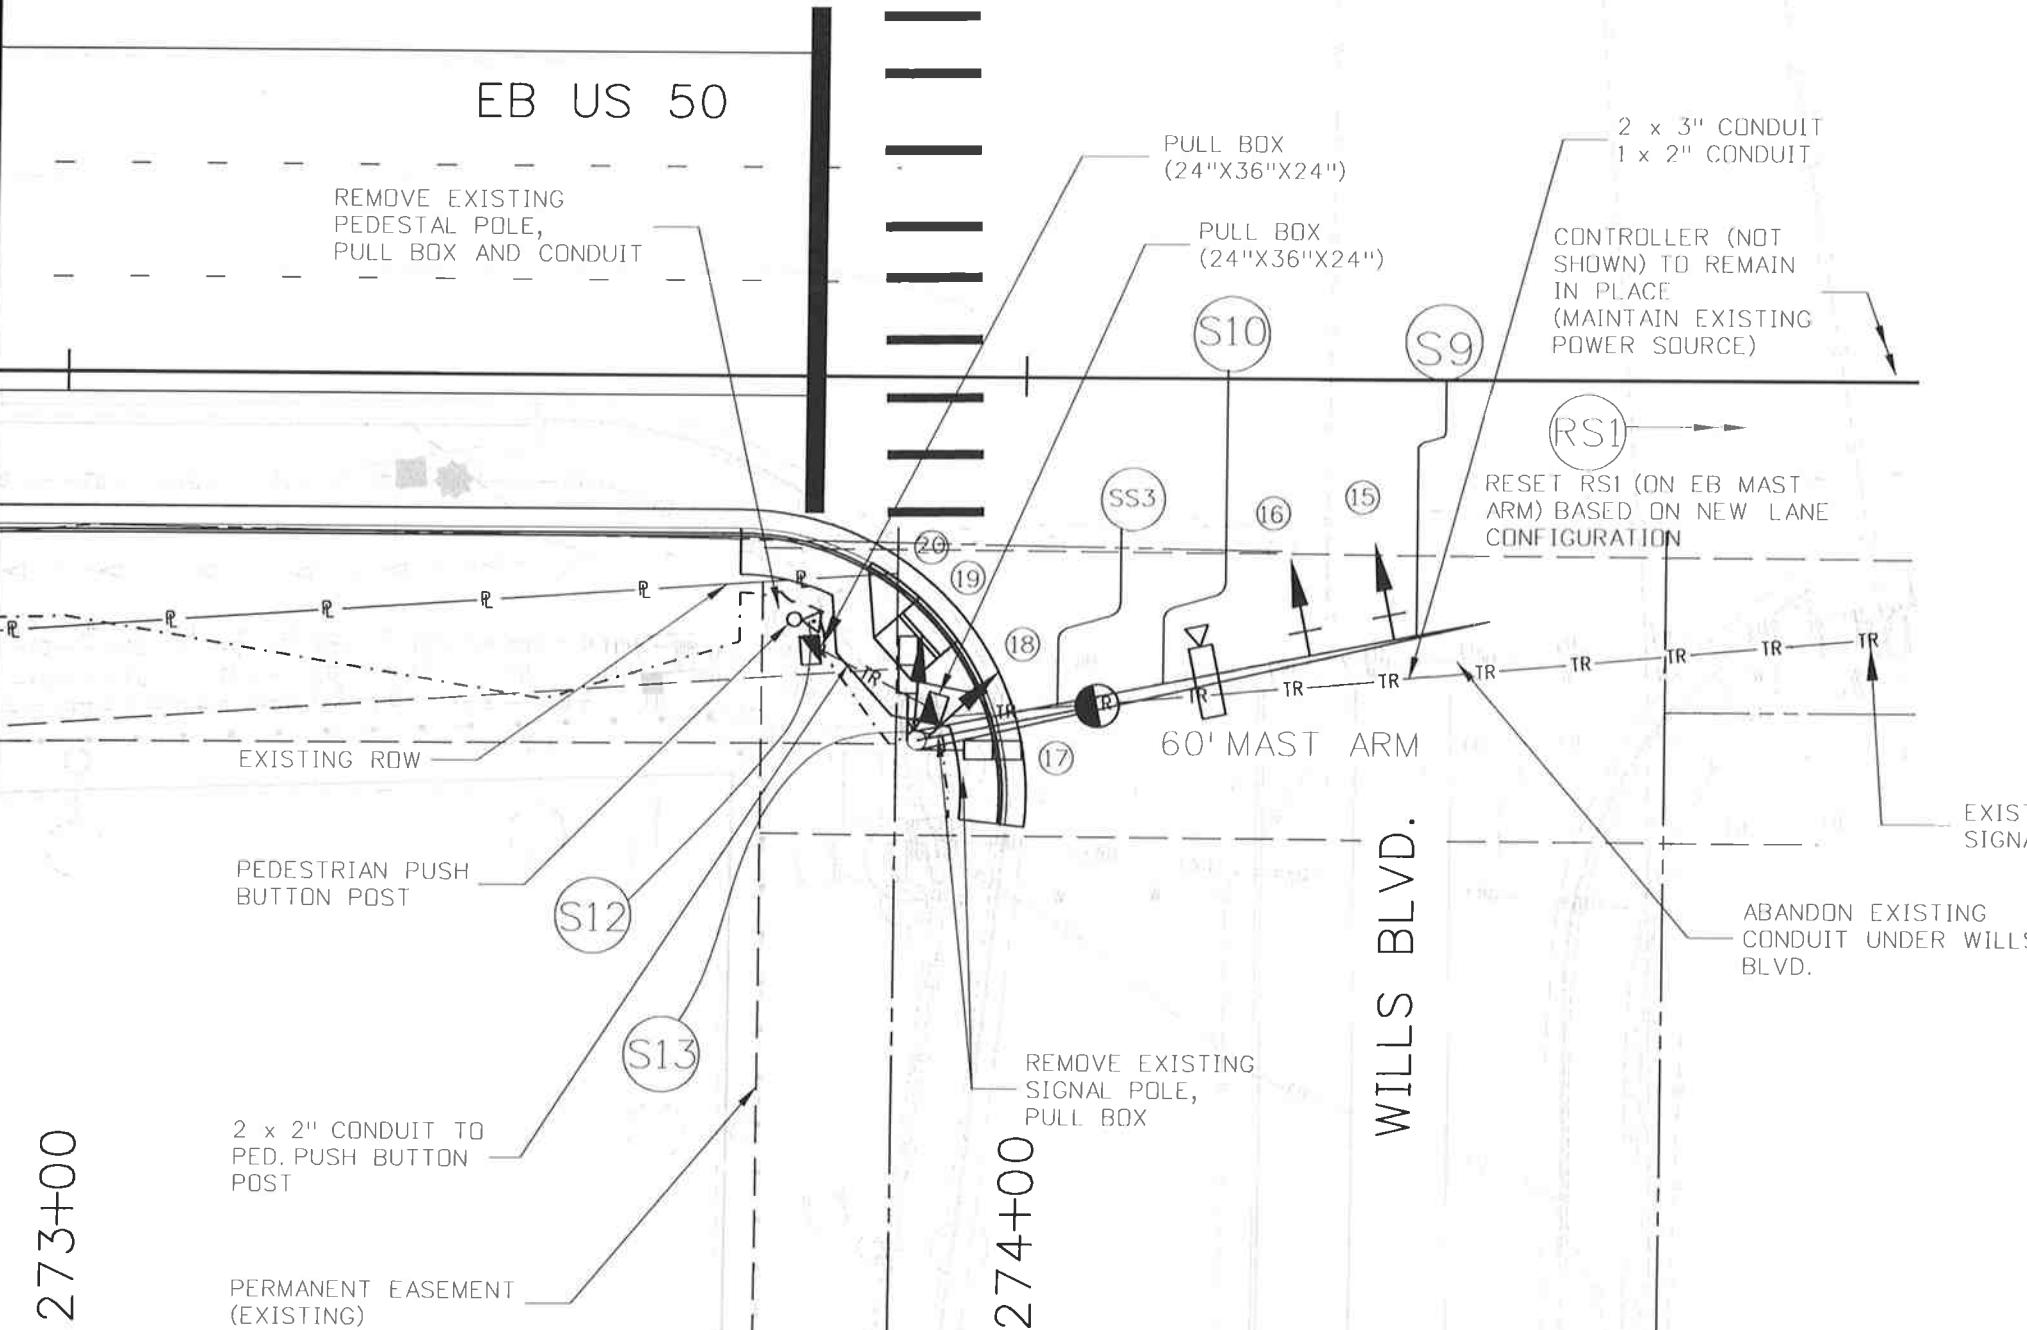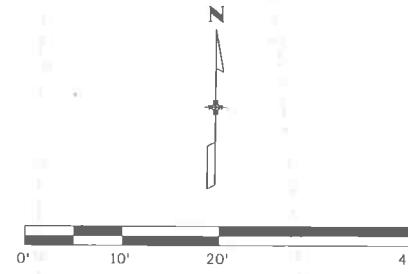

TRAFFIC SIGNAL HEADS

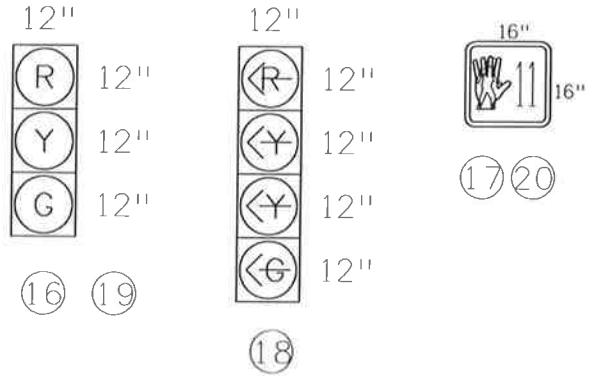

SIGNS



LEGEND

- █ CONTROLLER CABINET
- SIGNAL FACE WITHOUT BACKPLATE
- + SIGNAL FACE WITH BACKPLATE
- LUMINAIRE (LED) (8500 LUMENS)
- ▼ PEDESTRIAN PUSH BUTTON
- ▬ PEDESTRIAN SIGNAL FACE
- ▬ SIGNAL POLE MAST ARM
- ▬ PULL BOX
- ▬ VIDEO DETECTION CAMERA

Print Date: 10/9/2014

File Name: 19056INT-SIG-04.dgn

Horiz. Scale: 1:20.1

Vert. Scale: As Noted

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No Revisions:

Revised:

Void:

US 50 WEST WILLS BLVD. TRAFFIC SIGNAL PLANS

Project No./Code

FSA 0503-081

19751

Sheet Number 282

Subset: SIG Subset Sheets: SIG4 of 4

Sign No.	Location	Station	Direction		Side	Sign Code	Sign Panel Size			Backgrnd. Color	Sign Panel			Steel Sign Supp. (P) (2" Round)		Steel Sign Supp. (P1) (2.5" Round)		Steel Post (W Shape) W6x15 Beam	Concrete Footing Type2	Reset Flashing Beacon						
			Bound	Facing			W"	x	H"		Class I	Class II	Class III	Socket	Post	Each	LF									
1	McCulloch Blvd.	700+41	NB	South	RT	R10-15R	36	x	30	Yellow Green								1	10							
2	Purcell Blvd.	1+00.31	NB	South	RT	R5-1	36	x	36	Yellow Green		9						1	10							
3	Purcell Blvd.	1+00.31	NB	South	RT	R10-15R	36	x	30	Yellow Green		8						1	11							
4	Purcell Blvd.	3+64	NBR	South	RT	W4-3	48	x	48	Yellow		16						1	12							
5	US 50	113+68	EB	West	RT	M3-2	36	x	18	White		5						1	12							
6	US 50	113+68	EB	West	RT	M1-4	36	x	36	White		9						1	12							
7	US 50	108+15	EB	West	RT	D50-1C	36	x	48	Blue		12						1	12							
8	US 50	107+95	EB	West	RT	D10-3	12	x	48	Green	4						1	12								
R1	US 50	105+88	EB	East	LT	W3-4	36	x	36	Yellow		9									1					
R2	US 50	105+88	EB	East	LT	W16-13	24	x	18	Yellow		3														
9	US 51	113+00	EB	West	LT	R4-50	36	x	45	White		11						1	11							
10	US 50	124+00	EB	West	RT	R2-4a	36	x	72	White		18						1	13							
11	US 50	124+00	EB	West	LT	R2-1	36	x	48	White		12						1	11							
12	US 50	160+40	EB	West	RT	D10-3	12	x	48	Green	4						1	12								
13	US 50	198+41	EB	West	RT	W3-3	48	x	48	Yellow		16						1	11							
14	US 50	194+44	EB	West	RT	SP-1	120	x	102	Green/Brown			85						34	2						
15	US 50	186+24	EB	West	RT	SP-2	126	x	96	Green		84							33	2						
16	US 50	213+50	EB	West	RT	M3-2	36	x	18	White		5														
17	US 50	213+50	EB	West	RT	M1-4	36	x	36	White		9						1	14							
18	US 50	213+50	EB	West	RT	M6-3	30	x	21	White		4														
R3	US 50	211+20	EB	West	RT																1					
19	US 50	206+44	EB	West	RT	SP-3	126	x	102	Green		89							33	2						
20	US 50	206+00	EB	West	RT	D10-3	12	x	48	Green	4						1	12								
21	US 50	202+44	EB	West	RT	R2-1	36	x	48	White		12						1	11							
22	US 50	211+15	EB	West	RT	W16-13P	30	x	24	Yellow		5						1	13							
23	US 50	211+15	EB	West	RT	W3-4	48	x	48	Yellow		16														
24	US 50	211+15	EB	West	RT	W16-13P	30	x	24	Yellow		5						1	13							
25	US 50	211+15	EB	West	RT	W3-4	48	x	48	Yellow		16														
26	US 50	213+80	EB	East	LT	R5-1a	42	x	30	Red		9						1	10							
27	US 50	213+80	EB	East	LT	R5-1a	42	x	30	Red		9						1	10							
28	US 50	217+20	EB	East	RT	R5-1	36	x	36	White		9						1	10							
29	US 50	217+20	EB	East	LT	R5-1	36	x	36	White		9						1	10							
30	US 50	217+36	EB	South	RT	R6-1	54	x	18	White		7						1	9							

SHEET 1 SUBTOTALS

12 208 259 3 36 13 152 100 6 2

Print Date: 10/9/2014

File Name: 19056 TAB_Sign_1.dgn


Horiz. Scale: 1:100 Vert. Scale: As Noted

JFS&A
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Sheet Revisions

Date:	Comments	Init.



Region 2

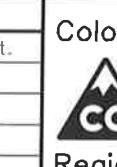902 Erie Avenue
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DTD

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No Revisions:	
Revised:	Designer: AB Detailer: AB
Void:	Subset: SGT Subset Sheets: SGT1 of 3

US 50 WEST
PURCELL BLVD. TO WILLS BLVD.
TAB OF SIGNING & PVMT MARKING

Project No./Code
FSA 0503-081
19751
Sheet Number 283

Sign No.	Location	Station	Direction		Side	Sign Code	Sign Panel Size			Backgrnd. Color	Sign Panel			Steel Sign Supp. (P) (2" Round)		Steel Sign Supp. (P1) (2.5" Round)		Steel Post (W Shape)		Concrete Footing Type2	Reset Flashing Becon					
			Bound	Facing			W"	X	H"		Class I	Class II	Class III	Socket	Post	Slipbase	Post	W6x15								
											Each	LF	Each	LF	LF	Each	LF	Each	Each							
31	US 50	217+40	EB	North	RT	R6-1	54	x	18	White		7					1	9								
32	US 50	236+00	EB	West	RT	R2-1	36	x	48	White		12					1	11								
33	US 50	231+00	EB	West	RT	M3-2	36	x	18	White		5					1	12								
34	US 50	231+00	EB	West	RT	M1-4	36	x	36	White		9					1	10								
35	US 50	245+46	EB	West	LT	R5-1a	42	x	30	Red		9					1	10								
36	US 50	245+46	EB	West	LT	R5-1a	42	x	30	Red		9					1	10								
37	US 50	247+72	EB	West	LT	R5-1	36	x	36	White		9					1	10								
38	US 50	247+72	EB	West	LT	R5-1	36	x	36	White		9					1	10								
39	US 50	248+50	EB	West	RT	R6-1	54	x	18	White		7					1	10								
40	US 50	248+50	EB	West	RT	R6-1	54	x	18	White		7					1	10								
41	US 50	249+15	EB	West	RT	R6-1	54	x	18	White		7					1	13								
42	US 50	249+15	EB	West	RT	R1-1	36	x	36	Red		9					28		2							
43	US 50	249+15	EB	West	RT	R3-2	36	x	36	White		9					1	10								
44	US 50	266+13	EB	West	RT	SP-4	168	x	84	Brown		98														
45	US 50	265+07	EB	West	RT	R2-1	36	x	48	White		12					1	11								
46	US 50	263+90	EB	West	RT	D10-3	12	x	48	Green	4					1	12									
47	US 50	262+59	EB	West	RT	R3-7r	30	x	30	White	6					1	11									
48	US 50	261+40	EB	West	RT	D50-3	84	x	48	Green		28					2	22								
49	US 50	273+35	EB	West	RT	R5-1	36	x	36	White		9					1	10								
50	US 50	272+16	EB	West	RT	R3-7r	30	x	30	White	6					1	11									
SHEET 2 SUBTOTALS											17	127	126	3	34	13	138	28	2	0						
SHEET 1 SUBTOTALS											12	208	259	3	36	13	152	100	6	2						
PROJECT TOTALS											29	335	385	6	70	26	290	128	8	2						

Print Date: 10/9/2014

File Name: 19056 TAB_Sign_1.dgn

Horiz. Scale: 1:100

Vert. Scale: As Noted




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Sheet Revisions

Date:	Comments	Init.



Colorado Department of Transportation
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Region 2

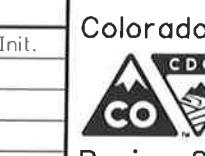DTD

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Revised:	
Void:	

US 50 WEST PURCELL BLVD. TO WILLS BLVD. TAB OF SIGNING & PVMT MARKING	
Designer: AB	Structure Numbers
Detailer: AB	Numbers
Subset: SGT	Subset Sheets: SGT2of 3

Project No./Code
FSA 0503-081
19751
Sheet Number 284