


### NOTES:

- A FENCE (PLASTIC) CONFORMING TO SECTION 607 SHALL BE INSTALLED AROUND THE CONCRETE WASHOUT AREA, EXCEPT AT THE OPENING.
- THE CONCRETE WASHOUT SIGN SHALL HAVE LETTERS AT LEAST 3 INCHES HIGH AND CONFORM TO SUBSECTION 630.02.
- 3. ALL MATERIALS AND LABOR TO COMPLETE THE CONCRETE WASHOUT STRUCTURE SHALL BE INCLUDED IN THE COST OF WORK AND NOT PAID FOR SEPARATELY.
- 4. THE BOTTOM OF EXCAVATION SHALL BE A MINIMUM OF FIVE FEET ABOVE GROUND WATER. IF NOT, IT SHALL BE LINED WITH AN IMPERMEABLE SYNTHETIC LINER THAT IS DESIGNED TO CONTROL SEEPAGE AT A MAXIMUM RATE OF 6 TO 10 CENTIMETERS PER SECOND.
- 5. THE PAY ITEM NUMBER FOR CONCRETE WASHOUT STRUCTURE (EACH) IS 208-00045.

### CONCRETE WASHOUT STRUCTURE

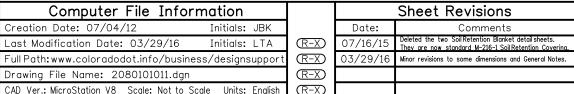

### Colorado Department of Transportation




### TEMPORARY EROSION CONTROL

M-208-1

Issued By: Project Development Branch on July 4, 2012

STANDARD PLAN NO.

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PLAN VIEW

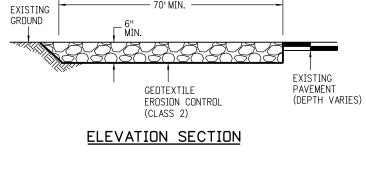AGGREGATE


(SEE NOTE 1)

EXISTING PAVEMENT

SHALL EXTEND FULL WIDTH

OF INGRESS AND EGRESS

OPERATION.

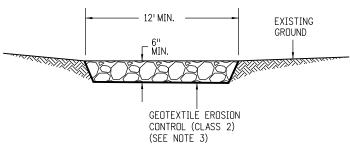


### SECTION B-B


### NOTES:

EXISTING GROUND


- 1. AGGREGATE SHALL CONFORM TO SUBSECTION 208.02 (K).
- 2. THE CONTRACTOR SHALL PROTECT CURB AND GUTTER THAT CROSSES THE ENTRANCE FROM DAMAGE. PROTECTION OF THE CURB AND GUTTER SHALL BE INCLUDED IN THE COST OF WORK AND NOT PAID FOR SEPARATELY.
- 3. GEOTEXTILE SHALL CONFORM TO SUBSECTION 712.08.
- ALL MATERIALS AND LABOR TO COMPLETE THE VEHICLE TRACKING PAD SHALL BE INCLUDED IN THE COST OF WORK AND NOT PAID FOR SEPARATELY.
- 5. THE PAY ITEM NUMBER FOR VEHICLE TRACKING PAD (EACH) IS 208-00070.

### VEHICLE TRACKING PAD

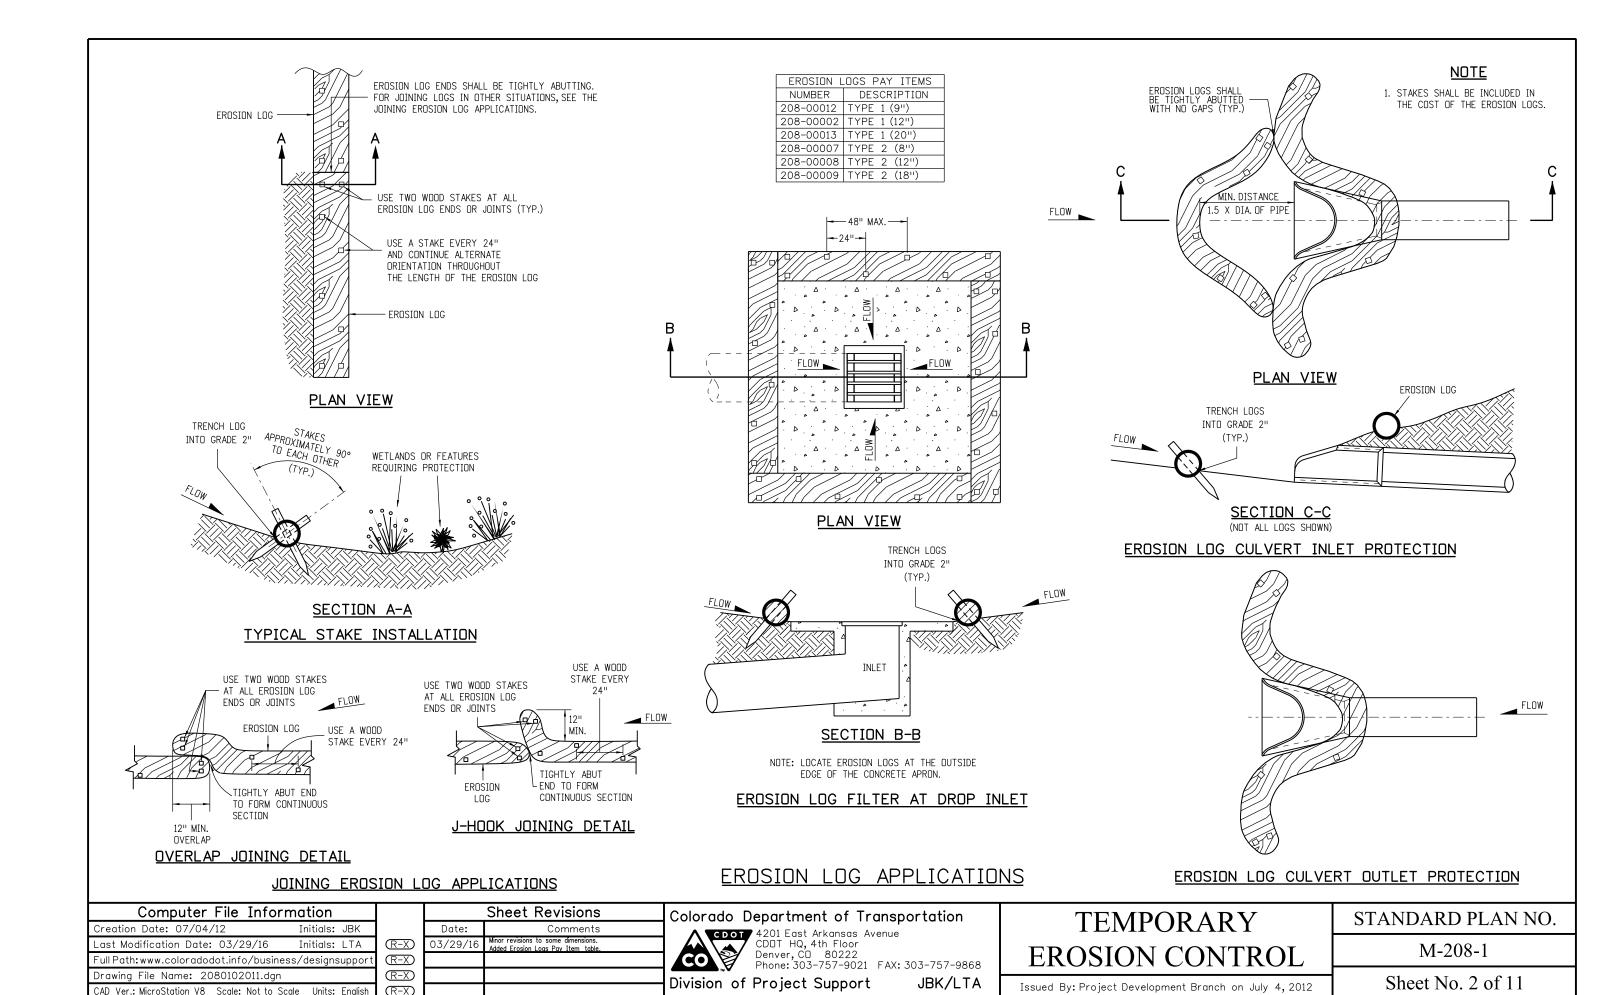

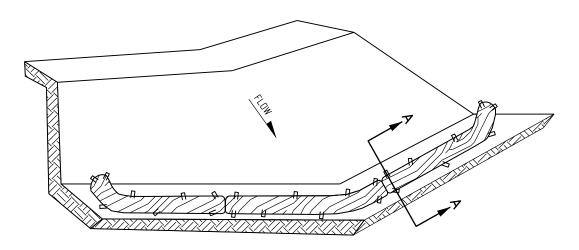

### ISOMETRIC VIEW

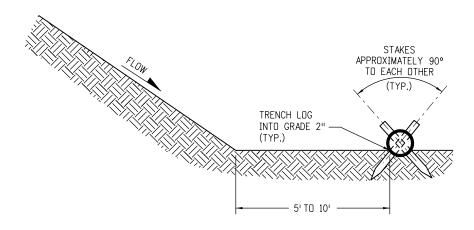

### SECTION A-A

EROSION LOG TOE OF SLOPE PROTECTION


### NOTES:

- 1. EROSION LOGS USED AT TOE OF SLOPE SHALL BE PLACED 5 TO 10 FEET BEYOND TOE OF SLOPE TO PROVIDE STORAGE CAPACITY.
- 2. EROSION LOGS SHALL BE PLACED ON THE CONTOUR WITH ENDS FLARED UP SLOPE.
- 3. SEE SHEET 2 OF 11 FOR JOINING LOGS DETAIL.


EROSION L	OGS PAY ITEMS
NUMBER	DESCRIPTION
208-00012	TYPE 1 (9")
208-00002	TYPE 1 (12")
208-00013	TYPE 1 (20")
208-00007	TYPE 2 (8")
208-00008	TYPE 2 (12")
208-00009	TYPE 2 (18")

### **NOTES**

- 1. SILT FENCE SHALL HAVE A MAXIMUM DRAINAGE AREA OF ONE-QUARTER ACRE PER 100 FEET OF SILT FENCE LENGTH; MAXIMUM SLOPE LENGTH BEHIND BARRIER IS 100 FEET; MAXIMUM GRADIENT BEHIND THE BARRIER IS 2:1.
- 2. SILT FENCE USED AT TOE OF SLOPE SHALL BE PLACED 5 TO 10 FEET BEYOND TOE OF SLOPE TO PROVIDE STORAGE CAPACITY.
- 3. SILT FENCE SHALL BE PLACED ON THE CONTOUR WITH ENDS FLARED UP SLOPE.
- 4. THE MAXIMUM LENGTH OF EROSION LOGS OR SILT FENCES WITHOUT A FLARED END TURNING UPSLOPE IS 150 FEET.

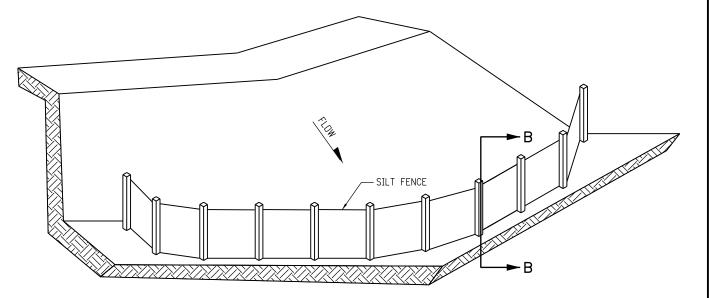

### ISOMETRIC VIEW

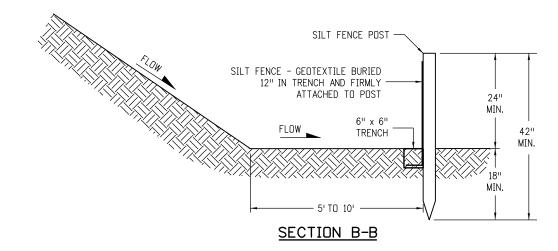

### SILT FENCE TOE OF SLOPE PROTECTION

NOTE: THE PAY ITEM NUMBER FOR SILT FENCE (LF) IS 208-00020.

### TOE OF SLOPE PROTECTION APPLICATIONS

Computer File Info	mation
Creation Date: 07/04/12	Initials: JBK
Last Modification Date: 03/29/16	Initials: LTA
Full Path: www.coloradodot.info/busin	ss/designsupport
Drawing File Name: 2080103011.dgr	
CAD Ver.: MicroStation V8 Scale: Not to S	cale Units: English

	Sheet Revisions			
	Date:	Comments		
$\overline{\mathbb{R}-X}$	03/29/16	Minor revisions to some dimensions. Added Erosion Logs Pay Item table.		
$\overline{R-X}$				
R-X				
$\mathbb{R}$ -X				

### Colorado Department of Transportation




<b>TEMPORARY</b>
<b>EROSION CONTROL</b>

STANDARD PLAN NO.

M-208-1

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Sheet No. 3 of 11

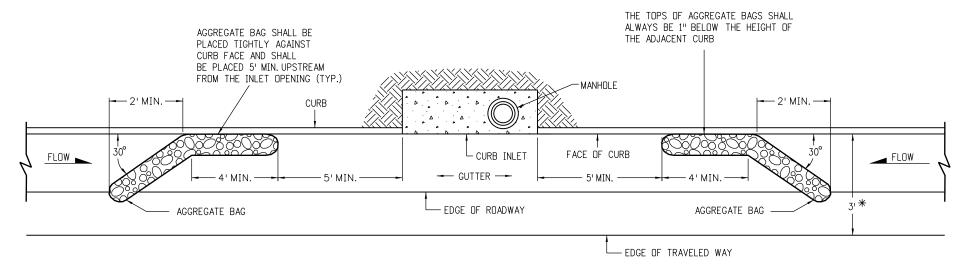


### PLAN VIEW


\* NOTE: USE AGGREGATE BAGS ONLY WHEN THERE IS A MINIMUM CLEARANCE OF 3 FEET FROM THE EDGE OF THE TRAVELED WAY TO THE FACE OF CURB.

LENGTH OF INLET	NUMBER OF AGGREGATE BAGS UPSTREAM OF
(L)	INLET
0' - 5'	1
6' -10'	2
L > 10'	3

AGGREGATE BAGS AT STORM DRAIN INLET (TYPE I)

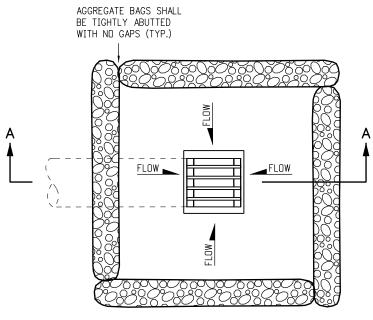

### PLAN VIEW

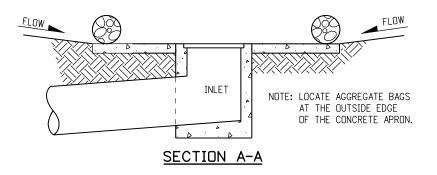

AGGREGATE BAGS AT DROP INLET

### AGGREGATE BAG APPLICATIONS

NOTE: THE PAY ITEM NUMBER FOR AGGREGATE BAG (LF) IS 208-00035

Computer File Information	Π
Creation Date: 07/04/12 Initials: JBK	]
Last Modification Date: 03/29/16 Initials: LTA	]
Full Path: www.coloradodot.info/business/designsupport	]
Drawing File Name: 2080104011.dgn	]
CAD Ver.: MicroStation V8 Scale: Not to Scale Units: English	1
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	Sheet Revisions				
	Date:	Comments			
$\mathbb{R}$ -X	03/29/16	Added some dimensions and Note.			
(R-X)					
$\overline{R-X}$					
(R-X)					

### Colorado Department of Transportation





TEMPORARY	
EROSION CONTROL	

STANDARD PLAN NO. M-208-1

Issued By: Project Development Branch on July 4, 2012

Sheet No. 4 of 11

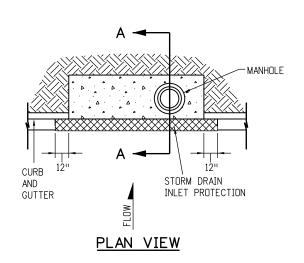

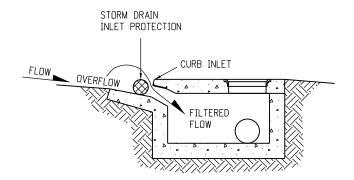


### <u>SECTION A-A</u>


### STORM DRAIN INLET PROTECTION (TYPE I)

### NOTES


- 1. INLET PROTECTION DEVICE SHALL EXTEND 12 INCHES PAST EACH END
- 2. THE PAY ITEM NUMBER FOR STORM DRAIN INLET PROTECTION (TYPE I) (EACH) IS 208-00051.
- 3. FOR STORM DRAIN INLET TYPES I AND II, IF THERE IS A MINIMUM CLEARANCE OF 3 FEET FROM THE EDGE OF THE TRAVELED WAY TO THE FACE OF CURB, USE THE AGGREGATE BAGS AT STORM DRAIN INLET (TYPE I) DETAIL ON SHEET 4 INSTEAD.

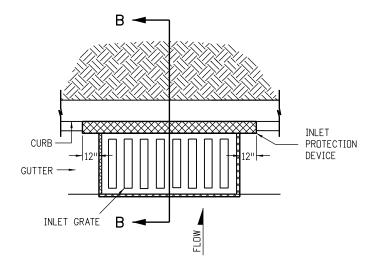

### PLAN VIEW

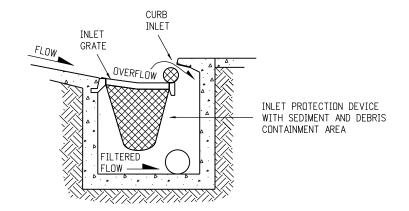


# SECTION B-B OPTION A STORM DRAIN INLET PROTECTION (TYPE II)

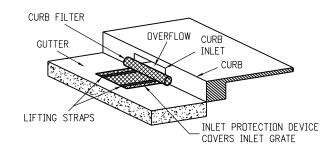


# ISOMETRIC VIEW OPTION B STORM DRAIN INLET PROTECTION (TYPE II)

NOTE: THE PAY ITEM NUMBER FOR STORM DRAIN INLET PROTECTION (TYPE II) (EACH) IS 208-00052.

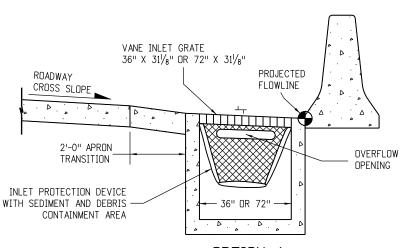

## OPTION A STORM DRAIN INLET PROTECTION (TYPE III)

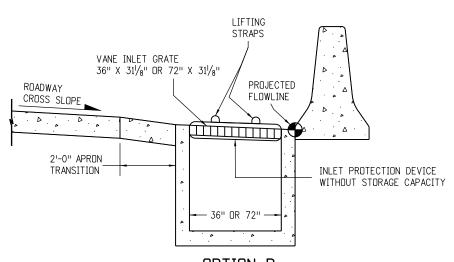

### OPTION B STORM DRAIN INLET PROTECTION (TYPE III)

NOTE: THE PAY ITEM NUMBER FOR STORM DRAIN INLET PROTECTION (TYPE III) (EACH) IS 208-00056.

### STORM DRAIN INLET PROTECTION TYPES

Computer File Information

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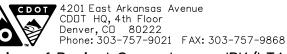
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Drawing File Name: 2080105011.dgn

CAD Ver.: MicroStation V8 Scale: Not to Scale Units: English

Colorado Department of Transportation




Division of Project Support JBK/LTA

TEMPORARY EROSION CONTROL STANDARD PLAN NO.

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- 3. EROSION LOGS SHALL BE TIGHTLY ABUTTED WITH NO GAPS.
- 4. V-SHAPED TEMPORARY DITCHES SHALL NOT BE USED. DITCHES SHAL BE GRADED IN A PARABOLIC OR TRAPEZOIDAL SHAPE.

### **EROSION LOG INSTALLATION**

- 4. FOR SLOPE AND CHANNEL SPACING SEE THE "SECTION VIEW ALONG DITCH FLOWLINE" DETAIL ON SHEET 11 OF 11.
- 5. SOIL RETENTION BLANKET SHALL ALWAYS BE REQUIRED.
- 6. THE PAY ITEM NUMBER FOR SILT BERM (LF) IS 208-00004.
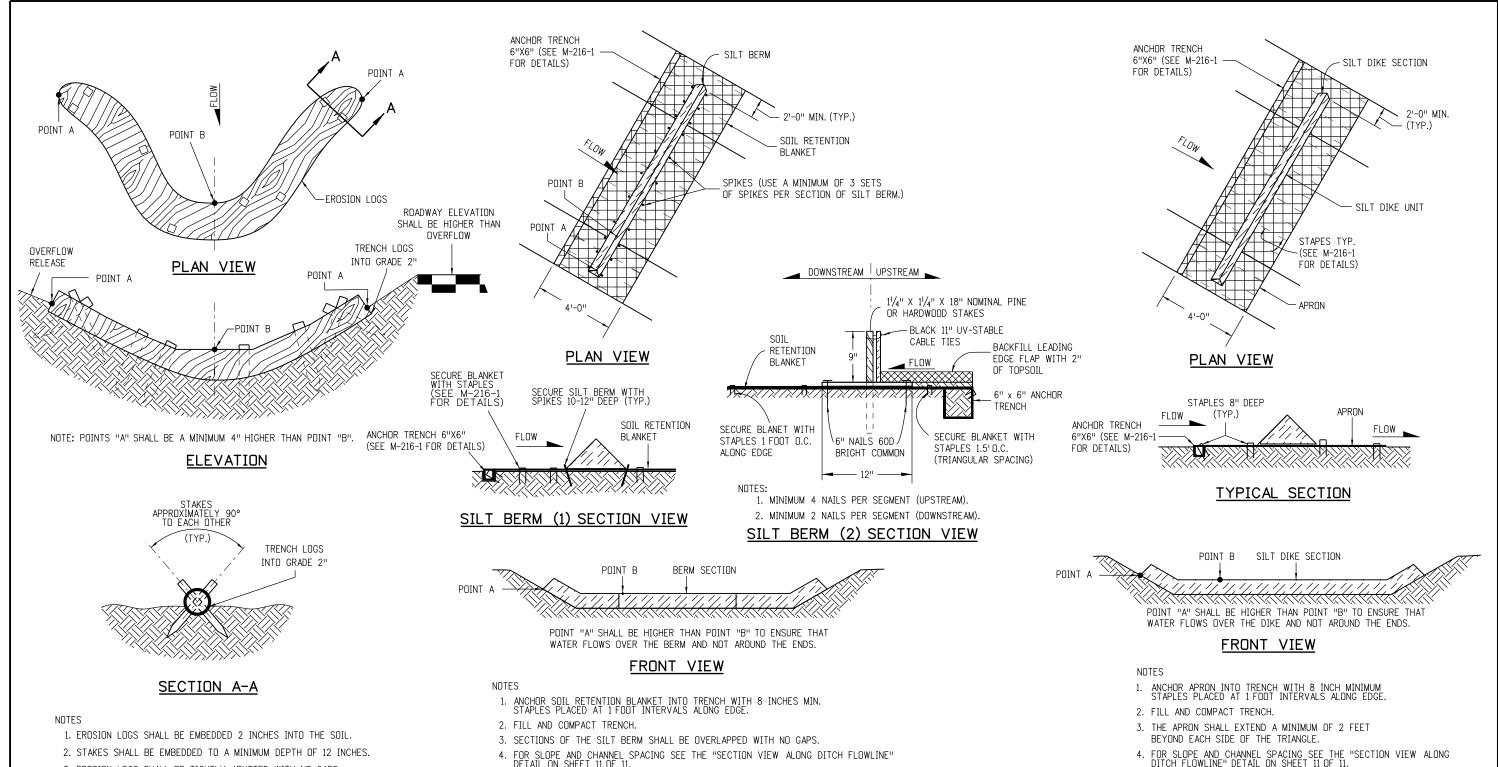
### SILT BERM INSTALLATION

### DRAINAGE DITCH APPLICATIONS

Computer File Infori	mation			Sheet Revisions	$\rfloor$
Creation Date: 07/04/12	Initials: JBK		Date:	Comments	
Last Modification Date: 03/29/16	Initials: LTA	$\mathbb{R}$ -X			
Full Path: www.coloradodot.info/busine	ss/designsupport	$\overline{\mathbb{R}-X}$			Ι,
Drawing File Name: 2080106011.dgn		$\overline{R-X}$			]:
CAD Ver.: MicroStation V8 Scale: Not to Sc	ale Units: English	(R-X)			٦٢

### Colorado Department of Transportation



# **EROSION CONTROL**


**TEMPORARY** 

STANDARD PLAN NO. M-208-1Sheet No. 6 of 11

5. THE PAY ITEM NUMBER FOR SILT DIKE (LF) IS 208-00001.

SILT DIKE INSTALLATION


Issued By: Project Development Branch on July 4, 2012

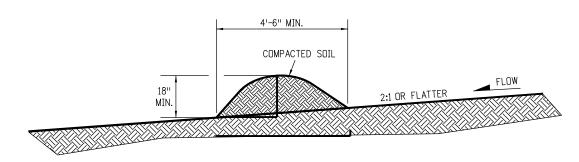

### NULE C.

- 1. BERMS SHALL HAVE A HEIGHT OF 18 INCHES, SIDE SLOPES OF 2:1 OR FLATTER AND A MINIMUM BASE WIDTH OF 4'-6" FEET.
- 2. BERMS SHALL BE USED TO INTERCEPT AND DIVERT DRAINAGE TO A DESIGNATED OUTLET.
- 3. BERMS SHALL NOT BE USED WHERE DRAINAGE AREA EXCEEDS 10 ACRES.
- 4. BERMS SHALL BE CONSTRUCTED OUT OF MATERIAL COMPACTED WITH AT LEAST A MINIMUM OF ONE WHEEL ROLLED COMPACTION.
- 5. THE PAY ITEM NUMBER FOR TEMPORARY BERM (LF) IS 208-00300.
- 6. BERMS SHALL BE CONSTRUCTED OUT OF ACCEPTABLE MATERIAL THAT CAN BE COMPACTED AND RECEIVE AT A MINIMUM HEAVY EQUIPMENT WHEEL ROLLED COMPACTION.

### TEMPORARY BERM

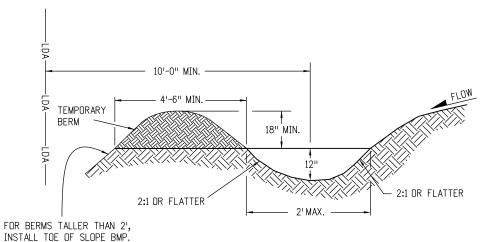

### NOTES

SEE SHEET 3 OF 11 FOR DETAILS.

- 1. TEMPORARY DIVERSION DITCHES SHALL BE CONSTRUCTED ACROSS THE SLOPE TO INTERCEPT RUNOFF AND DIRECT IT TO A STABLE OUTLET OR SEDIMENT TRAP.
- 2. USE THE TEMPORARY DIVERSION DITCH IMMEDIATELY ABOVE A NEW CUT, FILL SLOPE, OR AROUND THE PERIMETER OF A DISTURBED AREA.
- 3. THE GRADIENT ALONG THE FLOW PATH SHALL HAVE A POSITIVE GRADE TO ASSURE DRAINAGE, BUT SHALL NOT BE SO STEEP AS TO RESULT IN EROSION DUE TO HIGH VELOCITY.
- 4. THE DIVERSION FLOWLINE SHALL ALWAYS BE LOCATED A MINIMUM 10 FEET FROM THE OUTSIDE LIMITS OF DISTURBED AREA BOUNDARY.
- 5. THE PAY ITEM NUMBER FOR TEMPORARY DIVERSION (LF) IS 208-00301.


### TEMPORARY DIVERSION

# \*RIPRAP OUTLET PROTECTION (SEE M-601-12 FOR MIN. HORIZONTAL LAYOUT AND THICKNESS, AND SPECIFICATION 506 "RIPRAP" FOR REQUIREMENTS) \*RIPRAP SIZE D<sub>50</sub> = 6 IN. OR AS SHOWN ON THE PLANS. GEOTEXTILE EROSION CONTROL (CLASS 2) SHALL ALWAYS BE REQUIRED

### NOTE:

- 1. ANCHOR SIZE VARIES ACCORDING TO PIPE SIZE
- 2. TO SECURE THE PIPE, DRIVE STAKES INTO GROUND, THEN TIE A 12 GUAGE WIRE BETWEEN THEM ABOVE AND ACROSS THE PIPE'S WIDTH.
- 3. THE OUTLET SHALL BE ALIGNED WITH THE FLOW DIRECTION OF THE EXISTING GRADE. PERPENDICULAR DISCHARGE TO A CHANNEL SHALL NOT BE ACCEPTABLE.
- 4. THE GRADE AROUND THE INLET TO THE PIPE SHALL BE COMPACTED.
- 5. THE PAY ITEM NUMBER FOR TEMPORARY SLOPE DRAINS (LF) IS 208-00060.

### TEMPORARY SLOPE DRAINS

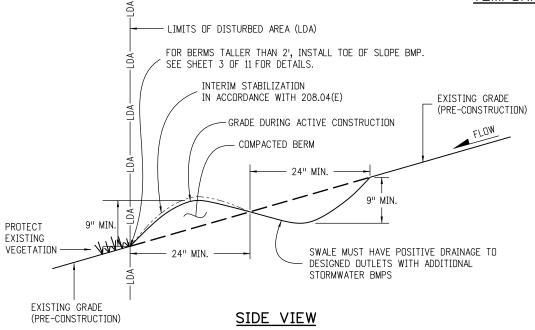

### NOTES:

- 1. BERMS CAN ONLY BE USED IF CONDITIONS ALLOW UNINTERRUPTED POSITIVE GRADE (MAXIMUM GRADIENT 3%) TO AN OUTLET PROTECTED WITH ADDITIONAL BMPS.
- 2. MAXIMUM DRAINAGE AREA FOR EACH OUTLET FROM THE SWALE SHALL BE LIMITED TO 2 ACRES.
- 3. CONTRACTOR SHALL SALVAGE TOPSOIL AND PLACE AFTER BERM IS REMOVED FOR FINAL SEEDING OF ALL DISTURBED AREAS.
- 4. ALL ACTIVITIES REQUIRED TO ACCOMPLISH TEMPORARY BERM (EXCLUDING SURFACE MULCHING) SHALL BE INCLUDED IN THE COST OF WORK AND WILL NOT BE PAID FOR SEPARATELY.
- BERMS SHALL BE CONSTRUCTED OUT OF ACCEPTABLE MATERIAL THAT CAN BE COMPACTED AND RECEIVE AT A MINIMUM HEAVY EQUIPMENT WHEEL ROLLED COMPACTION.
- 6. THE PAY ITEM NUMBER FOR TEMPORARY BERM (LF) IS 208-00300.

### TEMPORARY BERM (AT EDGE OF DISTURBANCE)

### **GRADING APPLICATIONS**

Computer File Information				Sheet Revisions
Creation Date: 07/04/12	Initials: JBK		Date:	Comments
Last Modification Date: 03/29/16	Initials: LTA	$\overline{\mathbb{R}-X}$	03/29/16	Revisions to some dimensions and No
Full Path: www.coloradodot.info/business	s/designsupport	$\overline{R-X}$		
Drawing File Name: 2080107011.dgn		$\overline{R-X}$		
CAD Ver.: MicroStation V8 Scale: Not to Sca	le Units: English	(R-X)		

### Colorado Department of Transportation

4201 East Arkansas Avenue CDDT HQ, 4th Floor Denver, CD 80222 Phone: 303-757-9021 FAX: 303-757-9868


Division of Project Support JBK/LTA Issued By: Project Development Branch on July 4, 2012

### TEMPORARY EROSION CONTROL


STANDARD PLAN NO.

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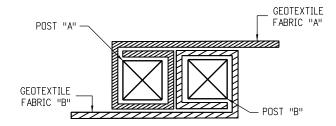


- 1. GEOTEXTILE SHALL BE ATTACHED TO WOOD POSTS WITH THREE OR MORE STAPLES PER POST. STAPLES SHALL BE HEAVY DUTY WIRE AND AT LEAST 1" INCH LONG
- 2. WOOD POST SHALL BE  $1\frac{1}{2}$ " X  $1\frac{1}{2}$ " NOMINAL.
- 3. THE PAY ITEM NUMBER FOR SILT FENCE (LF) IS 208-00020.
- 4. THE SILT FENCE SHALL BE PLACED ON THE CONTOUR (AT THE SAME ELEVATION ±6"). THE ENDS SHALL BE FLARED UP SLOPE (MINIMUM ELEVATION GAIN OF 18").

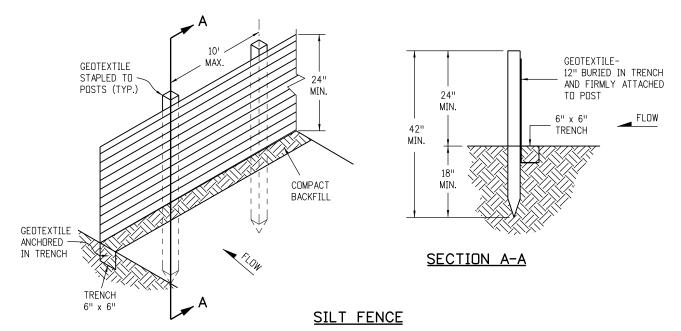


### END SECTION DETAIL (PLAN VIEW)

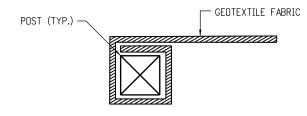1. THE END OF THE SILT FENCE FABRIC SHALL BE WRAPPED APPROX. 6 INCHES AROUND A WOODEN POST ONE FULL TURN, THEN SECURED ALONG THE POST WITH 6 HEAVY DUTY WIRE STAPLES AT LEAST 1 INCH LONG.




### JOINING SECTION DETAIL (PLAN VIEW)

- 1. THE ENDS OF THE SILT FENCE FABRIC SHALL BE JOINED TOGETHER BY WRAPPING APPROX. 6 INCHES OF EACH END AROUND A WOODEN POST ONE FULL TURN, THEN SECURED ALONG THE POST WITH 6 HEAVY DUTY WIRE STAPLES AT LEAST 1 INCH LONG.
- 2. POSTS SHALL BE TIGHTLY ABUTTED WITH NO GAPS TO PREVENT POTENTIAL FLOW-THROUGH OF SEDIMENT AT JOINT.

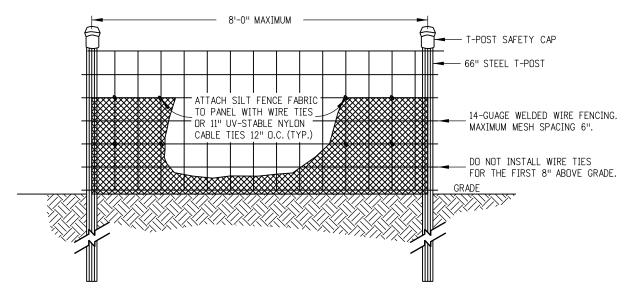

### **ELEVATION VIEW**

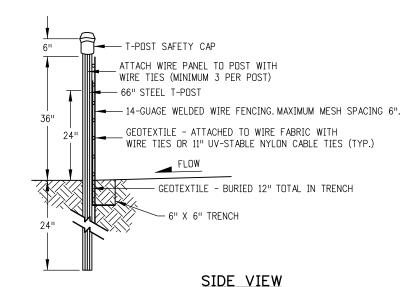

NOTES

- 1. THE ENDS OF THE SILT FENCE FABRIC SHALL BE JOINED TOGETHER BY WRAPPING APPROX.6 INCHES OF EACH END AROUND A WOODEN POST ONE FULL TURN, THEN SECURED ALONG THE POST WITH 6 HEAVY DUTY WIRE STAPLES AT LEAST 1 INCH LONG.
- 2. SILT FENCES SHALL NOT BE USED FOR CHECK DAMS.
- 3. THE PAY ITEM NUMBER FOR SILT FENCE (REINFORCED) (LF) IS 208-00021.


### SILT FENCE (REINFORCED)

### SILT FENCE APPLICATIONS

Computer File Inform	ation
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Last Modification Date: 03/29/16	Initials: LTA
Full Path: www.coloradodot.info/busines	designsupport/
Drawing File Name: 2080108011.dgn	
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	Sheet Revisions				
	Date:	Comments			
$\mathbb{R}$ -X	03/29/16	Minor revisions to some dimensions and Notes.			
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Division of	Project	Support
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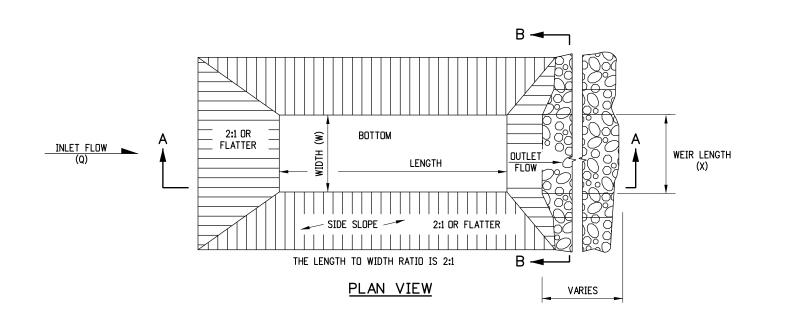
**TEMPORARY EROSION CONTROL** 

STANDARD PLAN NO.

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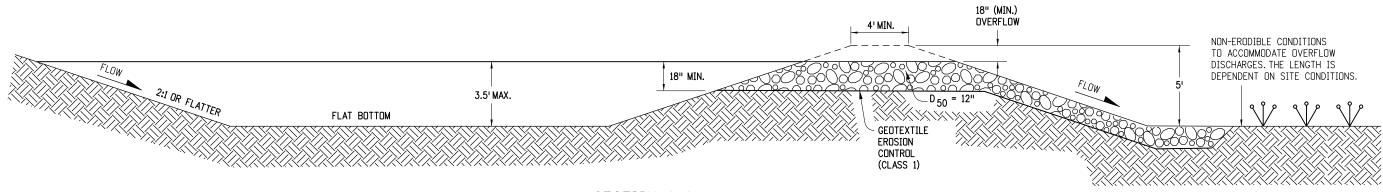
Issued By: Project Development Branch on July 4, 2012
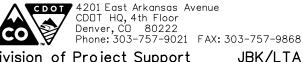
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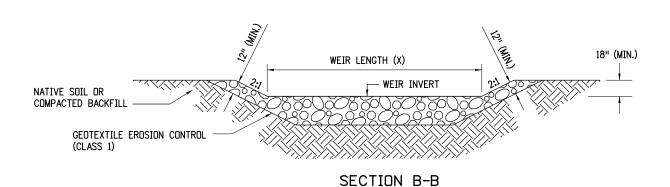


### NOTES

- 1. THE MAXIMUM DRAINAGE AREA IS 5 ACRES.
- 2. THE MAXIMUM STRUCTURE LIFE IS 2 YEARS.
- 3. THE STORAGE AREA IS 1800 CUBIC FEET PER ACRE.
- 4. THE MAXIMUM EMBANKMENT HEIGHT SHALL BE 5 FT. MEASURED ON THE DOWNSTREAM SIDE.
- 5. THE LENGTH/WIDTH RATIO MAY BE ADJUSTED TO MEET SITE CONDITIONS WHEN APPROVED BY THE ENGINEER.
- 6. WIDTH (W) OF SEDIMENT TRAP IS APPROXIMATELY EQUAL TO THE WEIR LENGTH (X).
- 7. SEDIMENT TRAP DESIGN SHALL BE APPROVED BY THE ENGINEER.
- 8. THE DOWN GRADE FROM WEIR SHALL BE STABLE AND NON-ERODIABLE.
- 9. THE PAY ITEM NUMBER FOR SEDIMENT TRAP (LF) IS 208-00033.



### SECTION A-A



DRAINAGE AREA (ACRES)	WEIR LENGTH (FEET)
1	4
2	6
3	8
4	10
5	12

WEIR LENGTH TABLE

### SEDIMENT TRAP

Computer File Inform	tion	
Creation Date: 07/04/12	nitials: JBK	
Last Modification Date: 03/29/16	nitials: LTA	
Full Path: www.coloradodot.info/business/designsupport		
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	Sheet Revisions		
	Date:	Comments	
(R-X)	03/29/16	Minor revisions to some dimensions.	
(R-X)			
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### Colorado Department of Transportation




TEMPC	)RARY
<b>EROSION</b>	CONTROL

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# STEP 1. EXCAVATE THE TRENCH. STEP 1. EXCAVATE THE TRENCH. STEP 1. EXCAVATE THE TRENCH. WOOD STAKE (TYP.) WEDD FREE STRAW BETWEEN EROSION BALES TWINE OR WIRE WOOD STAKE (TYP.)




SECTION A-A


EROSION BALE TRENCHING AND STAKING
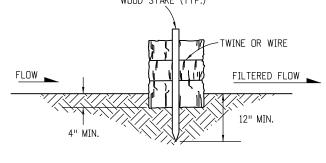
### <u>NOTES</u>

- 1. STAKES SHALL BE WOOD AND SHALL BE 2" X 2" X 30" NOMINAL.
- 2. EROSION BALES SHALL BE 18" X 18" X 36".
- 3. EROSION BALES SHALL BE ENTRENCHED 4 IN MINIMUM INTO THE SOIL, THIGHTLY ABUTTED WITH NO GAPS, STAKED, AND BACKFILLED AROUND THE ENTIRE OUTSIDE PERIMETER.
- 4. EROSION BALES CANNOT BE USED FOR CHECK DAMS.
- 5. THE PAY ITEM NUMBER FOR EROSION BALES (WEED FREE) (EA) IS 208-00011.

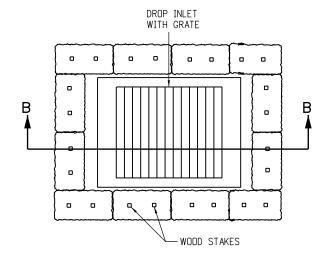

PLAN VIEW

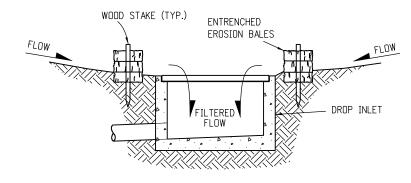

SECTION B-B
EROSION BALE FILTER AT DROP INLET

### EROSION BALE APPLICATIONS

Computer File Inform	nation		
Creation Date: 07/04/12	Initials:	JBK	
Last Modification Date: 03/29/16	Initials:	LTA	
Full Path: www.coloradodot.info/busines	s/design:	support	
Drawing File Name: 20801010011.dgn			
CAD Ver.: MicroStation V8 Scale: Not to Sca	le Units:	English	

EROSION BALES

FLOW

TOE OF FILL-

00 00 00 00

PLAN VIEW

EROSION BALE CULVERT INLET PROTECTION

		Sheet Revisions		
		Date:	Comments	
	R-X	03/29/16	Minor revisions to some dimensions.	
t	R-X			
	R-X			
	R-X			

END EROSION BALES TO BE KEYED INTO FILL SLOPE

-PIPE END SECTION

WOOD STAKE (TYP.)

Colorado Department of Transportation




TEMPORARY
EROSION CONTROL

STANDARD PLAN NO.
M-208-1


Issued By: Project Development Branch on July 4, 2012

Sheet No. 10 of 11

GEOTEXTILE EROSION CONTROL (CLASS 2)
TO EXTEND UP % OF RIPRAP HEIGHT WITH
6" MIN. COVER OVER GEOTEXTILE (TYP).

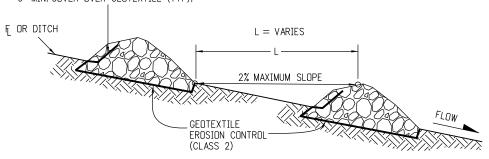


### SECTION VIEW ALONG DITCH FLOWLINE

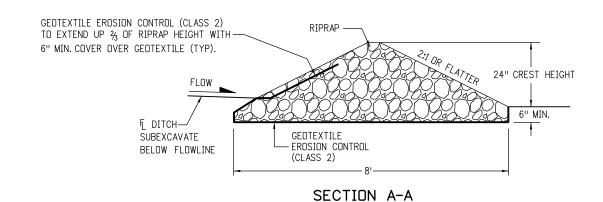

### NOTES:

- 1. RIPRAP SIZE  $D_{50} = 6$ " OR AS SHOWN ON THE PLANS.
- 2. THE GEOTEXTILE EROSION CONTROL SHALL BE CLASS 2 AND CONFORM TO THE REQUIREMENTS OF SUBSECTION 712.08.
- 3. THE ENDS OF RIPRAP CHECK DAM SHALL BE A MINIMUM OF 6 IN. HIGHER THAN CENTER OF CHECK DAM.
- 4. FOR USE AS TEMPORARY CHECK DAMS ONLY AND NOT FOR PERMANENT INSTALLATIONS.
- 5. THE PAY ITEM NUMBER FOR ROCK CHECK DAM (EA) IS 208-00041.

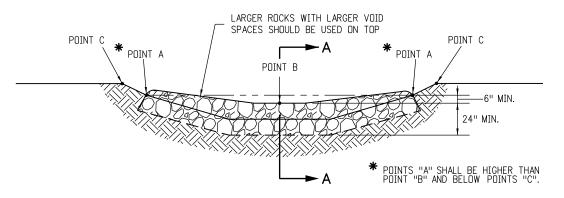

TYPICAL SECTION VIEW

### ROCK CHECK DAM

Computer File Inform	ation	
Creation Date: 07/04/12	Initials: JBK	
Last Modification Date: 03/29/16	Initials: LTA	] (
Full Path: www.coloradodot.info/business	/designsupport	] (
Drawing File Name: 20801011011.dgn		] (
CAD Ver.: MicroStation V8 Scale: Not to Scale	e Units: English	
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	Sheet Revisions		
	Date: Comments		
R-X)	03/29/16	Minor revisions to some Notes.	
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TEMPO	ORARY
<b>EROSION</b>	CONTROL

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STANDARD PLAN NO.

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