Cover Sheet

G1

# SRDA BALCONY ENCLOSURE

# 230 N. UNION AVE. PUEBLO, COLORADO 81003



REQ'a

RVT

SCHED

SECT

STL

TER

T#G

TOM

TO

TOP

UNO

**VEST** 

MSCT

STOR

STRUCT

LCA

ALUM

BLOCK

BLOCKING

BY OWNER

CEILING

CLOSET

COLUMN

CONCRETE

CONNECTION

CONTINUOUS

COVE BASE

CERAMIC TILE

CARPET

DIAMETER

DIMENSION

DRAWER

DRAWING

(E) or EXIST EXISTING

DOWNSPOUT

ELECTRICAL

**ELEVATION** 

EMERGENCY

ENCLOSURE

**EPOXY PAINT** 

**EPOXY** 

EQUAL

EQUIPMENT

EXISTING

**EXTERIOR** 

**EXPANSION** 

FIRE ALARM

FLOOR DRAIN

FIRE EXTINGUISHER

FACTORY FINISH

FLOAT GLAZE

FLUORESCENT

FACE OF BLOCK

FACE OF FINISH

FACE OF STUDS

FOOT OR FEET

FINISHED FLOOR

FACE OF CONCRETE

FIBERGLASS REINFORCED

FINISH

FLOOR

PLASTIC

FOOTING

**ELEVATION** 

GALVANIZED

CONTRACTOR

GYPSUM BOARD

GYPSUM BOARD

HOLLOW CORE

HOLLOW METAL

INSIDE DIAMETER

INSULATED GLAZE

FURRING

GAUGE

GENERAL

GLASS

GRADE

HOSE BIB

HARDWOOD

HARDWARE

HORIZONTAL

INSULATION

HEIGHT

FOUNDATION

EXPANSION JOINT

DOWN

DWR

DS

DWG

ELEC

ELEV

EMER

ENCL

EQPT

EXIST

FLUOR

FOB

FOC

FOF

FOS

FRP

FURR

GALV

GRD

HDMD

HDWR

HORIZ

INSUL

GYP BD

FFE

CONCRETE MASONRY UNIT

MANUFACTURER MISCELLANEOUS MASONRY OPENING MOUNTED NOT IN CONTRACT NOT TO SCALE OVERALL ON CENTER

OPENING **OPPOSITE** PORCELAIN TILE PLASTIC LAMINATE PLYWOOD PAINT POINT RECEPTACLE RADIUS RUBBER BASE ROOF DRAIN REFERENCE

OUTSIDE DIAMETER

REINFORCED REQUIRED ROOM ROUGH OPENING RESILIENT VINYL TILE SUSPENDED ACOUSTICAL GRID SEALED CONCRETE SOLID CORE SCHEDULE SECTION STORE FRONT

SHEET SHEET METAL SIMILAR SOLID SURFACE SPECIFICATION SQUARE STAINLESS STEEL STANDARD STEEL STORAGE STRUCTURAL SUSPENDED SHEET VINYL SYMMETRICAL TELEPHONE TERRAZZO TONGUE AND **GROOVE** 

THICK **TELEVISION** TOP OF WALL TYPICAL TOP OF TOP OF PARAPET UNLESS NOTED OTHERWISE URINAL VINYL COMPOSITE TILE VERTICAL VESTIBULE VERIFY IN FIELD PLUMBING VENT THRU ROOF MITH WATER CLOSET MOOD

MITHOUT

MAINSCOT

WEIGHT

**WATERPROOF** 

WATER RESISTANT

WATER RESISTANT

GYPSUM BOARD

PETAIL NO. X DETAIL SCALE SHEET

**General Notes** ALL WORK CALLED FOR IN THESE PLANS SHALL BE EXECUTED WITH EXTREME CONCERN FOR CRAFTSMANSHIP AND SAFETY IN FULL ACCORDANCE WITH THE ADOPTED CODES AND ORDINANCES OF THE


OWNER / GENERAL CONTRACTOR SHALL ASSUME ALL RESPONSIBILITY

COMMENCING WITH WORK, THE SUBCONTRACTOR TO BE RESPONSIBLE FOR REVIEWING RELATED TRADES SUBSURFACE PREPARATION AND SHALL REPORT ANY NON- CONFORMING DISCREPANCY TO THE GENERAL CONTRACTOR. EXECUTION OF WORK BY ANY SUBCONTRACTOR INDICATES ACCEPTANCE OF PREVIOUS TRADES WORK.

THE OWNER AGREES TO HOLD HARMLESS, INDEMNIFY AND DEFEND THE ARCHITECT, HIS EMPLOYEES AND CONSULTANTS AGAINST ANY AND ALL LIABILITY, CLAIMS, DAMAGES AND COST OF DEFENSE ARISING OUT OF THE ERRORS AND OMISSIONS, OR NEGLIGENT ACTS CAUSED BY THE UNAUTHORIZED MODIFICATIONS TO THESE PLANS.

ANY CHANGE (S), MODIFICATION (S), OR ALTERATION (S) TO THESE PLANS SHALL BE AT THE SOLE RISK OF PERSON (S) MAKING OR CAUSING THE THE ARCHITECT AND ARCHITECT'S CONSULTANTS SHALL HAVE NO

RESPONSIBILITY FOR THE DISCOVERY, PRESENCE, HANDLING, REMOVAL AND DISPOSAL OF OR EXPOSURE OF PERSONS TO HAZARDOUS MATERIALS IN ANY FORM AT THE PROJECT SITE, INCLUDING BUT NOT LIMITED TO ASBESTOS, ASBESTOS PRODUCTS, POLYCHLORINATED BIPHENYL (PCB) OR OTHER TOXIC SUBSTANCES.

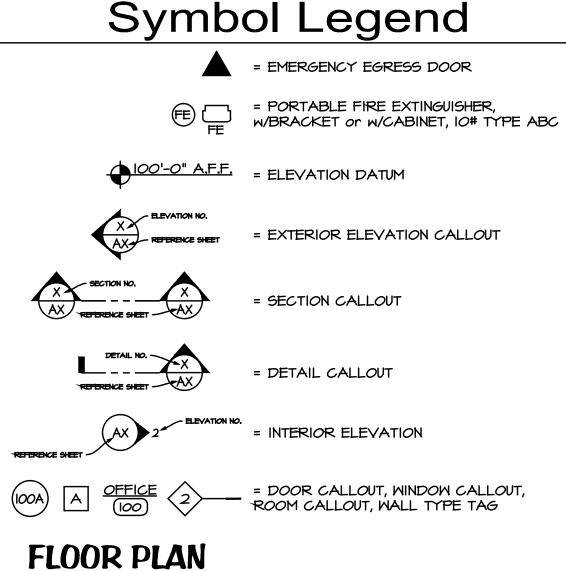

= SHEET TITLE

= DETAIL TITLE

Sheet Index GENERAL COVER SHEET

## ARCHITECTURAL

DEMOLITION FLOOR PLAN & ELEVATIONS FLOOR PLAN, REFLECTED CEILING PLAN, ROOM FINISH SCHEDULE, DOOR & WINDOW ELEVATIONS & SCHEDULES ELEVATIONS

BUILDING CROSS SECTION & DETAILS

### MECHANICAL/PLUMBING

DRAWING INDEX, GENERAL NOTES, LEGENDS, AND DIAGRAMS FLOOR PLAN - HVAC

## TRICAL

ELECTRICAL DEMOLITION PLAN, AND SINGLE LINE DIAGRAM

LIGHTING PLAN, CONTROL DETAIL, LIGHTING LEGEND AND FIXTURE SCHEDULE

POWER/IT ROUGH-IN PLANS AND POWER SYMBOL

▲ EXIT

BALCONY

SECOND FLOOR EXIT PLAN

NOT TO SCALE

# **Project Description**

ENCLOSED EXISTING BALCONY 1,088 S.F.

Owner: SRDA SENIOR CENTER PUEBLO, CO

Weidner & Associates, L.L.C. Steve Weidner, RA 830 North Main Street Sulte 140

719-696-8249 Steve@WeidnerAndAssociates.net

Mechanical Engineer: AE Associates, INC Roaer Lemmon, P.E. 308 West Fillmore Suite 200

APPROX.

PROPOSED ENCLOSED BALCONY

68'-0"

Colorado Springs, CO 80907 719-262-9430 roger.lemmon@aeassociates.net

# Vicinity Map

#### Consultants / Contacts <u> Electrical Engineer:</u>

Pueblo, CO 81003

Colorado Springs, CO 80906 1-719-633-2637 email@kohnertee.com

Kohnert Electrical Engineers

Mike Kohnert, PE

Suite 200

911 South 8th Street

**NORTH** 

#### ORIGINAL BUILDING CODE COMPLIANCE: 1988 UBC Building Occupancy (UBC Section 303.1 A-3 Construction Type (UBC Table 5-C) II - 1 Hour Allowable Area (UBC Table 5-C) 13,500 sf

Allowable Height (UBC Table 5-D) ctual Height and Area Height (Stories) 1st floor 2nd floor 3rd floor Fire Sprinklers

Occupant Load 2nd floor 3rd floor Required Exiting

Provided Exiting Required Exiting Width 1st floor

1st floor Existing Plumbing Fixtures

(2) 1st floor, (2) 2nd and 3rd floors 14.4" 43.2" Required Exiting Width Provided 72" 180" 2nd floor - Men - 3 WC, 2 UR, 2 LAV

3 - Sprinkled

21,800 sf 6,826

7,487

7,487

Yes

579 Occupants 238 Occ.

218 Occ.

123 Occ.

### CURRENT CODE COMPLIANCE: 2015 IBC

Building Occupancy (IBC Section 303.4) Construction Type (IBC Section 602.3) Type II-A 85 Feet Allowable Height (IBC Table 504.3) 3 Stories Allowable Stories (IBC Table 504.4) 46,500 sf per floor Allowable Area (IBC Table 506.2)

Actual Height and Area Height (Stories) Height (Feet) 52 feet +/-

7,487 sf footprint / 22,888 sf total (New Area) (1,088 sf at 2nd floor) Fire Sprinklers \*Existing building is fully sprinkled. **EXISITNG SYSTEM TO BE EXTENDED INTO** BALCONY ENCLOSURE as REQUIRED PER NFPA Occupancy Factor (IBC Table 1004.1.2) Assembly - T&C 15 net

42 Occupants 41.2 Occ. Additional Occupant Load 618 Useable sf / 15 113 Storage sf / 300 0.4 Occ. 621 Occupants 238 Occ. Total Occupant Load 2nd floor 260 Occ. 123 Occ. 3rd floor Required Exiting **Provided Exiting** 

Required Exiting Width (IBC Section 105.3) Required Exiting Width Provided 72"

180" Required Plumbing Fixtures for A-3 Occupancy (IBC Table 2902.1) Women - 1/65 LAV - 1/200 1st floor - 238 Occ. - Men - 1 WC, 1 LAV 2nd floor - 280 Occ - Men - 2 WC, 1 LAV Women - 3 WC, 1 LAV 3rd floor - 123 Occ - Men - 1 WC, 1 LAV

(2) 1st floor, (2) 2nd and 3rd floors DRAWN BY: 43.2"

DF - 1/500 Service Sink - 1 DF - 1 DF - 1 DF - 1 Women - 1 WC, 1 LAV

I. EXISTING GUARD RAILING TO REMAIN.

2. REMOVE EXISTING GUARD RAILING FOR NEW CONSTRUCTION.

3. REMOVE EXISTING GAS FIRED RADIANT HEATERS.

4. EXISTING GAS LINE TO REMAIN.

5. CAP BRANCH GAS LINE AT MAIN RUN..


6. EXISTING WALL LOUVER TO REMAIN.

7. EXISTING EXHAUST DUCT THRU ROOF TO REMAIN.

8. REMOVE EXISTING CEILING LIGHT FIXTURES.

9. CONNECT NEW GAS LINE TO EXISTING GAS LINE.

RE: MECHANICAL PLANS.

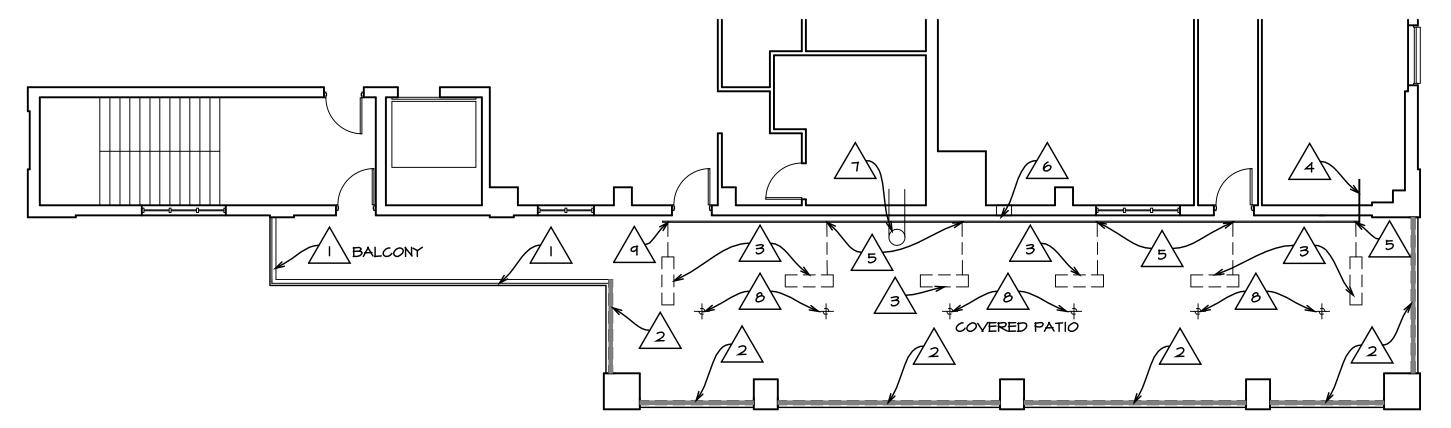





DEMOLITION SOUTH ELEVATION


|/8" = |' - O"




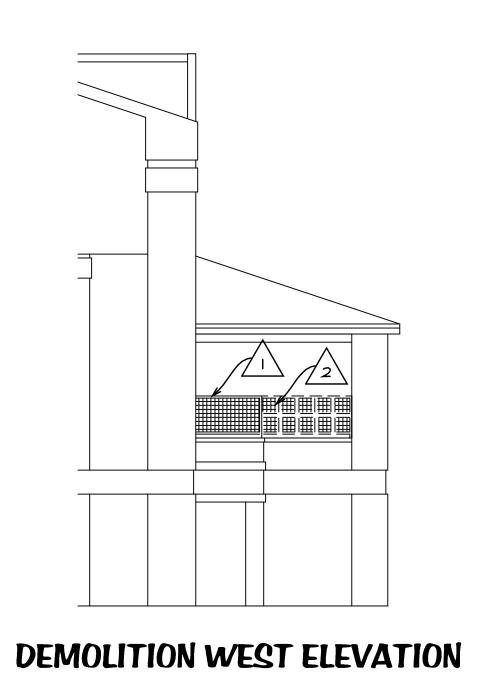

|/8" = |' - O"

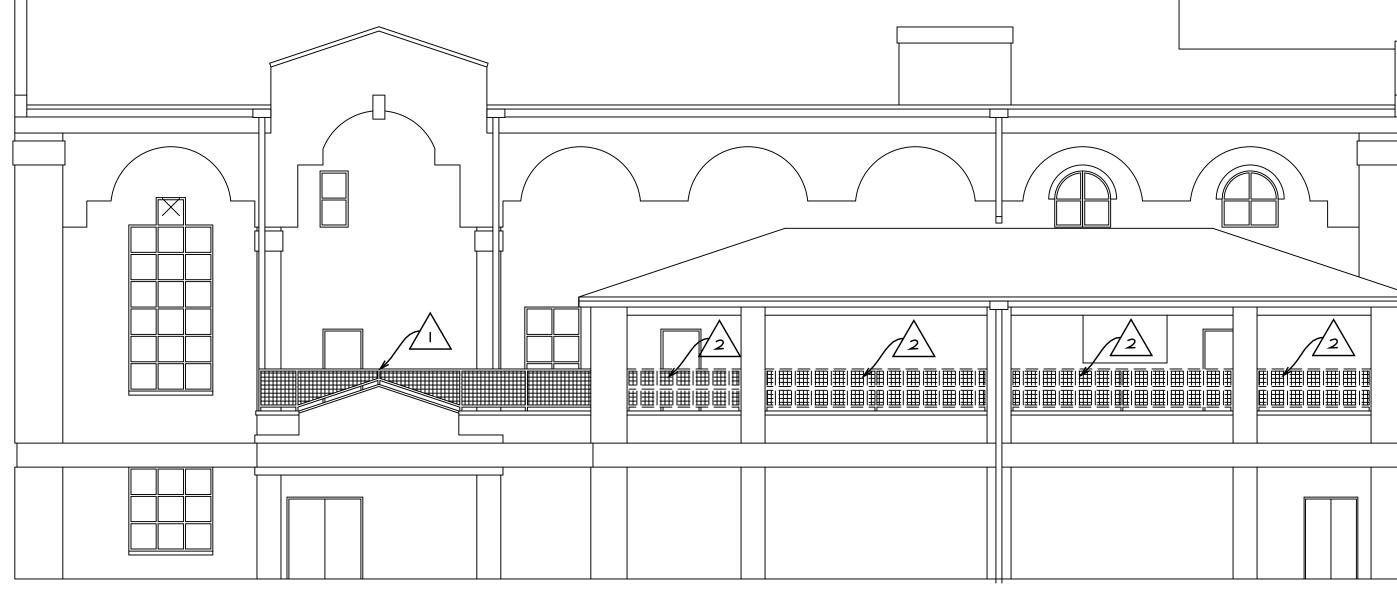

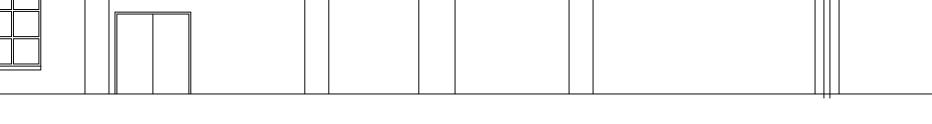

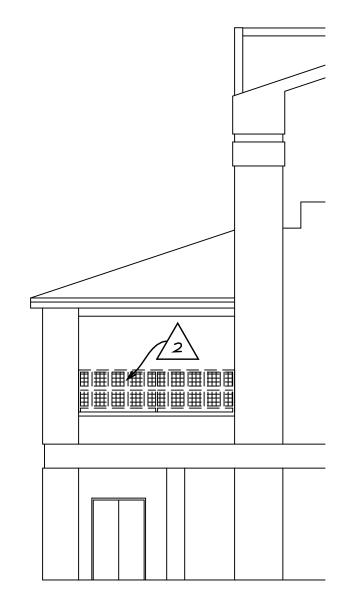

DEMOLITION EAST ELEVATION

|/8" = 1' - 0"

STAMP:

EN

SRDA BALCONY

CONSULTANTS:

ASSOCIATES, 1


WEIDNER &

ISSUE RECORD:
Construction Documents 10-10-17


230 N. Union Avenue Pueblo, CO 81003

PROJECT NUMBER: 2015-24
DRAWN BY: L. Ramos
REVIEWED BY: S. Weidner

**DEMOLITION** FLOOR PLAN AND **ELEVATIONS** 

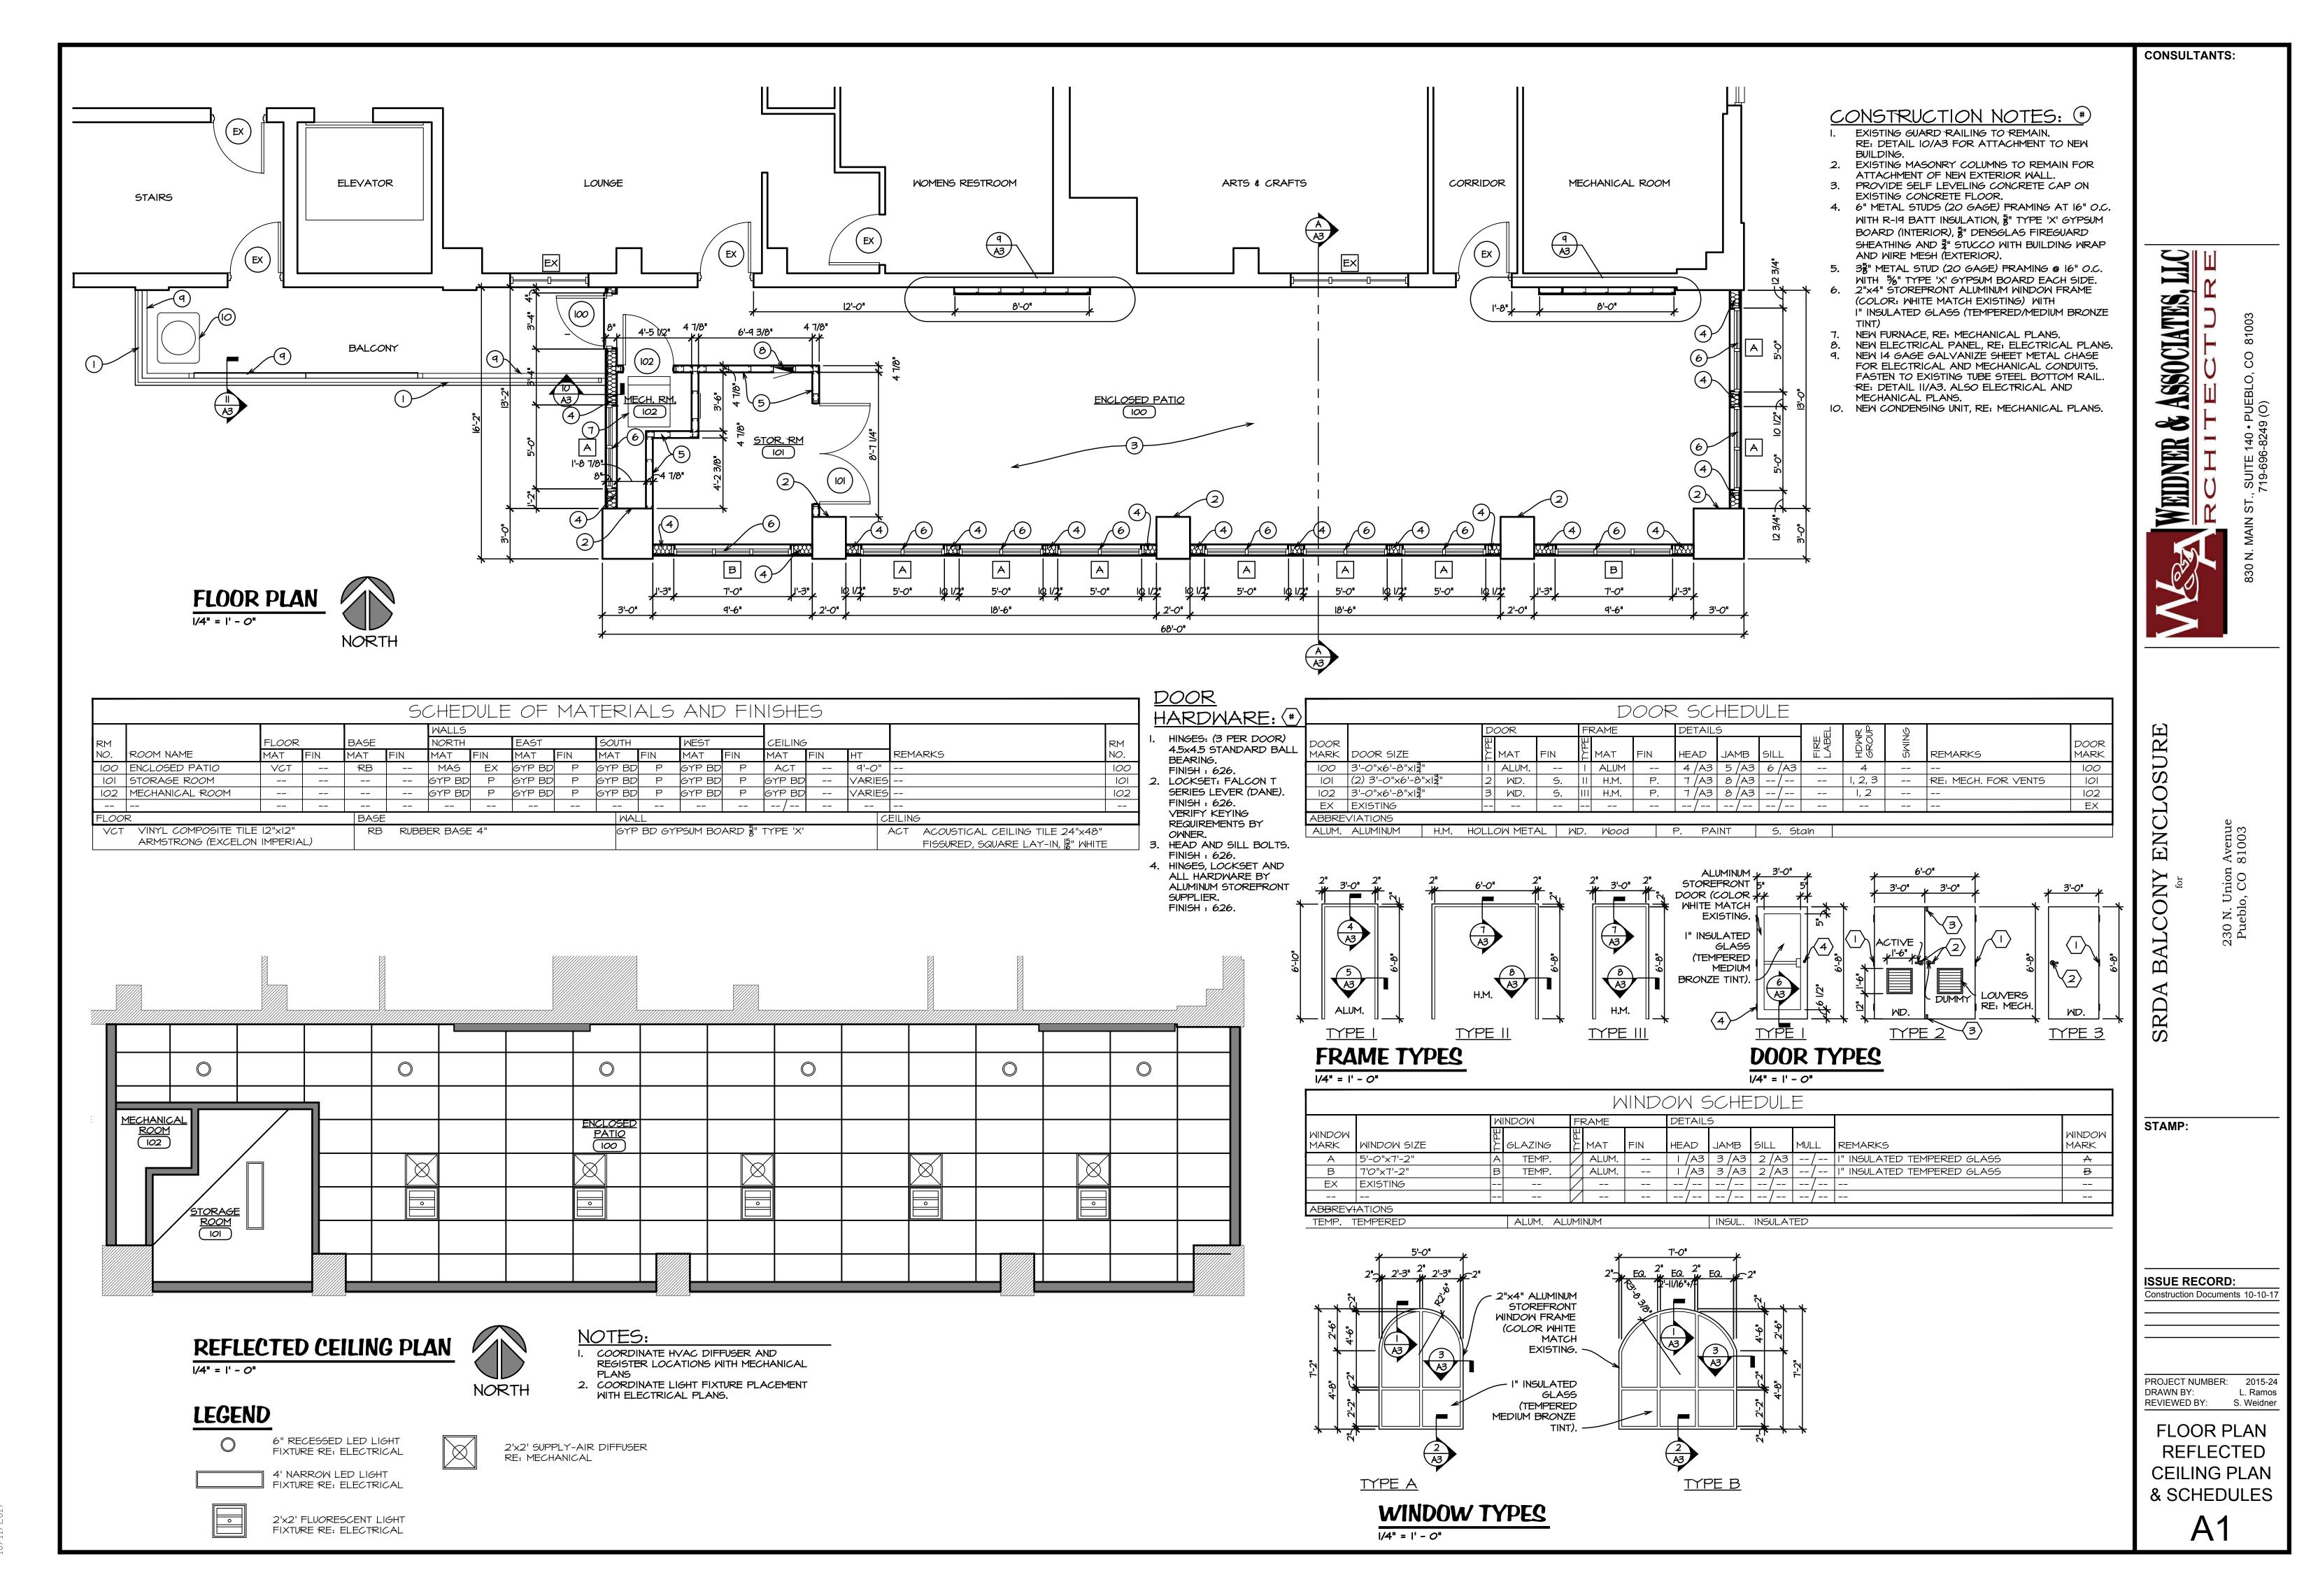

2015-24 FL-ELEV.dwg

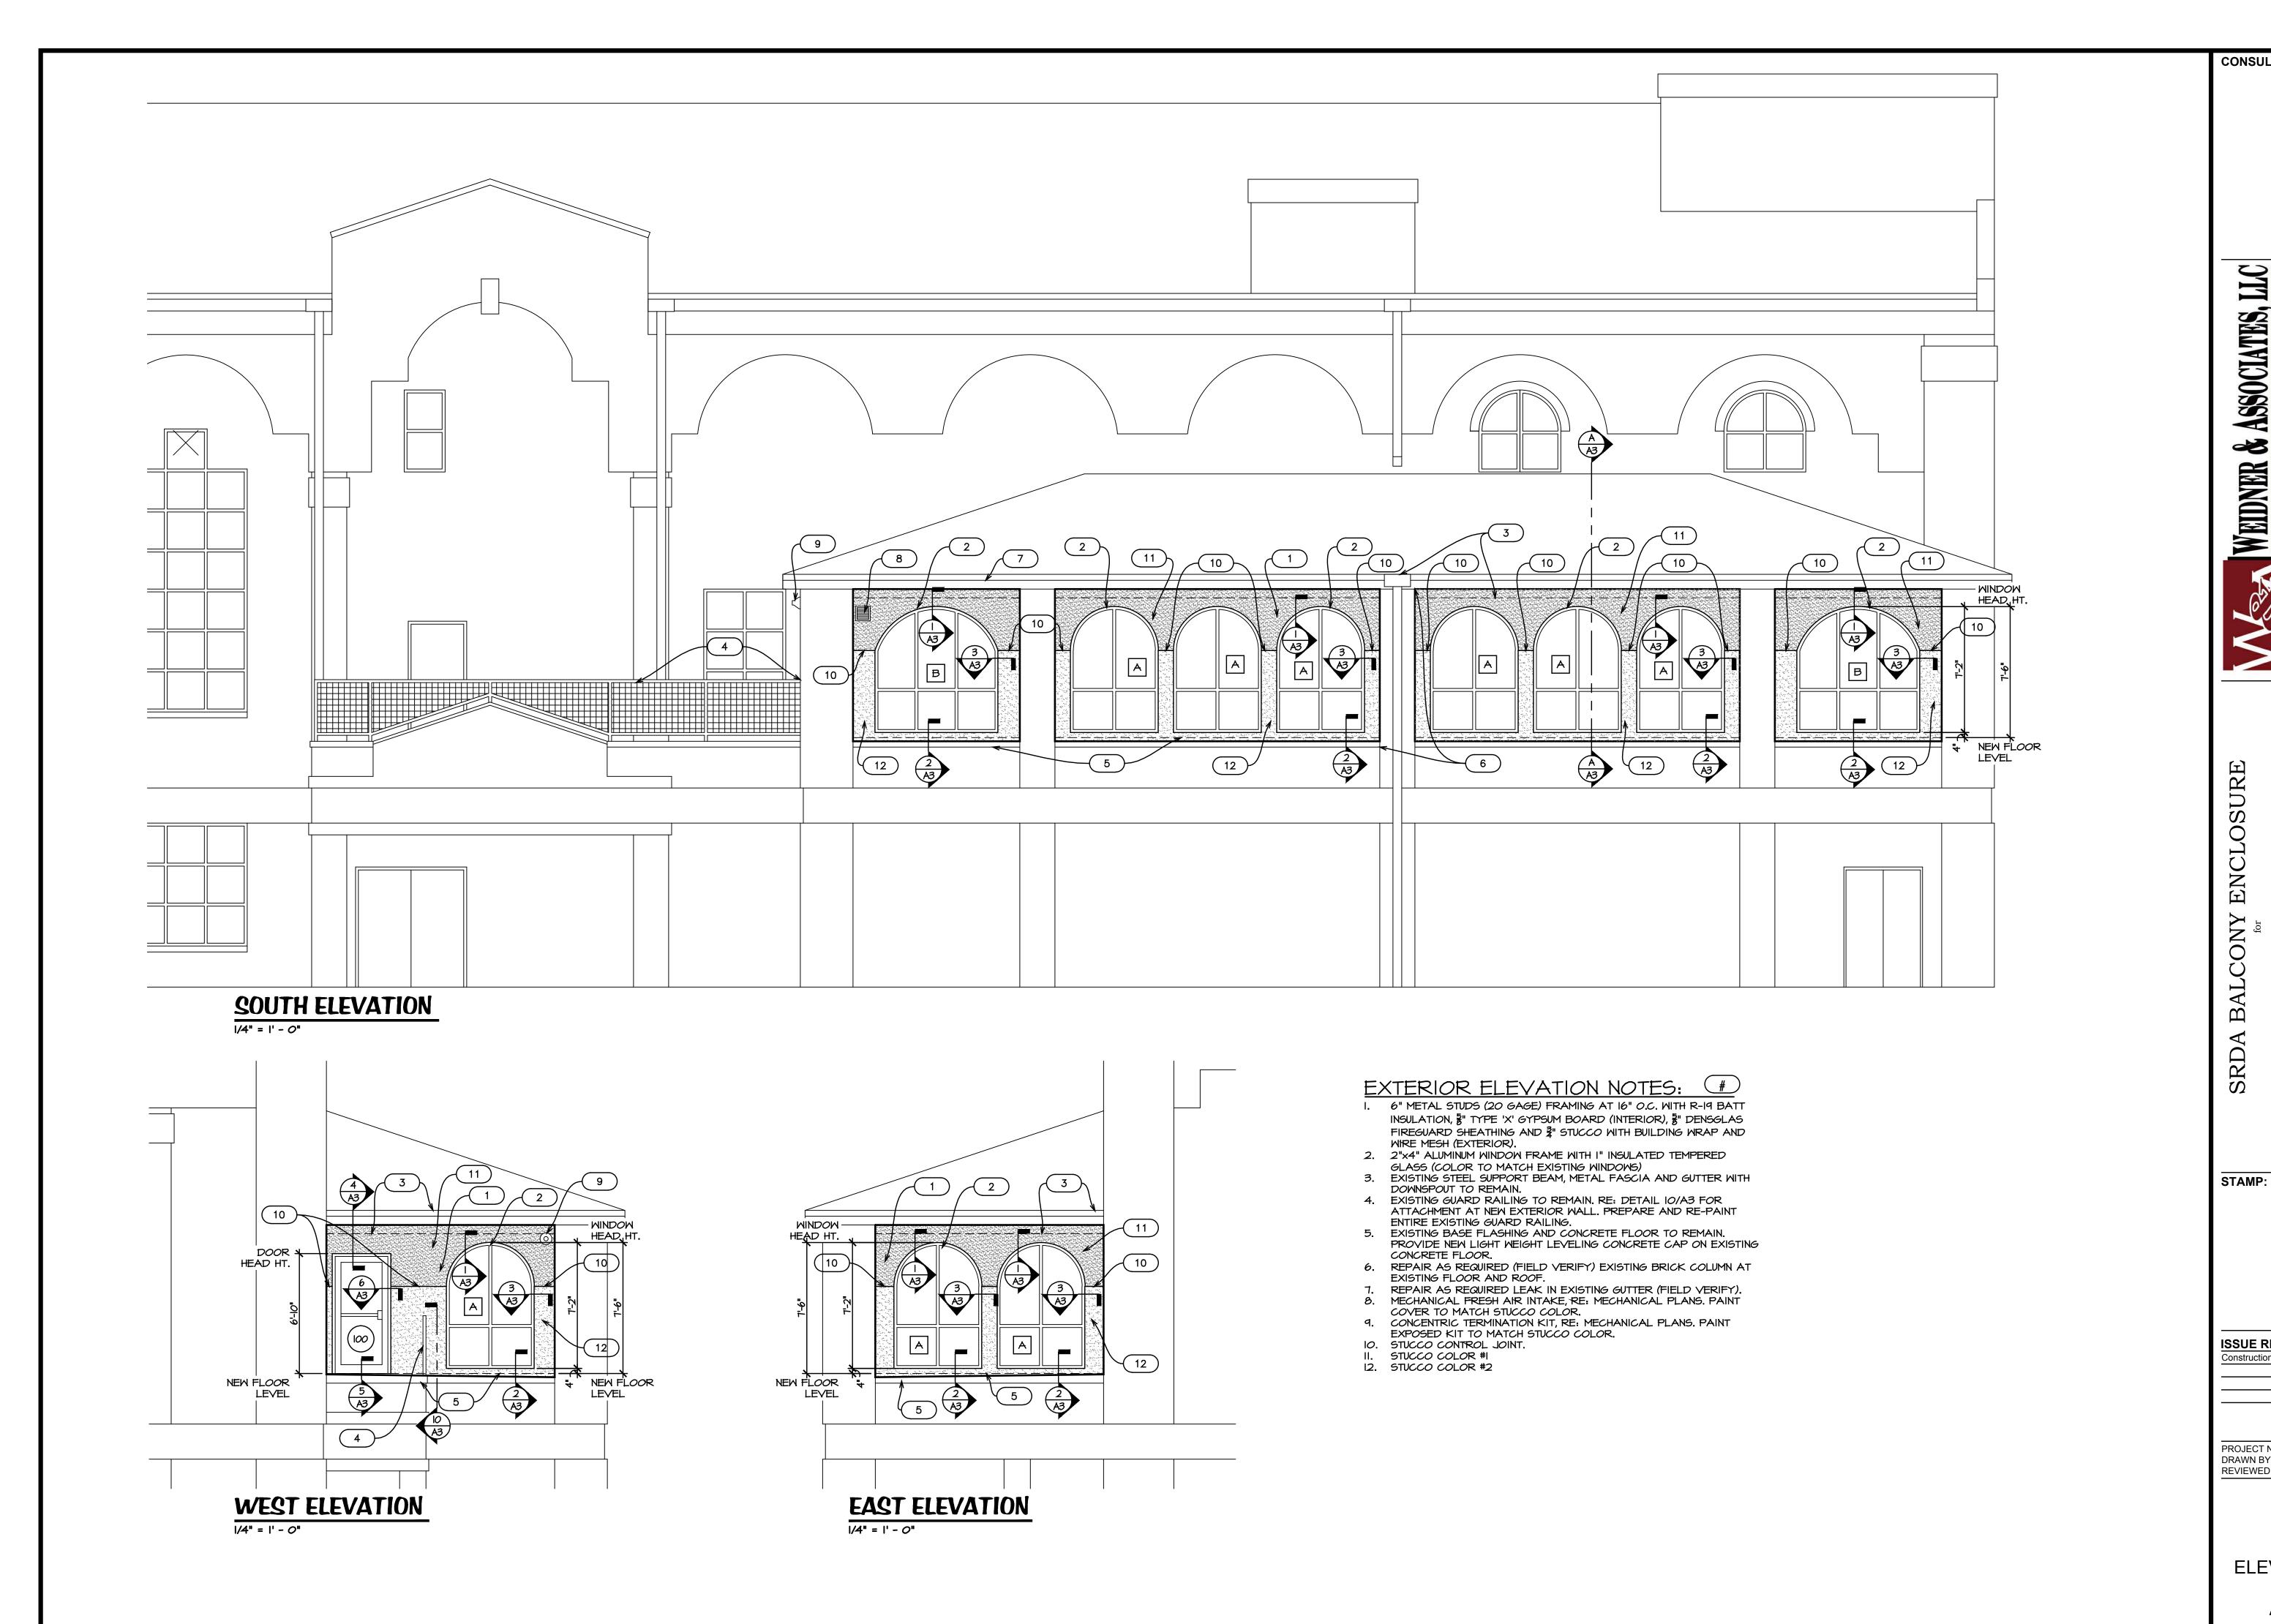

CONSULTANTS:

ASSOCIATES, LIC

WEIDNER &

Aven: 81003


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ISSUE RECORD:

Construction Documents 10-10-17

PROJECT NUMBER: 2015-24 DRAWN BY: L. Ramos REVIEWED BY: S. Weidner

**ELEVATIONS** 

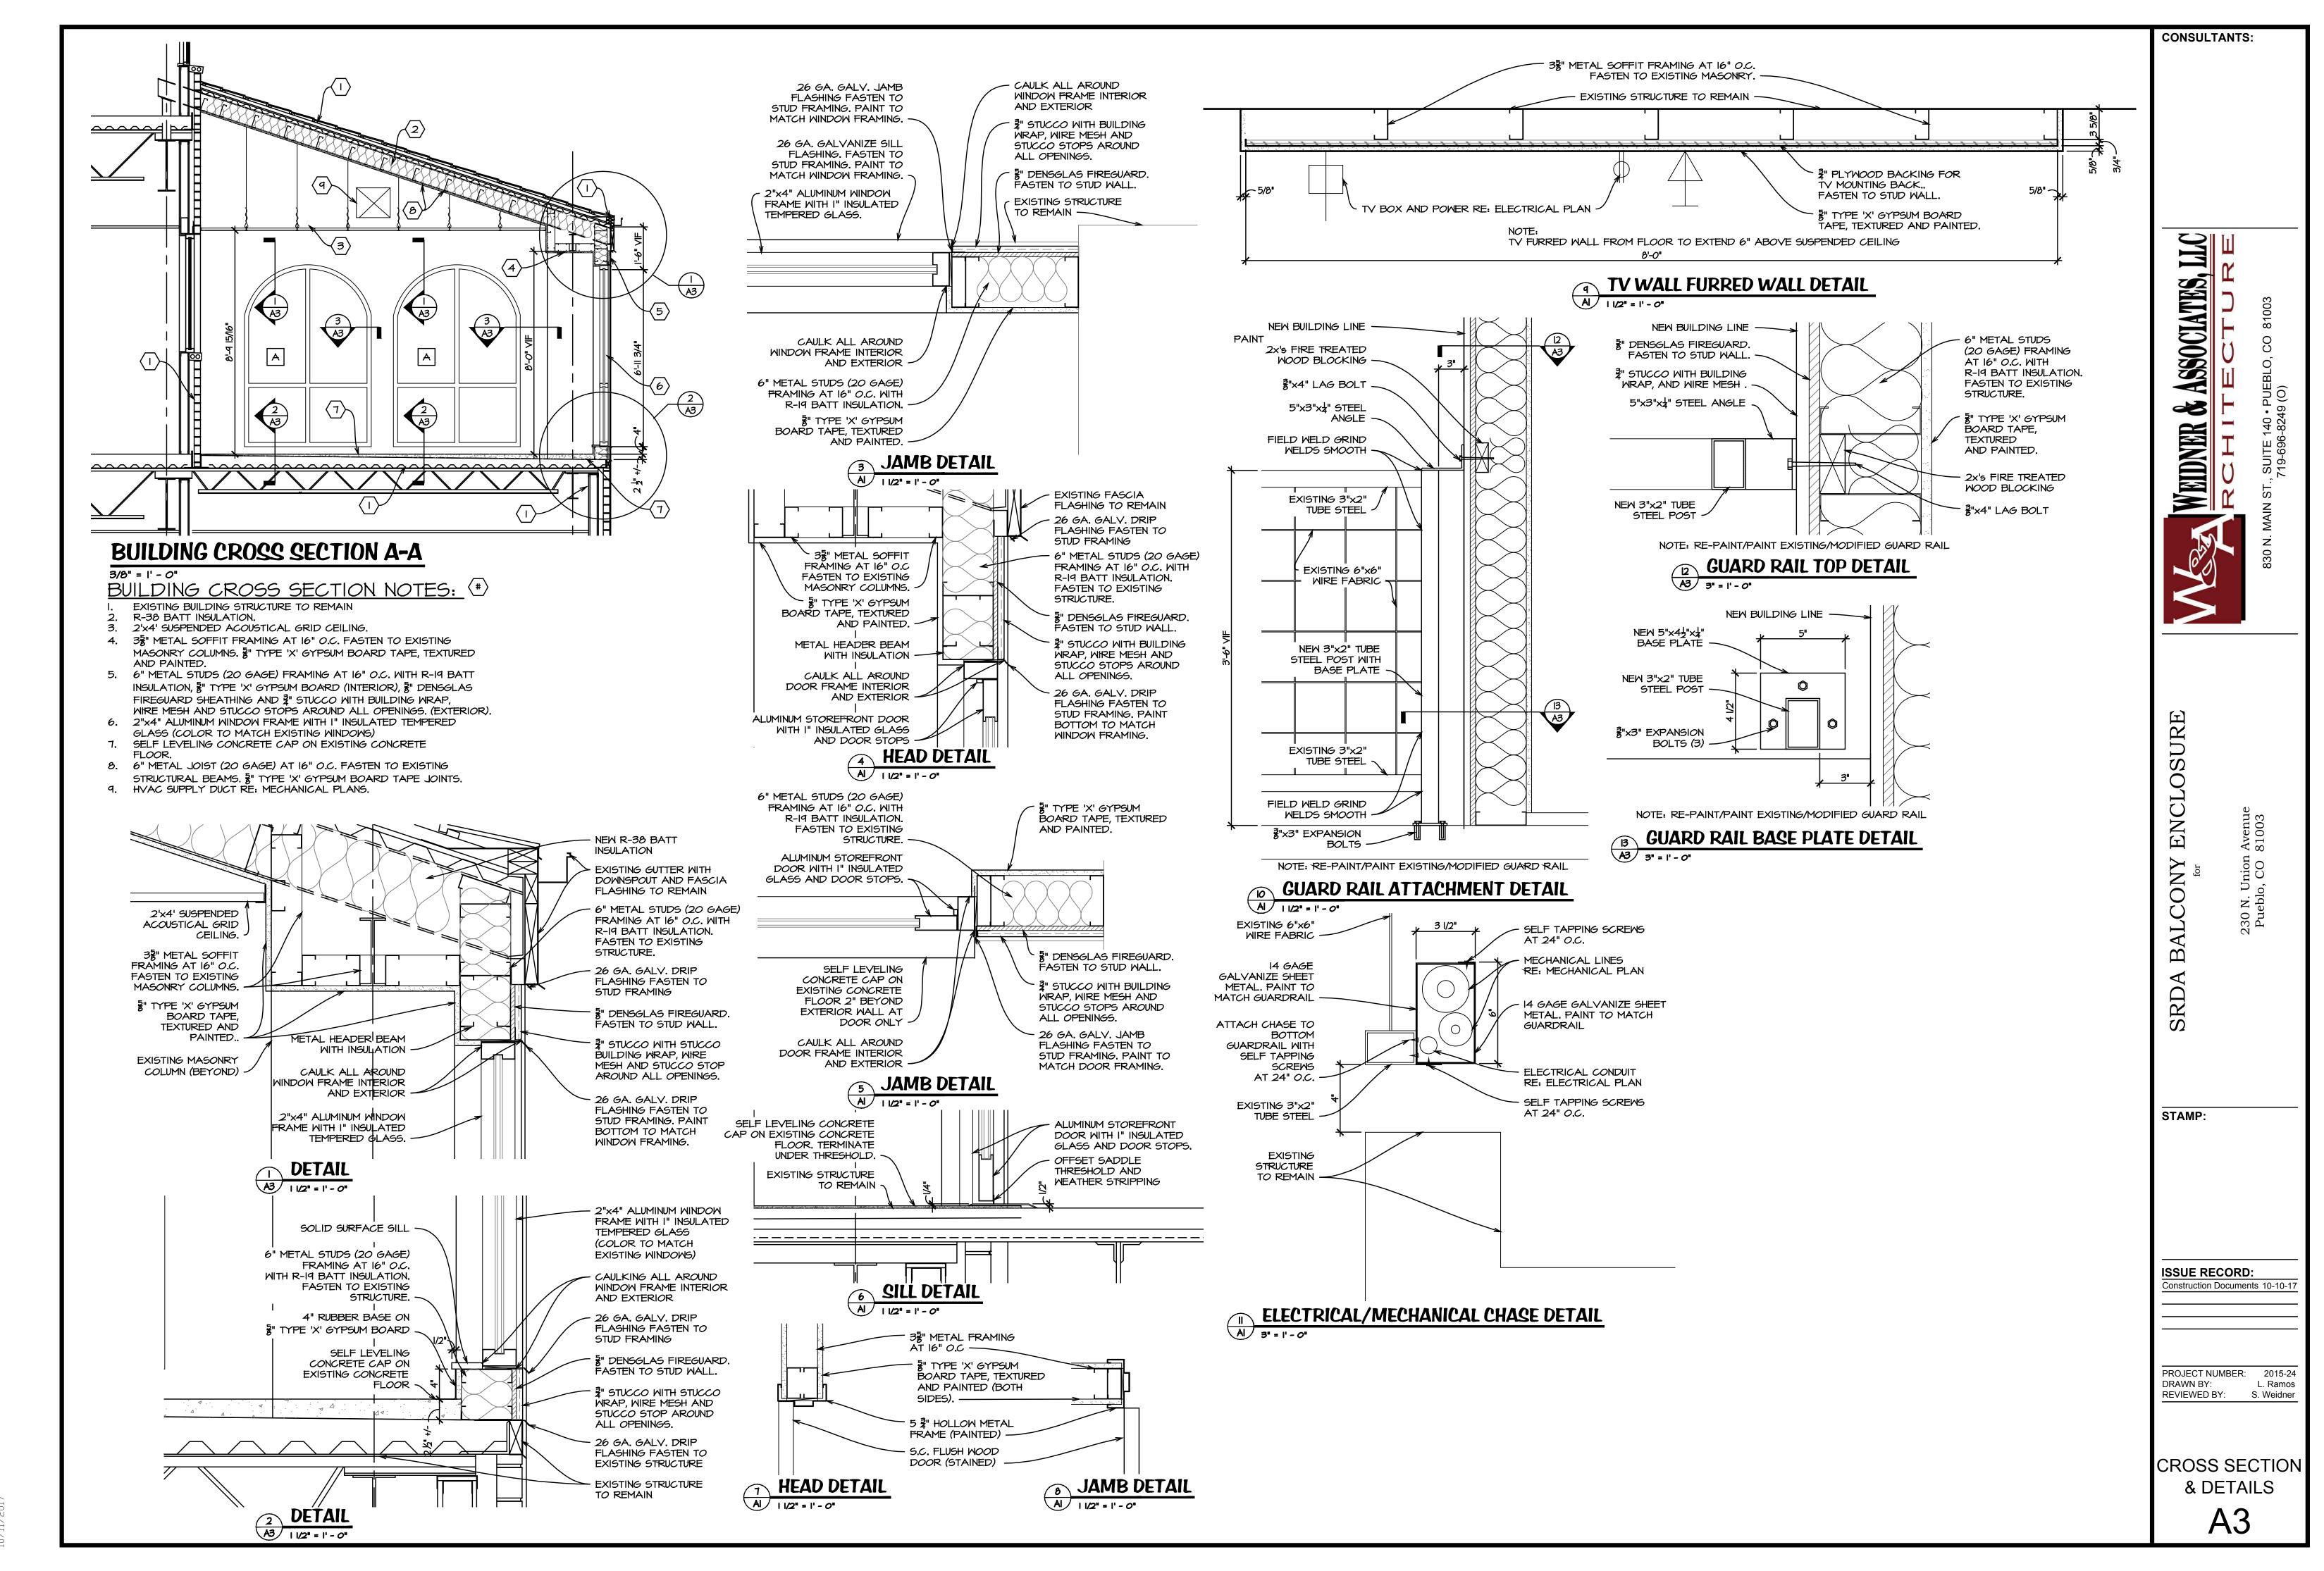

2015-24 SECT.dwg

LEGEN	(NOT ALL ITEMS WILL BE USED)	
ABBR.	SYMBOL	DESCRIPTION
		UNION, FLANGE, BLIND FLANGE
	<u></u>	SOV GATE VALVE, BALL VALVE, GLOBE VALVE, BUTTERFLY VALVE
		CHECK VALVE, STRAINER
	<del></del>	BALANCING VALVE, CALIBRATED, DYNAMIC BALANCING VALVES
	——————————————————————————————————————	LUBRICATED PLUG YALVE, PRESSURE REDUCING YALVE
	G 0 0	PIPE ELBOW DOWN, PIPE TEE DOWN, PIPE TEE UP, PIPE ELBOW UP
	—————————————————————————————————————	PIPE ANCHOR, PIPE GUIDE, PIPE SLEEVE
	<b>─────</b>	FLEX CONNECTION, PIPE EXPANSION JOINT
		SQUARE DUCT ELBOW WITH TURNING VANES
	<b>X</b>	DOWN AND BACK UP UNDER BEAM OR OBSTACLE
		SUPPLY AIR, RETURN/OUTSIDE AIR AND EXHAUST AIR
	S	DUCTWORK UNLINED AND DUCTWORK LINED
	——————————————————————————————————————	FLEXIBLE AND RIGID ROUND DUCT
		DUCTWORK TO BE REMOVED
	F S R R	FIRE, SMOKE, COMBINATION FIRE AND SMOKE, RADIATION SMOKE AND RADIATION DAMPERS
	B pm b	BAROMETRIC, MOTORIZED AND MANUAL DAMPERS, SMOKE DETECTOR
T, H, SD, NO, CO, C2	① ① ②	THERMOSTAT, HUMIDISTAT, SMOKE DETECTOR, NITROGEN DIOXIDE SENSOR, CARBON MONOXIDE OR CARBON DIOXIDE SENSOR
		WORK NOTE 1, REVISION NO. 1, DEMOLITION NOTE 1, POINT OF CONNECTION
	<del>-</del>	SUPPLY AIR, RETURN AIR/EXHAUST AIR/OUTSIDE AIR FLOW ARROWS
	A 1 M-1	SECTION A ON SHEET M-I DIAGRAM I ON SHEET M-I
	EQUIPMENT TYPE  EQUIPMENT NUMBER	EQUIPMENT TAG

			REGISTER, AND DIFFUSER SCHEDULE STORY FINISH. 2) VOLUME DAMPER. 3) SEE DRAWINGS FOR NECK SIZE AND AIR QUANTITY.	
TAG	MANUF.	MODEL	DESCRIPTION	NOTES
<b>(</b>	TITUS	TMS	SUPPLY DIFFUSER, 24x24 LOUVERED FACE, STEEL CONSTRUCTION, CEILING MOUNT	1, 2, 3
B	TITUS	35ØZR	RETURN GRILLE, LINEAR BAR, 34" SPACING, 0° DEFLECTION, ALUMINUM CONSTRUCTION, WALL MOUNT.	1, 3
0	TITUS	T7ØØ6	DOOR LOUVER, SIGHT PROOF, 1/2" SPACING, STEEL CONSTRUCTION, DOOR MOUNT	1, 3

DRA	AWING INDEX								
	REVISIONS					/2\	/3	4/	<b>/</b> 5\
	ISSUED FOR CONSTRUCTION      ISSUED FOR REFERENCE ONLY, NOT FOR CONSTRUCTION	PROGRESS Ø2/24/16	PROGRESS Ø3/14/16	ONSTRUCTION IØ/IØ/IT	ಬ್.4	ಬ್ರ∤	ISSUE DATE	169UE DATE	ISSUE DATE
NUMBER	DRAWING TITLE			O					
MØ.1	DRAWING INDEX, GENERAL NOTES, LEGENDS AND DIAGRAMS	0	0	0					
M1.1	FLOOR PLAN - HVAC	0	0	•					

#### GENERAL NOTES - HYAC

- 1. RESOLVE ALL QUESTIONS OR CONFLICTS WITH ENGINEER BEFORE ANY EQUIPMENT IS ORDERED, MATERIALS FABRICATED OR SYSTEMS INSTALLED.
- 2. COORDINATE THE INSTALLATION OF MECHANICAL SYSTEMS WITH OTHER TRADES, ESPECIALLY STRUCTURAL, PLUMBING, ELECTRICAL AND ARCHITECTURAL CEILING HEIGHTS.
- 3. COORDINATE ALL PENETRATIONS THROUGH STRUCTURAL MEMBERS WITH THE GENERAL CONTRACTOR.
- 4. COORDINATE AND VERIFY THAT ALL OPENINGS IN WALLS ABOVE CEILING / DOOR LOUVERS / DOOR UNDERCUTS ARE PROVIDED AS INDICATED ON THESE DRAWINGS.
- 5. PROVIDE OFFSETS AS NECESSARY TO ACCOMMODATE STRUCTURE AND OTHER TRADES.
- 6. ALL BUILDING EXHAUSTS/VENTS TO BE MINIMUM 10'-0" FROM BUILDING VENTILATION INTAKES.
- 1. SEAL ALL ROOF PENETRATIONS WATERTIGHT WITH SEALANT/CAULKING OR SYSTEM COMPATIBLE WITH ROOFING.
- 8. ELECTRICAL TO PROVIDE SERVICE OUTLETS WITHIN 25 FEET OF ALL ROOF MOUNTED EQUIPMENT. REFER TO ELECTRICAL DRAWINGS FOR LOCATIONS.
- 9. INSTALLATION SHALL CONFORM TO THE REQUIREMENTS OF THE 2009 INTERNATIONAL MECHANICAL CODE, APPLICABLE SECTIONS OF THE UNIFORM BUILDING CODE.
- 10. INSTALL HAIL GUARDS ON CONDENSING UNITS.
- II. INSTALL SHEET METAL COVERS FOR ALL EXPOSED REFRIGERATION PIPING.

#### DUCT SYSTEM NOTES

- 1. ALL DUCTWORK UNLESS SPECIFICALLY INDICATED SHALL BE GALVANIZED SHEET METAL INSTALLED IN ACCORDANCE WITH THE SMACNA DUCT CONSTRUCTION STANDARDS; DIMENSIONS SHOWN ARE NET CLEAR INSIDE DIMENSIONS. ALLOWANCES MUST BE MADE FOR DUCT LINER WHERE CALLED FOR
- 2. ALL SUPPLY, RETURN, EXHAUST AND OUTSIDE AIR DUCTWORK SHALL HAVE DUCTMATE OR ALL JOINTS SEALED WITH "HARDCAST" OR EQUAL DUCT SEALER/MASTIC.
- 3. ALL CONCEALED, ROUND SUPPLY AIR DUCTS 12" AND SMALLER SHALL BE GALVANIZED SHEET METAL SNAP-LOCK. ROUND SUPPLY DUCT GREATER
  THAN 12" SHALL BE GALVANIZED SHEET METAL SPIRAL. PROVIDE 1" FIBERGLASS INSULATION WRAP. INSULATED FLEXIBLE DUCT MAY BE USED FOR THE
  CONNECTION TO THE AIR OUTLET PROVIDED THE LENGTH OF THE FLEXIBLE DUCT DOES NOT EXCEED 6 LINEAR FEET.
- 4. FACTORY MADE AIR DUCTS SHALL CONFORM TO UL 181 AND INCLUDE APPROPRIATE LABEL. FLEXIBLE DUCTWORK SHALL BE APPROVED 5. CLASS Ø OR CLASS 1.
- 6. ALL BRANCH DUCT CONNECTIONS TO AIR OUTLETS, AIR INLETS, VARIABLE VOLUME TERMINALS AND BOXES SHALL BE THE SAME SIZE AS THE DEVICE NECK UNLESS SHOWN OTHERWISE ON THE DRAWINGS.
- 1. ALL DUCTWORK WITH THE EXCEPTION OF EXHAUST DUCTWORK SHALL BE WRAPPED WITH 11/2" FIBERGLASS INSULATION.
- 8. DUCT HANGERS SHALL BE A MINIMUM  $1\frac{1}{2}$ "x26 GAUGE GALVANIZED STEEL.
- 9. PROVIDE SINGLE THICKNESS TURNING VANES IN ALL SQUARE AND RECTANGULAR ELBOWS IN SUPPLY, RETURN AND GENERAL EXHAUST SYSTEMS.

## FURNACE SCHEDULE

NOTES: 1) HEAVY GAUGE ALUMINIZED STEEL HEAT EXCHANGER, 2) PROGRAMMABLE THERMOSTAT. 3) 10 YEAR COMMERCIAL WARRANTY ON HEAT EXCHANGER, 4) UP FLOW, 5) DIRECT VENT, CONDENSING FURNACE, 6) CATEGORY IV VENTING. 7) AFUE 92.1.

TAG	MANUF.	MODEL	COOLING COIL	INPUT MBH	AIR QUANT	TITY IN CFM SA	AIRSIDE AT	ESP "WC	YOLTS/#	FAZ HP	WEIGHT (LBS)	NOTES
FU-Ø1	TRANE	TUXIBØ8ØA9H3IB	CC-Ø1	80	60	1150	58	0.6	115/1	1/2	150	1, 2, 3, 4, 5, 6, 7

#### COOLING COIL SCHEDULE

NOTES: 1) PROVIDE IN CABINET CASE, MATCHED TO FURNACE SIZE. 2) PROVIDE LINE SETS OF ADEQUATE SIZE AND CONFIGURATION FOR FURNACE/COIL AND CONDENSING UNIT LOCATION. CONFIRM LINE SET SIZE WITH MANUFACTURER. 3) PROVIDE P-TRAP FOR CONDENSATE. SLOPE DRAIN A MINIMUM 1/4" PER FOOT. ROUTE TO BASEMENT DRAIN.

ROUTE TO E	SASEMENT DI	KAIN.					
TAG	MANUF.	MODEL	SERVES	CFM	TONS	WEIGHT (LBS)	NOTES
CC-Ø1	TRANE	4TXCBØ36BC3HC	CU-Ø1	1200	3	5Ø	1, 2, 3, 4

### CONDENSING UNIT SCHEDULE

NOTES: 1) REFRIGERANT LINE FILTER/DRYER. 2) R-410A. 3) RUN REFRIGERANT LINES ACCORDING TO MANUFACTURER'S RECOMMENDATIONS.

TAG	MANUF.	MODEL	SERVICE	NOMINAL TONS	<b>∨</b> OLT6/¢	MCA	MOCP	WEIGHT (LBS)	NOTES
CU-Ø1	TRANE	4TTA3Ø36A1	FU-Ø1	3	23Ø/3	15	25	23Ø	1, 2, 3

CONSULTANTS:

WEIDNER & ASSOCIATES, I.I.

ROHII CHILLIAN OF CHILT 440

for

Aven 8100

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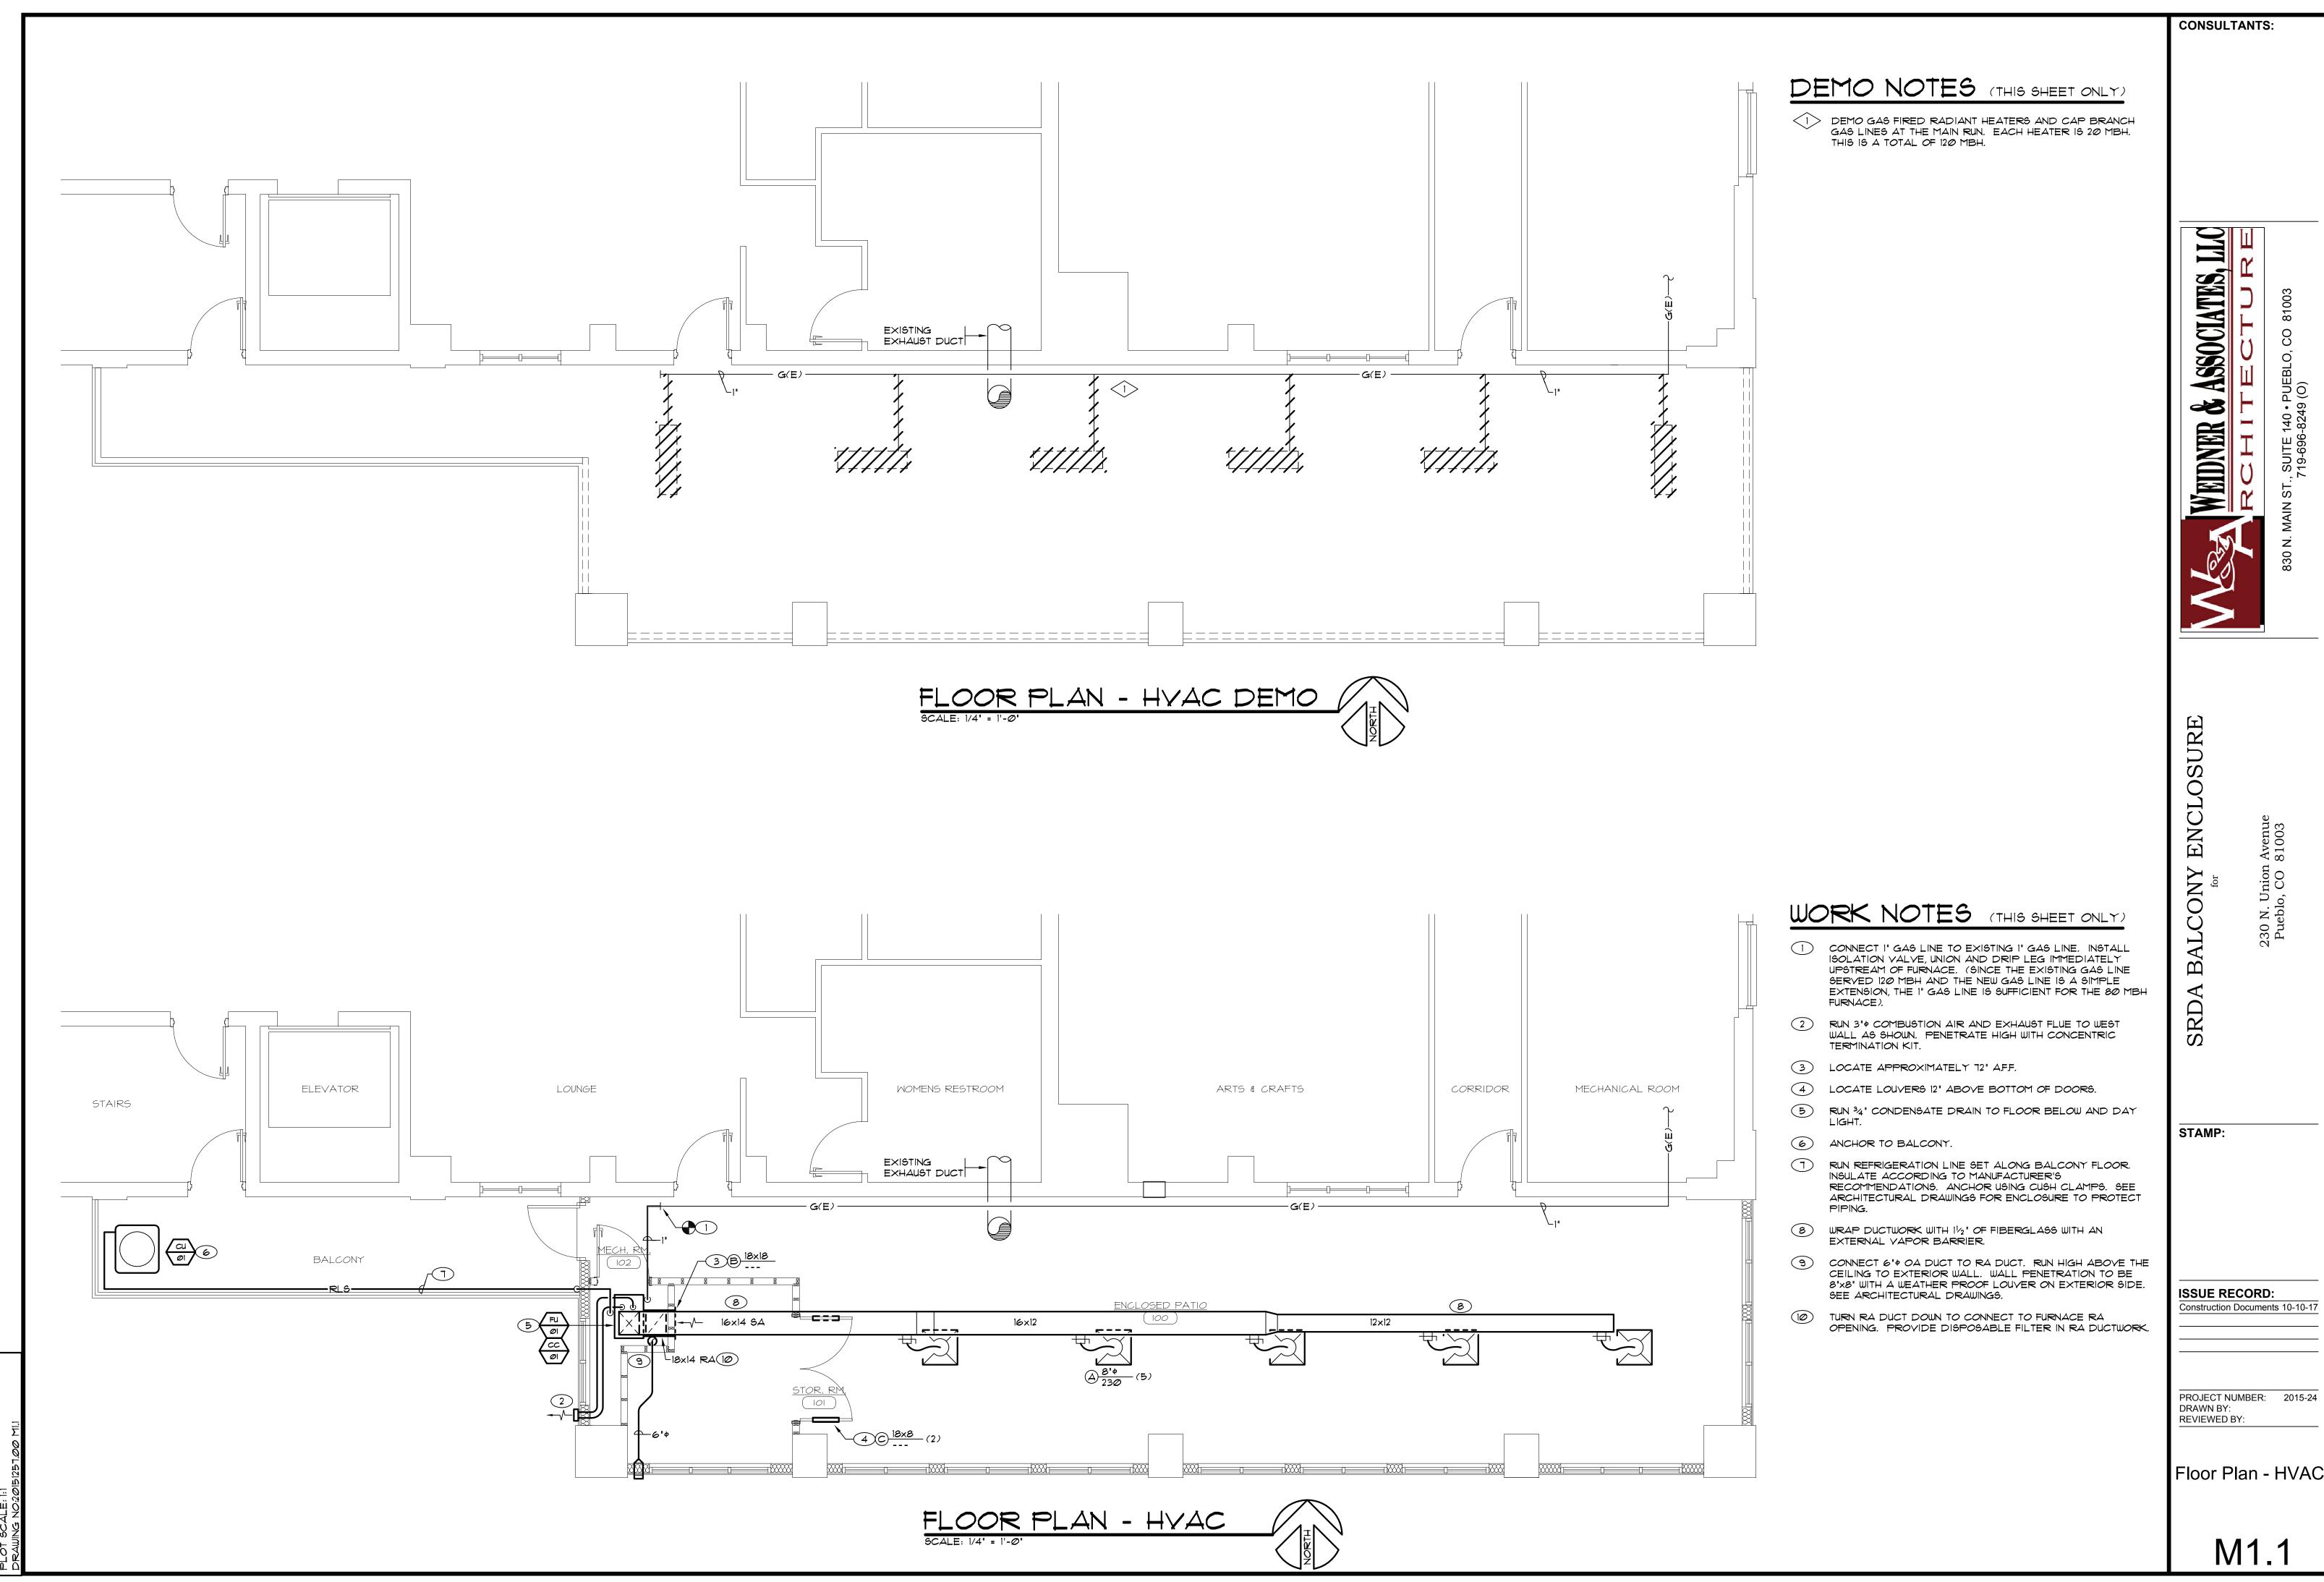
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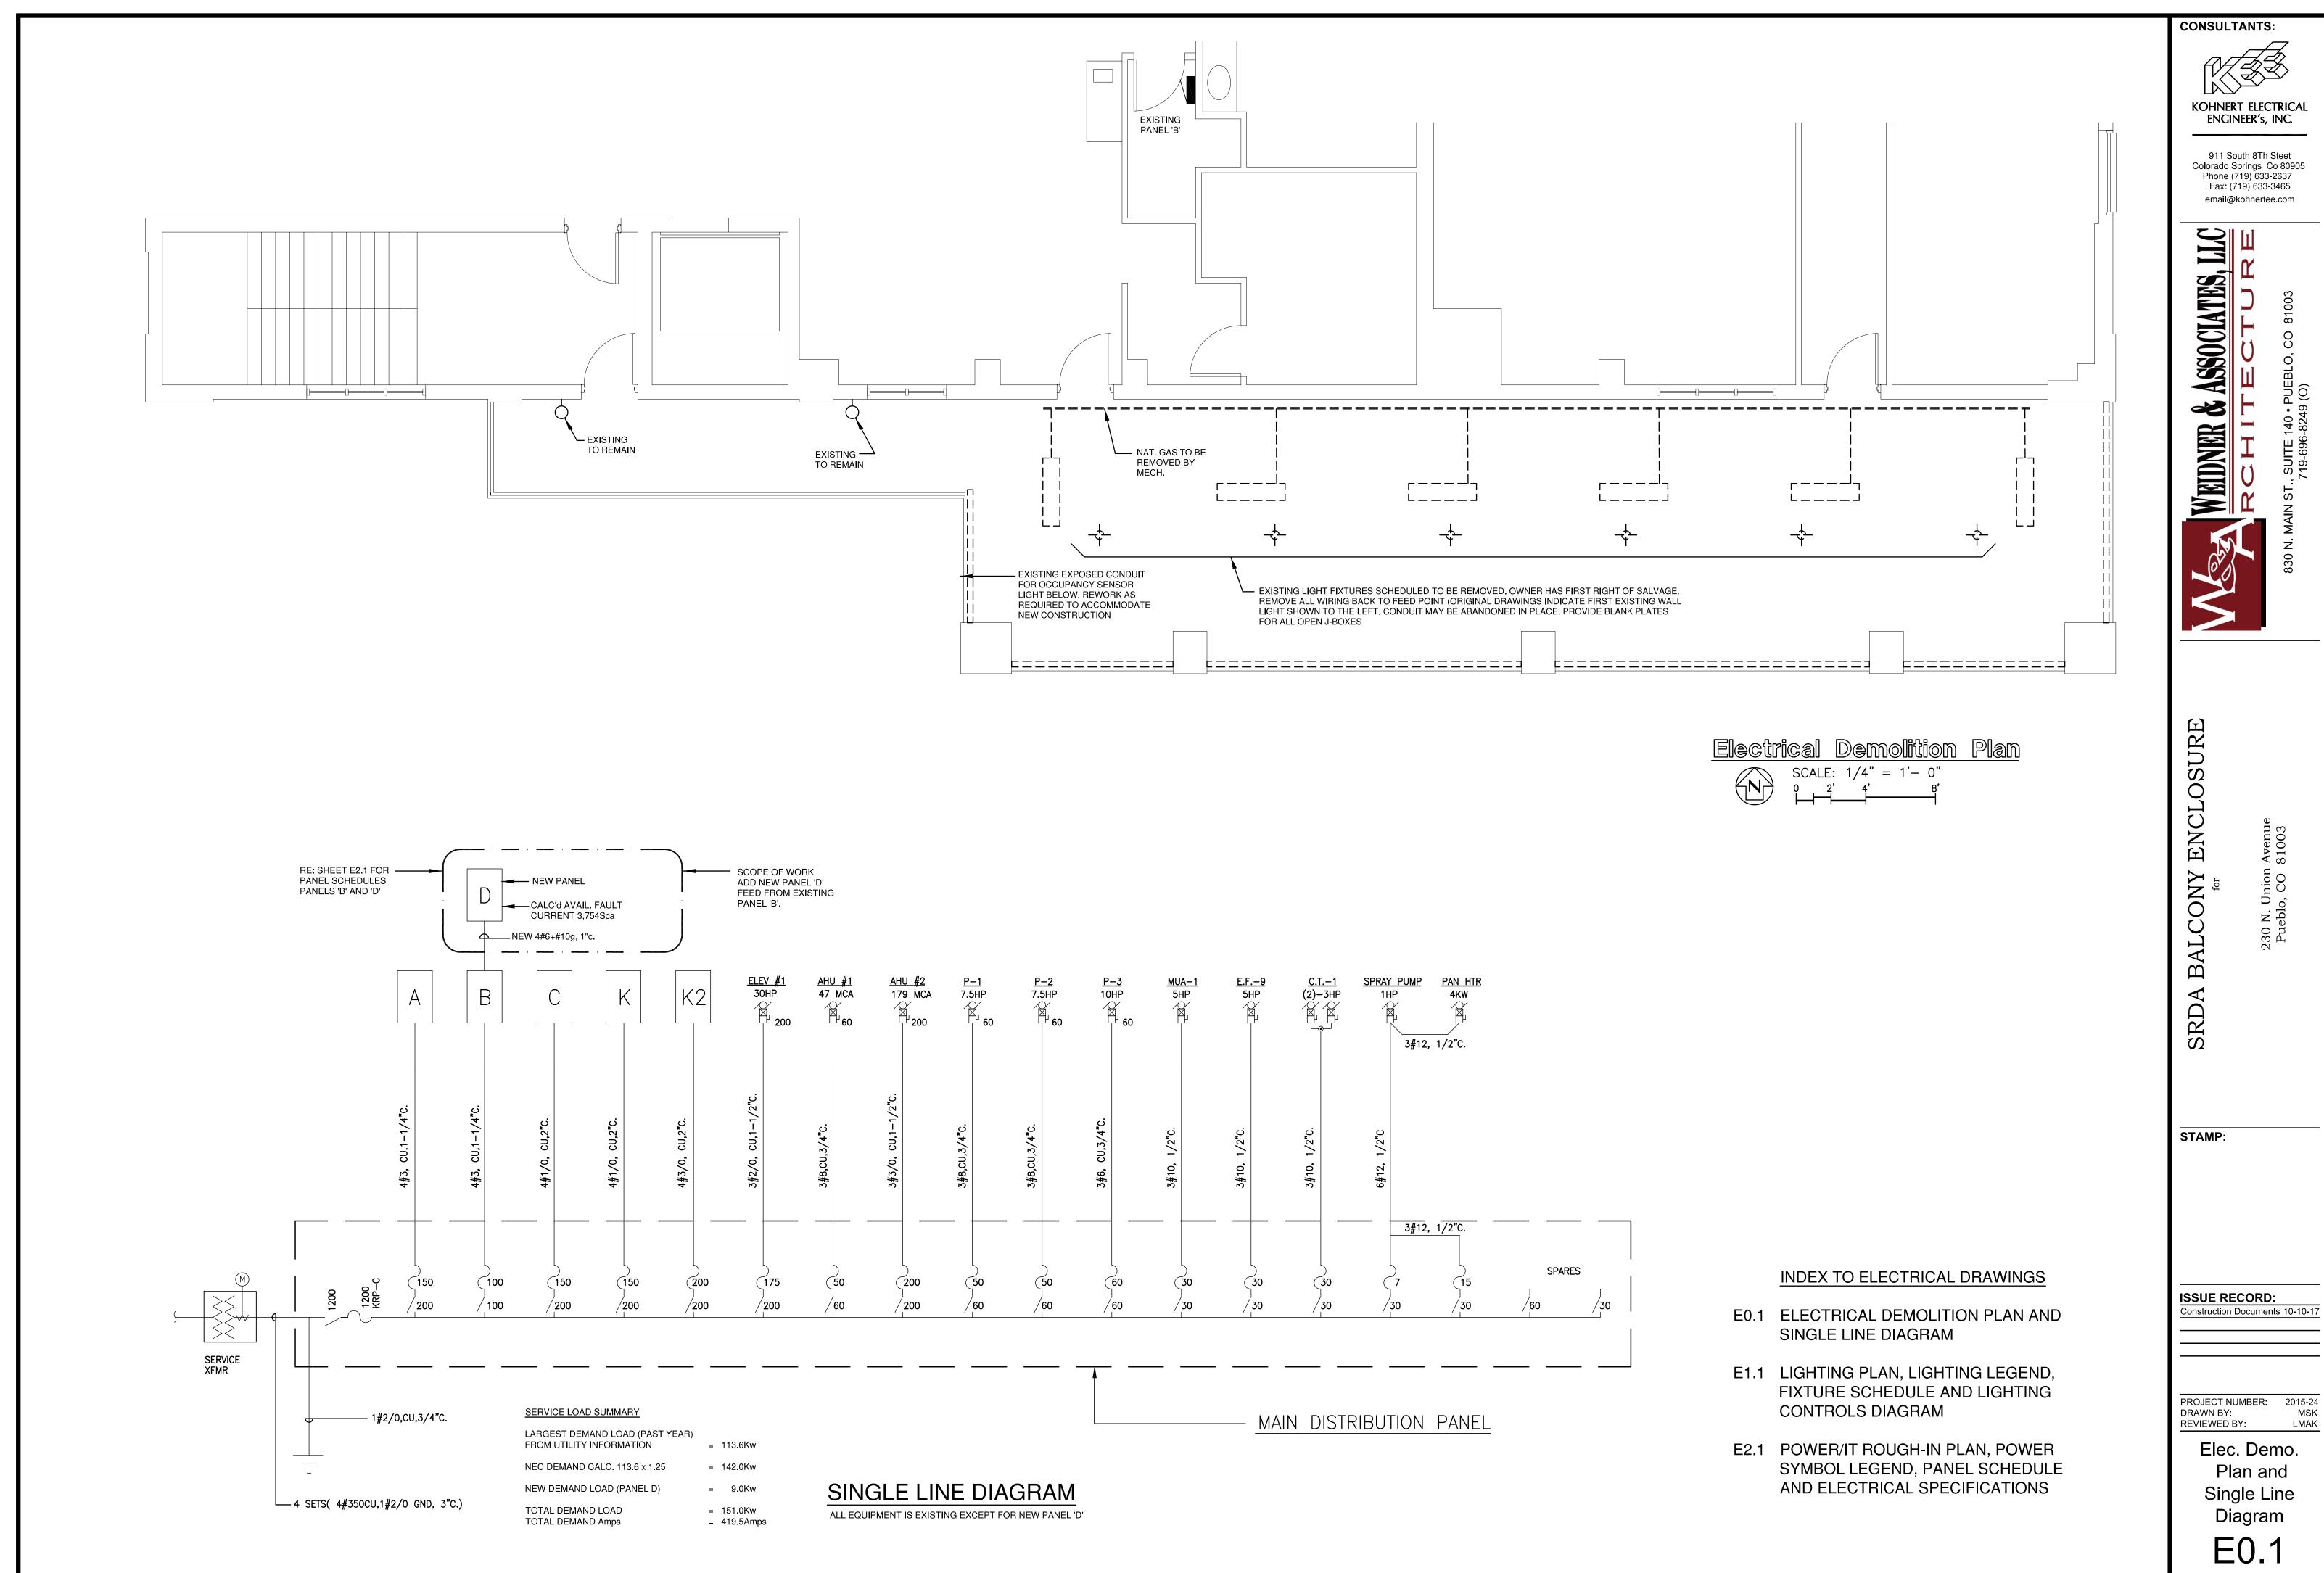
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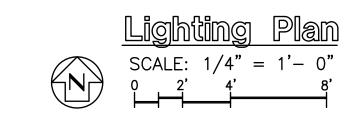
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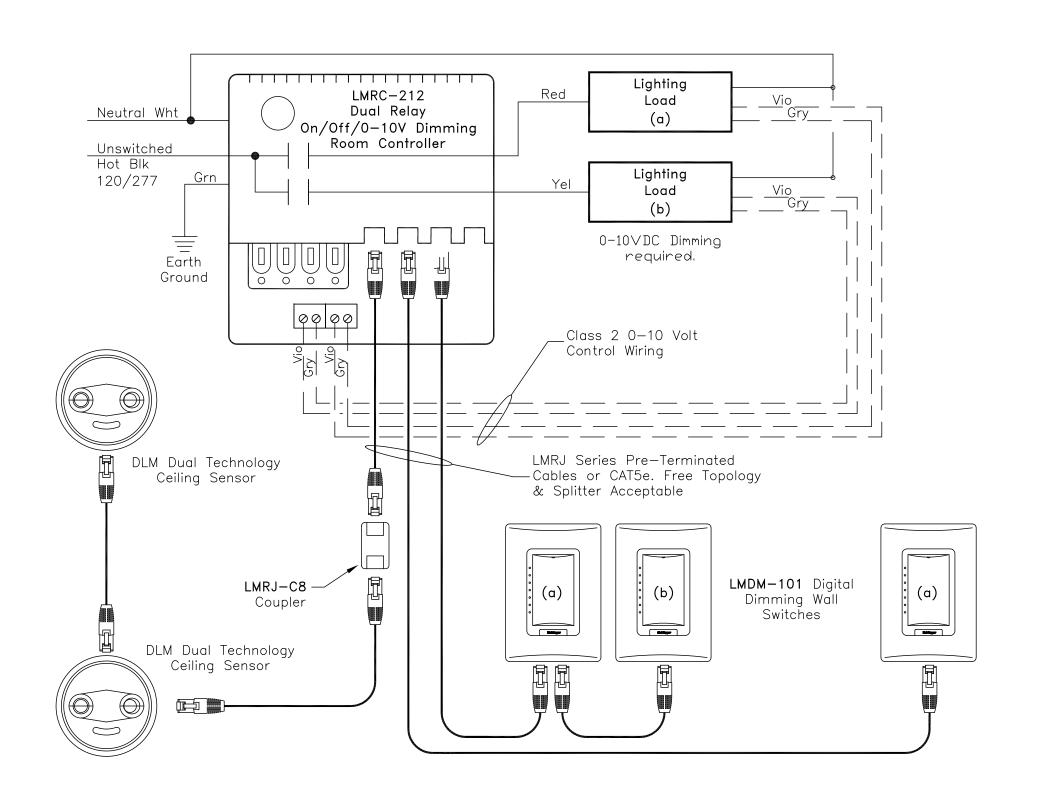
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LMAK





#### DEVICES ARE PRESET FOR PLUG n' GO™ OPERATION

Sequence of Operation: The LMRC-212 defaults to multi-level automatic-on/automatic-off operation. Load (a) on the LMRC-212 turns on automatically, while Load (b) defaults to manual-on control; all relays turn off automatically.

LIGHTING DEVICE SYMBOL LEGEND
FIXTURE DESCRIPTION
FLUORESCENT OR LED FIXTURE. UPPER CASE LETTER INDICATES TYPE, LOWER CASE LETTER INDICATES CONTROLLING SWITCH AND NUMBER IS CIRCUIT NUMBER.
LIGHT FIXTURE WIRED HOT AS NIGHT LIGHT.
CEILING MOUNTED SELF CONTAINED - EXIT SIGN/EM LIGHT. RE: FIXTURE SCHEDULE FOR ADDITIONAL INFORMATION. WIRE AHEAD OF LOCAL SWITCH OR TO HOT CIRCUIT INDICATED.
LINE VOLTAGE SWITCH
WALL MOUNTED 120V DUAL TECHNOLOGY MOTION SENSOR/ SWITCH WITH MANUAL ON-OFF OPERATION AND ADJUSTABLE TIME DELAY. FLUSH MOUNTED AT + 45" A.F.F. WATTSTOPPER #DW-100 OR APPROVED EQUIVALENT. DEVICE REQUIRES A HOT AND NEUTRAL.
DIGITAL CONTROLS
DIGITAL SINGLE BUTTON WALL DIMMER FOR ON/OFF OPERATION WITH LED STATUS, IR TRANSCEIVER AND "PLUG 'n' GO AUTOMATIC CONFIGURATION. WATTSTOPPER #LMDM-101-X OR APPROVED EQUIVALENT.
DIGITAL DUAL TECHNOLOGY CEILING MOUNTED OCCUPANCY SENSOR WITH LCD DISPLAY, IR TRANSCEIVER AND "PLUG 'n' GO AUTOMATIC CONFIGURATION. WATTSTOPPER #LMDC-100 OR APPROVED EQUIVALENT.
DIGITAL PLENUM RATED RELAY ROOM CONTROLLER/S WITH LED STATUS INDICATOR AND "PLUG 'n' GO AUTOMATIC CONFIGURATION. RE: WIRING DIAGRAM THIS SHEET.

#### <u>LIGHTING PLAN : WORK NOTES</u>

LIGHT(S) CONTROLLED BY A 1-P WALL MOUNTED (120V.) DUAL TECHNOLOGY OCCUPANCY SENSOR.

LIGHTING IN THIS ROOM IS CONTROLLED BY A MODULAR LOW VOLTAGE RELAY SYSTEM WITH LOW VOLTAGE DIMMING CONTROL. SYSTEM IS FOR TRIPLE RELAY OUTPUT. RE: WIRING THIS SHEET.

	FIXTUR	E SCHEDULE - SRDA	PΑ	ATIO	INFILL		
TYPE	PICTORAL	DESCRIPTION & MANUFACTURES	OTES	FINISH	LOCATION	l	_AMP(S)
'''	TIOTOTAL	CATALOGUE NUMBERS ALL BALLASTS ARE 120V UNLESS NOTED OTHERWISE	N N	1 1141311	LOCATION	NO.	TYPE
A		6" RECESSED LED DOWNLIGHT WITH SEMI-DIFFUSE CONE, 120V: 0-10V ELECTRONIC DIMMING DRIVER AND WHITE TRIM RING. PRESCOLITE #LF6LEDG4-X-X-6LFLED5G4-35-X-X-WT OR	1	WHITE	OPEN AREA	-	15W 1100 Lumen 3500 Deg K
В		APPROVED EQUIVALENT  2' x 2' RECESSED LED FIXTURE WITH HIGH EFFICIENT OPTICAL SYSTEM, LIFT AND SHIFT FRAME AND 120V: 0-10V DIMMABLE DRIVER. CEILING: LAY-IN ACCOUSTICAL GRID. FINELITE #HPR-A-2x2-DCO-LED-HO-3500K-120V-SO-C1 OR APPROVED EQUIVALENT	1	WHITE	OPEN AREA	-	57W 4800 Lumen 3500 Deg K
С		4' NARROW LED WRPAROUND WITH CLEAR ACRYLIC DIFFUSER, INJECTION MOLDED PLASTIC END CAPS AND 120V ELECTRONIC DRIVER. COLUMBIA #LAW-4-35-ML-E-U OR APPROVED EQUIVALENT	1	WHITE	STORAGE	-	51W 4400 Lumen 3500 Deg K
<b>₽</b> EXIT <b>₽</b>	EXIT	SELF CONTAINED GREEN LED EXIT SIGN WITH (2) EMERGENCY LIGHT HEADS, HIGH IMPACT RESISTANT THERMO-PLASTIC HOUSING, SELF DIAGNOSTICS FEATURE AND UNIVERSAL VOLTAGE ELECTRONIC DRIVER	2	WHITE	OPEN AREA	-	13W ~ 560 Lumen 4000 Deg K
No.		CEILING MOUNTED LED EMERGENCY LIGHT WITH (2) LIGHT HEADS, HIGH IMPACT RESISTANT THERMO-PLASTIC HOUSING, SELF DIAGNOSTICS FEATURE AND UNIVERSAL VOLTAGE ELECTRONIC DRIVER	2	WHITE	OPEN AREA	-	13W ~ 560 Lumen 4000 Deg K
300		SELF CONTAINED WET LOCATION LISTED EMERGENCY LIGHT WITH DIE-CAST ALUMINUM HOUSING AND INTEGRAL HEATER TO OPERATE AT -22 Deg F. DUALLITE #PG-X-HTR OR APPROVED EQUIVALENT.	1	BRONZE	EXTER. DOOR	-	2W 4000 Deg K

#### NOTES:

1. SUBMIT REQUEST FOR SUBSTITUTION FIXTURE 7 WORKING DAYS PRIOR TO BID. APPROVED FIXTURES WILL BE LISTED IN AN ADDENDUM.

2. REQUEST FOR SUBSTITUTION PRIOR TO BID NOT REQUIRED. HOWEVER, ONLY SPECIFICATION GRADE PRODUCT WILL BE ACCEPTED.

CONSULTANTS:

KOHNERT ELECTRICAL ENGINEER's, INC.

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WEIDNER & ASSOCIATES, LIRAC HITECTURE, LI

WEIDNER RCH

ONY ENCLOSURE

230 N. Union Avenue Pueblo, CO 81003

STAMP:


SRD

ISSUE RECORD:
Construction Documents 10-10-17

PROJECT NUMBER: 2015-24 DRAWN BY: MSK REVIEWED BY: LMAK

Lighting Plan
Controls Detail
Lighting Legend
Fixture Schedule

E1.1

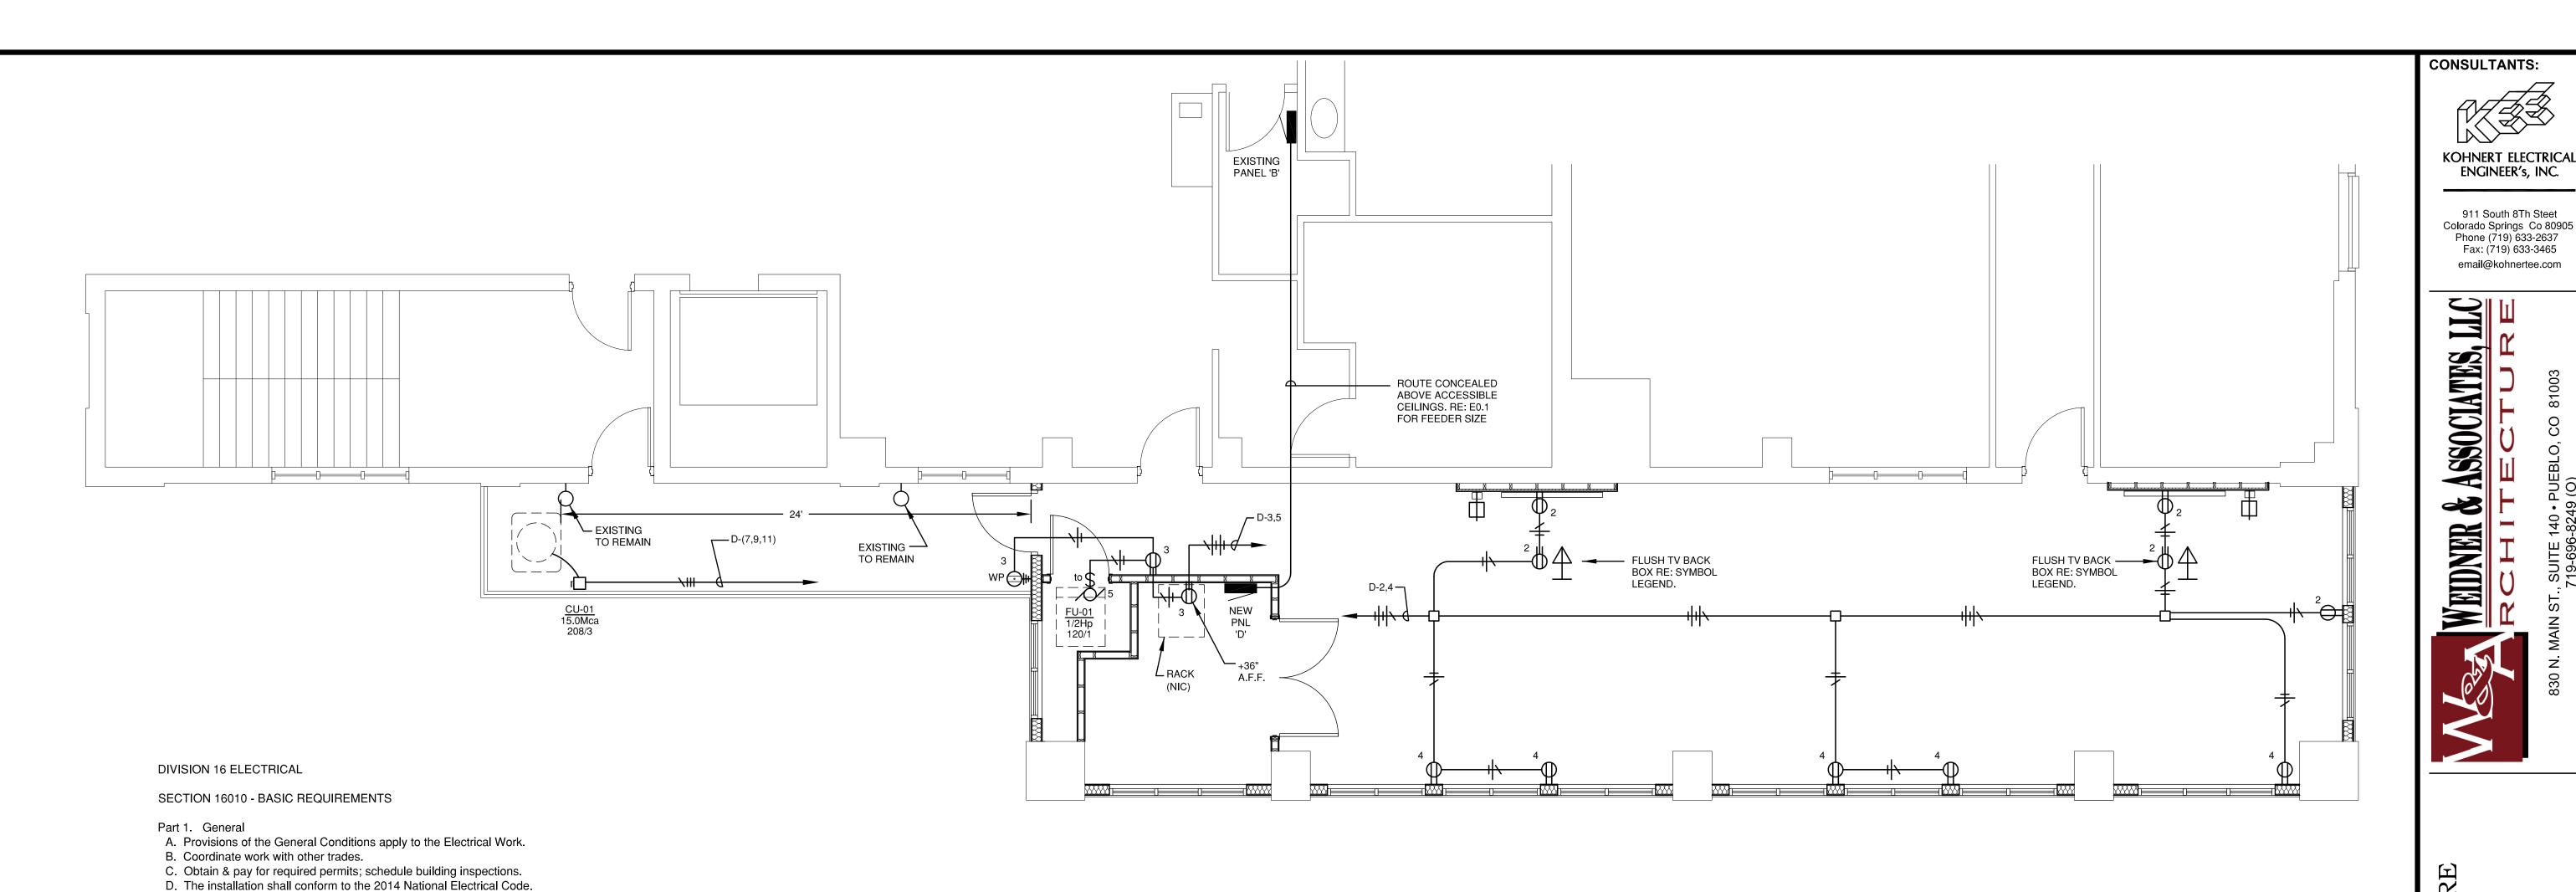

SCALE: 1/4" = 1' - 0"

### SECTION 16050 - BASIC MATERIALS & METHODS

A. Use GRC where exposed up to 5' above floor, EMT elsewhere.

B. Flexible conduit limited to 6' length.

C. Use metal bushings w/insulated throat (OZ type "BLO"). D. Use raintight compression fittings on all exterior conduits.

Part 2. Outlets

A. One piece only, 4"sq min. for wall outlets w/appropriate ring.B. Weatherproof: Cast box w/NEC Art.410-57(b) approved cover.

#### Part 3. Wiring, Devices & Plates:

A. Receptacles - 15 or 20A Ivory, Commercial grade or better.

Part 4. Wire

A. Copper, min. 75 degree C. insulated (THHN, THWN or XHHW).B. Branch circuit conductors #12 minimum.

C. Wiring in lighting fixtures, 90 degree C. rated.

Part 5. Installation

A. Support conduit from structure, not from ceiling suspension wires. Supports to be maximum of 7' apart.

SECTION 16180 EQUIPMENT WIRING SYSTEMS

Part 1. Mechanical Units

A. Raintight liquid flexible conduit.

B. Heavy Duty Disconnects. Nema 3R for Exterior Application.

SECTION 16190 SUPPORTING DEVICES

Part 1 Conduits

A. One or two hole straps or adjustable steel hanger attached to structure.

Part 2. Boxes and Cabinet Supports

A. Surface mounted cabinets - provide a min. of (4) anchors. B. Flush mtd cabinets - provide channel support top & bottom.

Part 3. Anchors

A. Hollow masonry - Toggle bolts.

B. Solid masonry - Lead expansion anchors and preset inserts. C. Metal surfaces - Machine screws, bolts or welded studs.

SECTION 16195 - ELECTRICAL IDENTIFICATION

PART 1 GENERAL

A. Directory Cards - Type written with erasable letters for 'Spares'

B. Engraved Nameplates - For Main Service Disconnects & Panelboards

PART 2 PRODUCTS - MATERIALS

A. Engraved Plastic Plates: Black letters on white background with

self-adhesive back. 1/2" High Letters for Part 1.- B. B. Directory Cards: Manufacturer's standard pre-printed form under

clear plastic protective cover.

VOL		1 0	IX L	<i>-</i>	NE	L	В	
	TS/PHASE/WIRE 120	/208/	3ph-4	·w		MAIN	DEVICE 100a MLO	
MOL	JNTING <u>SURFACE</u>					S.C. F	RATING 10.000 AIC	
		eplace	Existi	ng	20/1	Break	/Load ers with New Indicated ND DEMANDS APPLIED BY THE ENGINE	
	PHASE A (KVA) 11.1 PHASE B (KVA) 10.7 PHASE C (KVA) 11.0 AVERAGE AMPS/LE		FD ON	D	LOA DUT	D FACTY/DEM	AND KVA 34.77	
#	DESCRIPTION	LOAD	BRKR			LOAD	DESCRIPTION	#
1	Receptacle	720	E20/1	$\boldsymbol{\vdash}$	E20/1	720	Receptacle	<del> </del> "2
3	Receptacle	900	E20/1	_			Receptacle	4
5	Receptacle	900		-			Plugmold	6
7	Othr : Hand Dryer	1,500	E20/1	Α	E20/1	1,080	Plugmold	8
9	Othr : Hand Dryer	1,500	E20/1	В	E20/1	1,080	Plugmold	10
11	Receptacle	1,080	E20/1	С	E20/1	1,260	Receptacle	12
13	Receptacle	1,080	E20/1	Α	E20/1	1,080	Receptacle	14
15	Lighting	1,360	E20/1		E20/1		Lighting	16
17	Lighting	1,440	E20/1	_		1,320	Lighting	18
19	Lighting	720	E20/1	-	E20/1		Lighting	20
21	Corridor Lighting	840	E20/1		E20/1		Lighting	22
23	Patio Lighting	140	E20/1	-	E20/1	•	Lighting	24
25	New Panel 'D'	2,800	N60/3	Α	E20/1	560	Lighting	26
27	Do	2,700	Do	В	E20/1		Spare	28
29	Do	2,600	Do	С	E20/1		Spare	30

	SCHEDULE	FO	R F	> <i>/</i>	ANE	L	D	
VO	DLTS/PHASE/WIRE 120	/208/	3ph-4	w	_	MAIN	DEVICE 100a MLO	
МС	DUNTING <u>SURFACE</u>					S.C.	RATING 10.000 AIC	
NC	DTES: New Panel N/A							
LOAD	FACTOR INCLUDES NEC CONTINUOUS	DUTY LO	DADS, NE	C DI	EMAND FA	CTORS, A	ND DEMANDS APPLIED BY THE ENGINE	ER
	PHASE A (KVA) 2.8				CON	NECTE	ID KVA 8.05	
							TOR 1.12	
	PHASE B (KVA) <u>2.7</u> PHASE C (KVA) <u>2.6</u>						IAND KVA 8.98	
	AVERAGE AMPS/LE			D		•		
#	DESCRIPTION	LOAD	BRKR	PH	BRKR	LOAD	DESCRIPTION	T
1	Ltg : Open Area	435	20/1	Α	20/1	900	Rec : TV Wall	T
3	Rec : Entry	540	20/1	В	20/1	720	Rec : Window Wall	T
5	Mtr : Furnace	1,130	20/1	С	20/1		Spare	T
7	AC : Condensing Unit	1,440	15/3	Α	20/1		Spare	T
9	Do	1,440	Do	В	20/1		Spare	T
11	Do	1,440	Do	С	20/1		Spare	Ī
13	Space			Α			Space	T
15	Space			В			Space	T
17	Space			С			Space	T
	ENCLOSURE TYPE: NEMA CLASS OF EQUIPMENT: PA		ARD			BRE	AKER TYPE: BOLT ON NO. CIRCUITS: 18	

	POWER & SIGNAL LEGEND
SYMBOL	DESCRIPTION
Φ	20A, DUPLEX RECEPTACLE NEMA TYPE 5-20R. MOUNT AT +18" UNLESS NOTED OTHERWISE.
<b>₽</b> WP	20A, 'GFCI' DUPLEX RECEPTACLE. 'WP' INDICATES 'RAINTIGHT WHILE IN-USE' COVER. INSTALL AT $\pm$ 24" A.F.F.
<b>(</b> ) $\Box$	JUNCTION BOX.
0	HEAVY DUTY, NEMA 3R, MOTOR RATED DISCONNECT SWITCH.
	SURFACE MOUNTED BRANCH CIRCUIT PANEL.
	FLUSH MOUNTED BRANCH CIRCUIT PANEL.
<del>  </del>	BRANCH CIRCUIT CONDUIT RUN CONCEALED. PROVIDE (GREEN) EQUIPMENT GROUND IN ALL RUNS. DEDICATED NEUTRALS REQUIRED FOR ALL SINGLE POLE CIRCUITS.
$\Phi \stackrel{ op}{ op}$	PROVIDE FLUSH TV BACK BOX (NOMINAL 11" x 11" x 3 1/2" Deep) BOX WITH A 15A DUPLEX RECEPTACLE AND 1 -1 1"c STUBBED INTO ACCESSIBLE CEILING CAVITY. LEGRAND 'EVOLUTION SERIES - EFSB2 WALL BOX OR EQUIVALENT. PROVIDE INSULATED BUSHINGS ON EACH END OF CONDUIT. COORDINATE FINAL MOUNTING LOCATION AND HEIGHT WITH THE OWNER'S REPRESENTATIVE.
Ф	PROVIDE FLUSH 4S BOX WITH SINGLE GANG RING AND 1"c. INTO ACCESSIBLE CEILING CAVITY (FOR OWNER CONTROL PANEL). PROVIDE INSULATED BUSHING ON EACH END OF CONDUIT. COORDINATE FINAL MOUNTING LOCATION AND HEIGHT WITH THE OWNER'S REPRESENTATIVE.

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EN

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Power/IT

Rough-In Plan

and Power

Symbol Legend

Aven 8100

30 Pue