DESIGN TEAM CODE INFORMATION APPLICABLE BUILDING CODES ARCHITECT OF RECORD: **CIVIL ENGINEER:** COLORADO DEPARTMENT OF THE FOLLOWING APPROVED BUILDING CODES AND STANDARDS HAVE BEEN ADOPTED BY TRANSPORTATION STATE BUILDINGS PROGRAMS (SBP) AS THE MINIMUM REQUIREMENTS TO BE APPLIED TO ALL STRUCTURAL ENGINEER: STATE-OWNED BUILDINGS AND PHYSICAL FACILITIES INCLUDING CAPITAL CONSTRUCTION 15285 S GOLDEN RD, BLDG 47 AND CONTROLLED MAINTENANCE CONSTRUCTION PROJECTS. GOLDEN, CO 80401 2015 INTERNATIONAL BUILDING CODE (IBC) (303) 512-5535 **GEOTECHNICAL ENGINEER:** 2015 INTERNATIONAL FIRE CODE (IFC) FAX (303) 512-5550 N/A 2015 INTERNATIONAL MECHANICAL CODE (IMC) 2015 INTERNATIONAL ENERGY CONSERVATION CODE (IECC) MECHANICAL, ELECTRICAL, AND BUILDING CODE REVIEW: 2014 NATIONAL ELECTRICAL CODE (NEC) CWEST CODE CONSULTANTS, INC. PLUMBING ENGINEER: 2015 INTERNATIONAL PLUMBING CODE (IPC) MEP ENGINEERING, INC. GARY NICKERSON 2015 INTERNATIONAL FUEL GAS CODE (IFGC) THE NATIONAL FIRE PROTECTION ASSOCIATION STANDARDS (NFPA) KEVIN PRZYTARSKI 355 S. TELLER STREET

NFPA-1 (2006), 11 (2005), 12 (2005), 12A (2004), 13 (2002), 13D (2002), 13R (2002), 14,

(2003), 15 (2001), 16 (2003), 17 (2002), 17A (2002), 20 (2003), 22 (2003), 24 (2002), 25

THE 2009 EDITION OF ICC/ANSI A117.1, ACCESSIBLE AND USABLE BUILDINGS AND FACILITIES

(2002), 72 (2002), 409 (2004), 423 (2004), 750 (2003) and 2001 (2004)


ANSI/ASHRAE/IES STANDARD 90.1 - 2013 ENERGY STANDARD FOR BUILDINGS

DRAWING INDEX COVER CODE INFORMATION & INDEX A0.1 GENERAL NOTES


ELECTRICAL:									
E1.0	ELECTRICAL ONE-LINES, NOTES AND								
	LEGEND								
E1.1	ELECTRICAL SCHEDULES								

E2.0 ELECTRICAL DEMOLITION PLAN


E3.0 POWER AND LIGHTING PLANS

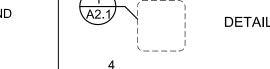


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SYMBOLS

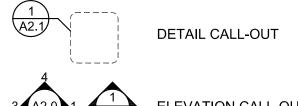

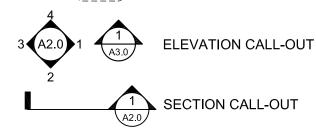

KEYNOTE TAG

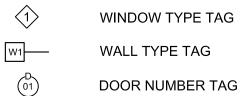VICINITIVIAE
PROJECT LOCATION: —
28201 W. HWY 50 \
LA JUNTA, CO 81020 \
W HWY 50
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15 / 10 / 10 / 10 / 10 / 10 / 10 / 10 /

VICINITY MAP

STANDARD ABBREVIATIONS

ARCHITECTURAL:

MECHANICAL:

A1.0 DEMOLITION PLANS

A2.0 CONSTRUCTION PLANS

A3.1 INTERIOR ELEVATIONS

M1.1 MECHANICAL SCHEDULES

M3.0 MECHANICAL PLAN

M1.0 MECHANICAL LEGEND & DIAGRAMS

M2.0 MECHANICAL DEMOLITION PLAN

P1.0 LEGEND AND GENERAL NOTES


P1.1 SCHEDULES AND DIAGRAMS

P2.0 PLUMBING DEMO PLAN

P3.0 PLUMBING PLAN

P3.1 PLUMBING PLAN

A.B.	ANCHOR BOLT	C.O.	CLEAN OUT	EWH	ELECTRIC WATER HEATER	GB	GRAB BAR	JT	JOINT	O.C.	ON CENTER(S)	RM	ROOM	T.O.W	TOP OF WALL
A/C	AIR CONDITIONING	COL	COLUMN	EXH	EXHAUST	GC	GENERAL CONTRACTOR			OD	OUTSIDE DIAMETER	ROW	RIGHT OF WAY	TS	STEEL TUBING
ACT	ACOUSTICAL CEILING TILE	CONC	CONCRETE	EXIST	EXISTING	GL	GLASS	KVA	KILOVOLT - AMPERES	O.H.	OPPOSITE HAND			T-STAT	THERMOSTAT
ADD	ADDENDUM	CONT	CONTINUOUS	EXP	EXPANSION, EXPOSED	GPM	GALLONS PER MINUTE	KW	KILOWATT	OHD	OVERHEAD	S	SOUTH	TYP	TYPICAL
ADD'L	ADDITIONAL	CPT	CARPET	EXT	EXTERIOR	GSF	GROSS SQUARE FEET			OPNG	OPENING	SAN	SANITARY		
ADJ	ADJACENT, ADJUSTABLE	СТ	CERAMIC TILE			GYP BD	GYPSUM BOARD	L	ANGLE	OPP	OPPOSITE	SC	SEALED CONCRETE	UNFIN	UNFINISHED
AFF	ABOVE FINISHED FLOOR	C/W	CURTAIN WALL	FA	FIRE ALARM			LAM	LAMINATE	O.T.S.	OPEN TO STRUCTURE	SCHED	SCHEDULE(D)	UL	UNDERWRITER LABORATORY
ALUM	ALUMINUM	CW	COLD WATER	FACP	FIRE ALARM CONTROL PANEL	НВ	HOSE BIBB	LAV	LAVATORY			SD	SOAP DISPENSER	UON	UNLESS OTHERWISE NOTED
ALT	ALTERNATE			FBO	FURNISHED BY OTHERS	HDR	HEADER	LT	LIGHT	P/C	PRECAST CONCRETE	SEC	SECTION, SECOND	UR	URINAL
AOR	ARCHITECT OF RECORD	D/B	DESIGN/BUILD CONTRACTOR	FD	FLOOR DRAIN, FIRE DAMPER	HDWR	HARDWARE			PEMB	PRE-ENGINEERED MTL BLDG	SF	SQUARE FEET		
APPROX	C APPROXIMATE	DBL	DOUBLE	FDN	FOUNDATION	HID	HIGH INTENSITY DISCHARGE	MAINT	MAINTENANCE	P/L	PROPERTY LINE	SIM	SIMILAR	V	VOLT
ARCH	ARCHITECTURAL	DEMO	DEMOLISH, DEMOLITION	FE	FIRE EXTINGUISHER	HM	HOLLOW METAL	MATL	MATERIAL	PL	PLATE	SOG	SLAB ON GRADE	VAR	VARIES, VARIABLE
AVG	AVERAGE	DF	DRINKING FOUNTAIN	FEC	FIRE EXTINGUISHER CABINET	HORIZ	HORIZONTAL	MAX	MAXIMUM	PLAM	PLASTIC LAMINATE	SPECS	SPECIFICATIONS	VCT	VINYL COMPOSITION TILE
		DIA	DIAMETER	FIXT	FIXTURE	HP	HORSEPOWER	MECH	MECHANICAL	PLBG	PLUMBING	SQ	SQUARE	VENT	VENTILATION
B/C	BACK OF CURB	DN	DOWN	F/L	FLOW LINE	HT	HEIGHT	MED	MEDIUM	PLYWD	PLYWOOD	SS	STAINLESS STEEL	VIF	VERIFY IN FIELD
BLDG	BUILDING	DS	DOWNSPOUT	FLR	FLOOR	HTR	HEATER	MFR	MANUFACTURER	PSF	POUNDS PER SQUARE FOOT	S/S	SERVICE SINK	VTR	VENT THROUGH ROOF
B.O.	BOTTOM OF	DTL, DE	T DETAIL	FLUOR	FLUORESCENT	HVAC	HEATING VENTILATING & A/C	MH	MANHOLE	PSI	POUNDS PER SQUARE INCH	STD	STANDARD		
BOT, BT	M BOTTOM	DWG	DRAWING	FOC	FACE OF CONCRETE	HW	HOT WATER	MIN	MINIMUM	PT	PAINT	STL	STEEL	W	WEST, WIDE
BRNZ	BRONZE			FOF	FACE OF FINISH	HWY	HIGHWAY	MLP	METAL LINER PANEL	PTD	PAPER TOWEL DISPENSER	STOR	STORAGE	W/	WITH
BTWN	BETWEEN	(E)	INDICATES EXISTING	FOM	FACE OF MASONRY			MP	METAL PANEL	PVC	POLYVINYL CHLORIDE	STRUCT	STRUCTURE(AL)	WC	WATER CLOSET
		EA	EACH	FOS	FACE OF STUD	IBC	INTERNATIONAL BUILDING	MSB	MOP SINK BASIN			SUSP	SUSPENDED	WD	WOOD
CA	COMRESSED AIR	E.B.	EXPANSION BOLT	FOW	FACE OF WALL		CODE	MTD	MOUNTED	QTY	QUANTITY			WH	WATER HEATER
CAB	CABINET	E.J.	EXPANSION JOINT	FPM	FEET PER MINUTE	ID	INSIDE DIAMETER	MTL	METAL			TA	TOILET ACCESSORY	WO	WHERE OCCURS
CAP	CAPACITY	EL	ELEVATION	FRP	FIBER REINFORCED PLASTIC	IECC	INTERNATIONAL ENERGY			R	RISER	TBD	TO BE DETERMINED	W/O	WITHOUT
CFM	CUBIC FEET PER MINUTE	ELEC	ELECTRIC(AL)	FT,'	FOOT, FEET		CONSERVATION CODE	NEC	NATIONAL ELECTRIC CODE	R/A	RETURN AIR	TD	TOILET PAPER DISPENSER	WP	WATERPROOF(ING)
CIP	CAST-IN-PLACE	ELEV	ELEVATION	FTG	FOOTING	IN, "	INCHES	NSF	NET SQUARE FEET	RB	RUBBER BASE	TEL	TELEPHONE	WR	WATER RESISTANT
C.T.	CONTROL JOINT,	ENCL	ENCLOSE(URE)	FPWH	FREEZEPROOF WALL	INCL	INCLUDE(D)(ING)	N	NORTH	RE:	REFERENCE	T&G	TONGUE AND GROOVE	WT	WEIGHT
	CONSTRUCTION JOINT	EQ	EQUAL		HYDRANT	INSUL	INSULATION	NIC	NOT IN CONTRACT	REBAR	REINFORCING BAR	THK	THICK		
C/L	CENTERLINE	EQUIP	EQUIPMENT			INT	INTERIOR	NO OR #	NUMBER	RECPT	RECEPTACLE	T.O.	TOP OF	X	TIMES OR BY
CLG	CEILING	ESEW	EMER. SHOWER & EYE WASH	GA	GAUGE	INV	INVERT	NOM	NOMINAL	REINF	REINFORCE(D)(ING)	T.O.C	TOP OF CONCRETE		
CLR	CLEAR(ANCE)	EUH	ELECTRIC UNIT HEATER	GAL	GALLON			NTS	NOT TO SCALE	REQ'D	REQUIRED	T.O.ST.	TOP OF STEEL		
СМИ	CONCRETE MASONRY UNIT	EWC	ELECTRICAL WATER COOLER	GALV	GALVANIZED	JAN	JANITOR			RH	RADIANT HEAT	T.O.S	TOP OF SLAB		

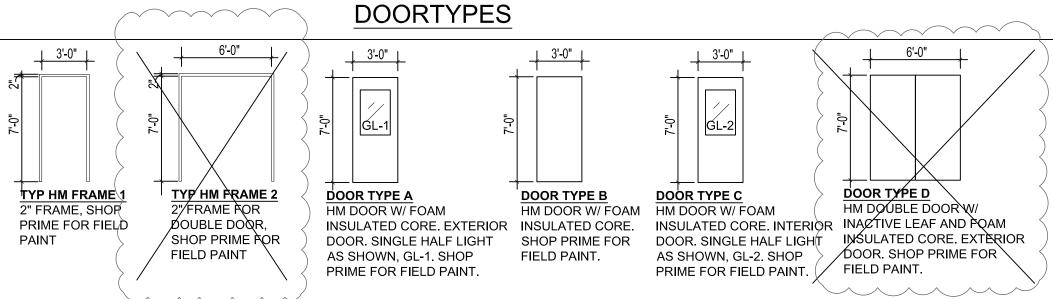

7-0-1	[GL-1]		[0-2]	10-12-1
P HM FRAME 1 FRAME, SHOP ME FOR FIELD NT TYP HM FRAME 2 2"FRAME FOR DOUBLE DOOR, SHOP PRIME FOR FIELD PAINT	DOOR TYPE A HM DOOR W/ FOAM INSULATED CORE. EXTERIOR DOOR. SINGLE HALF LIGHT AS SHOWN, GL-1. SHOP PRIME FOR FIELD PAINT.	DOOR TYPE B HM DOOR W/ FOAM INSULATED CORE. SHOP PRIME FOR FIELD PAINT.	DOOR TYPE C HM DOOR W/ FOAM INSULATED CORE. INTERIOR DOOR. SINGLE HALF LIGHT AS SHOWN, GL-2. SHOP PRIME FOR FIELD PAINT.	DOOR TYPE D HM DOUBLE DOOR W/ INACTIVE LEAF AND FOAM INSULATED CORE. EXTERIOR DOOR. SHOP PRIME FOR FIELD PAINT.

	DOOR SCHEDULE												
NO.	NO. DESCRIPTION TYPE FINISH WIDTH HT THK HOWE FRAME FINISH REMARKS												
1	EXT. DOOR- ADMIN.	Α	PT-2	3'-0"	7'-0"	1-3/4"	1	1	PT-2	KEYPAD LOCK AS SPECIFIED			
2	VESTIBULE DOOR	С	PT-2	3'-0"	7'-0"	1-3/4"	2	1	PT - 2				
3	MECH ROOM DOOR	В	PT-2	3'-0"	7'-0"	1-3/4"	3	1	PT - 2				
4	RESTROOM DOOR	В	PT-2	3'-0"	7'-0"	1-3/4"	4	1	PT-2				
5	RESTROOM DOOR	В	PT-2	3'-0"	7'-0"	1-3/4"	5	1	PT - 2				
6	CLASSROOM DOOR	C	PT-2	3'-0"	7'-0"	1-3/4"	6	1	PT-2				
7	EXT. DOOR - CLASSROOM	Α	PT-2	3'-0"	7'-0"	1-3/4"	7	1	PT-2	KEYPAD LOCK AS SPECIFIED			
			$\overline{}$										

6402 TROY CIRCLE, SUITE 100

(303) 936-1633

(303) 934-3200

CENTENNIAL, CO 80111

SUITE 200

PH:

FX:

LAKEWOOD, CO 80226

303-205-7860

303-425-0094

ROOM FINISH SCHEDULE												
RM.	DESC.	BASE		WA	LLS		CEILINGS		- REMARKS			
RIVI. DESC.	DLOO.	FLR.	DAGE	N	Е	S	W	MAT'L	HT.	TEMARKO		
101	VESTIBULE	LVT-1	RB-1	PT-1	PT-1	PT-1	PT-1	ACT-1	9'-4"	NONE		
102	MECH ROOM	LVT-1	RB-1	PT-1	PT-1	PT-1	PT-1	PT-1	9'-4"	FRP AROUND SINK, RE: FINISH SCHEDULE		
103	BREAK/ADMIN AREA	LVT-1	RB-1	PT-1	PT-1	PT-3	PT-1	ACT-1	9'-4"	NONE		
104	RESTROOM	LVT-1	CT-1	PT-1/	PT-1/	PT-1/	PT-1/	PT-1	8'-0"	ALL WALLS TO RECEIVE 4'-0" TILE WAINSCOT,		
				CT-1,2	CT-1,2	CT-1,2	CT-1,2			RE: ELEV FOR PATTERN.		
105	RESTROOM	LVT-1	CT-1	PT-1/	PT-1/	PT-1/	PT-1/	PT-1	8'-0"	ALL WALLS TO RECEIVE 4'-0" TILE WAINSCOT,		
				CT-1,2	CT-1,2	CT-1,2	CT-1,2			RE: ELEV FOR PATTERN.		
106	CLASSROOM	LVT-1	RB-1	PT-1	PT-3	PT-1	PT-1	ACT-1	9'-4"	NONE		

SCHEDULE OF COLORS AND FINISHES

COLORS ARE FOR REFERENCE, RE: SPECIFICATION SECTIONS INDICATED FOR OTHER APPROVED MANUFACTURE

100	ARCHITECTURAL WOODWORK
4M-1	WILSONART4943-38 CLASSIC LINE
	WILCOMART AGEG GO RECONTE LEC

PLAM-2 WILSONART 4656-60 BRONZE LEGACY

FIBER REINFORCED PLASTIC (FRP)
.090" FRP PANEL AT SERVICE SINK, WHITE

EXTERIOR METAL PANEL, R-PROFILE, COLOR AS SELECTED BY ARCHITECT FROM MFR STANDARD COLOR RANGE TO MATCH EXISTING PANELS

3/4" CLEAR INSULATED TEMPERED GLASS

1/4" CLEAR TEMPERED GLASS *ALL METAL PANEL TRIM & ACCESSORIES TO MATCH ADJACENT PANEL

OR AS SELECTED BY ARCHITECT * ALL FIRE RATED SURFACES TO MEET CLASS C RATING, MINIMUM, PER IBC 2015 TABLE 803.9.

CERAMIC TILE
DALTILE MATTE, K775 BISCUIT DALTILE MATTE, 0766 ELEMENTAL TAN GROUT: MAPEI 14 BISCUIT

ACOUSTIC CEILING TILE
ARMSTRONG, CORTEGA 24X48 LAY-IN

RESILIENT FLOOR AND BASE ROPPE PINNACLE 140 FAWN LVT-1 KARNDEAN KP91, VICTORIAN OAK


WALLS / CEILING, SHERWIN WILLIAMS SW7002 DOWNY WHITE DOORS AND FRAMES, SHERWIN WILLIAMS SW7032 WARM STONE ACCENT WALL IN CLASSROOM AND BREAK AREA,

SHERWIN WILLIAMS SW6887 NAVEL

DEPARTMENT OF TRANSPORTATION PROJECT # 21914

SAP BUILDING NO # 1000/2/47


	<u>DATE</u>	<u>No.</u>	DESCRIPTION
	3/24/2017	1	65% CONSTRUCTION DOCUMENTS
	4/12/2017	2	85% CONSTRUCTION DOCUMENTS
	5/12/2017	3	99% CODE REVIEW
	6/14/2017	4	100% BID SET
(7/17/2017	5	ADDENDUM #2 REVISED DRAWINGS
/			

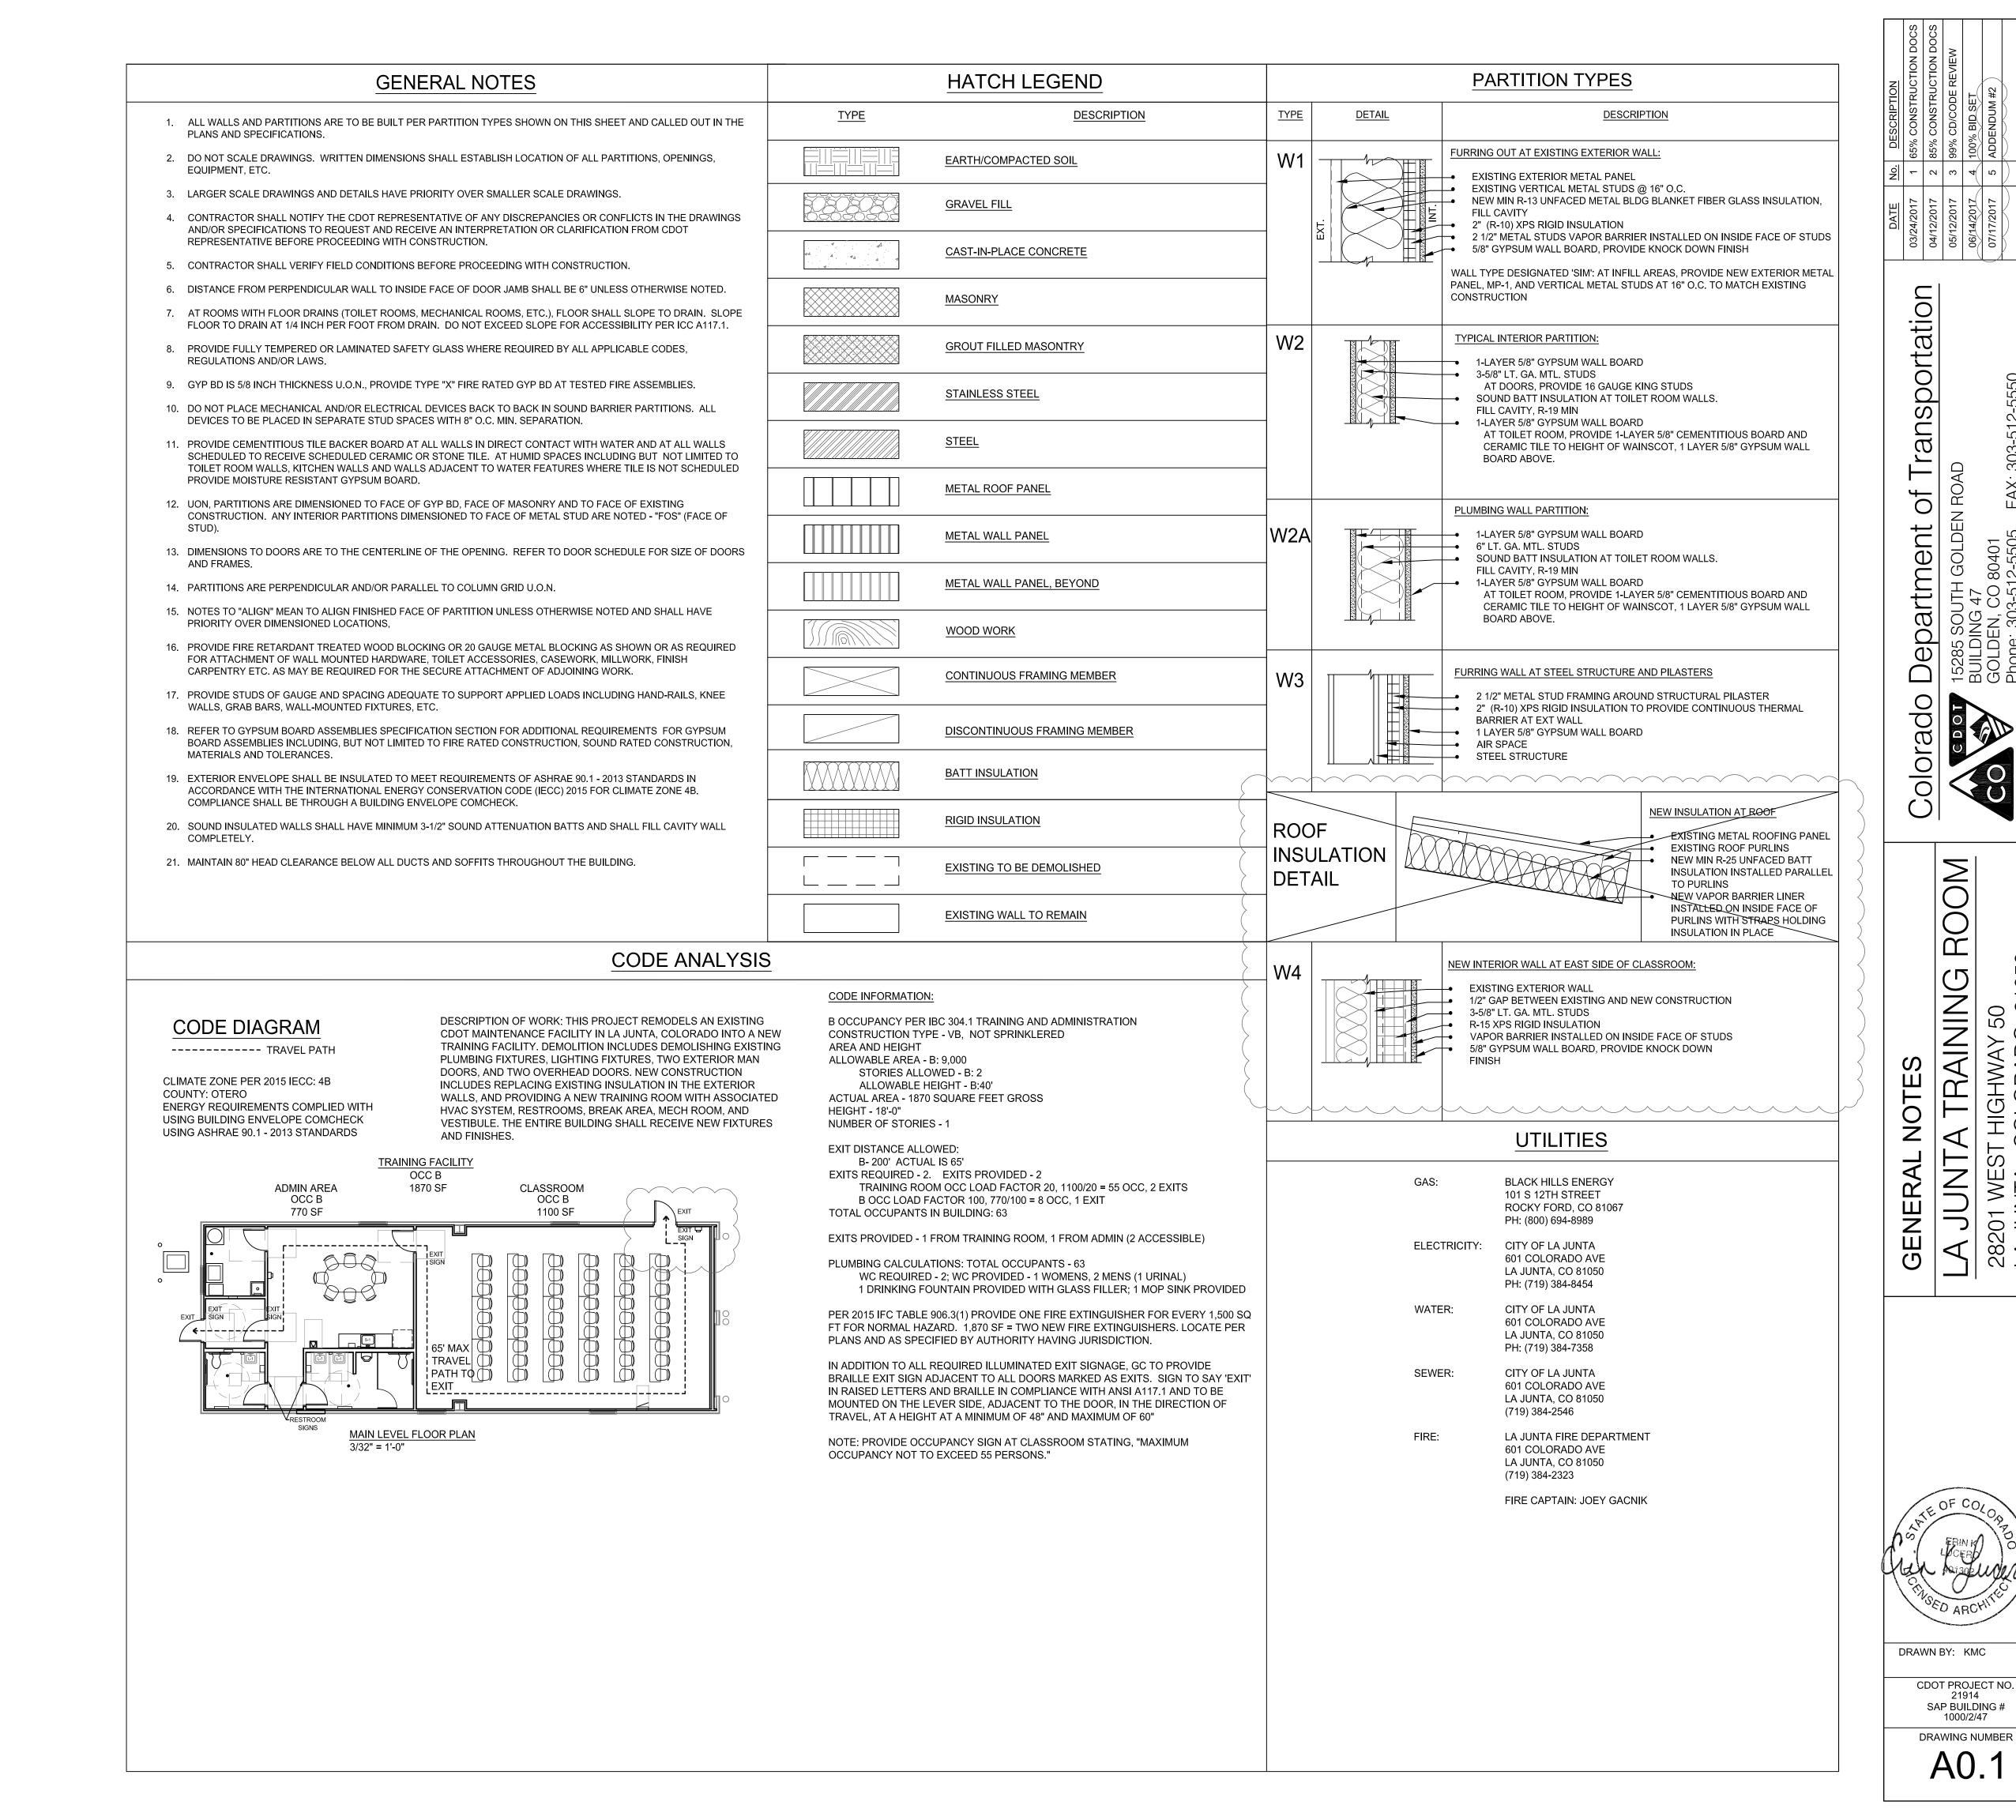

ST HIGHWAY 50 , COLORADO 81050


LA JUN 28201 WES LA JUNTA,

DEMOLITION REFLECTED CEILING PLAN 1/4" = 1'-0"

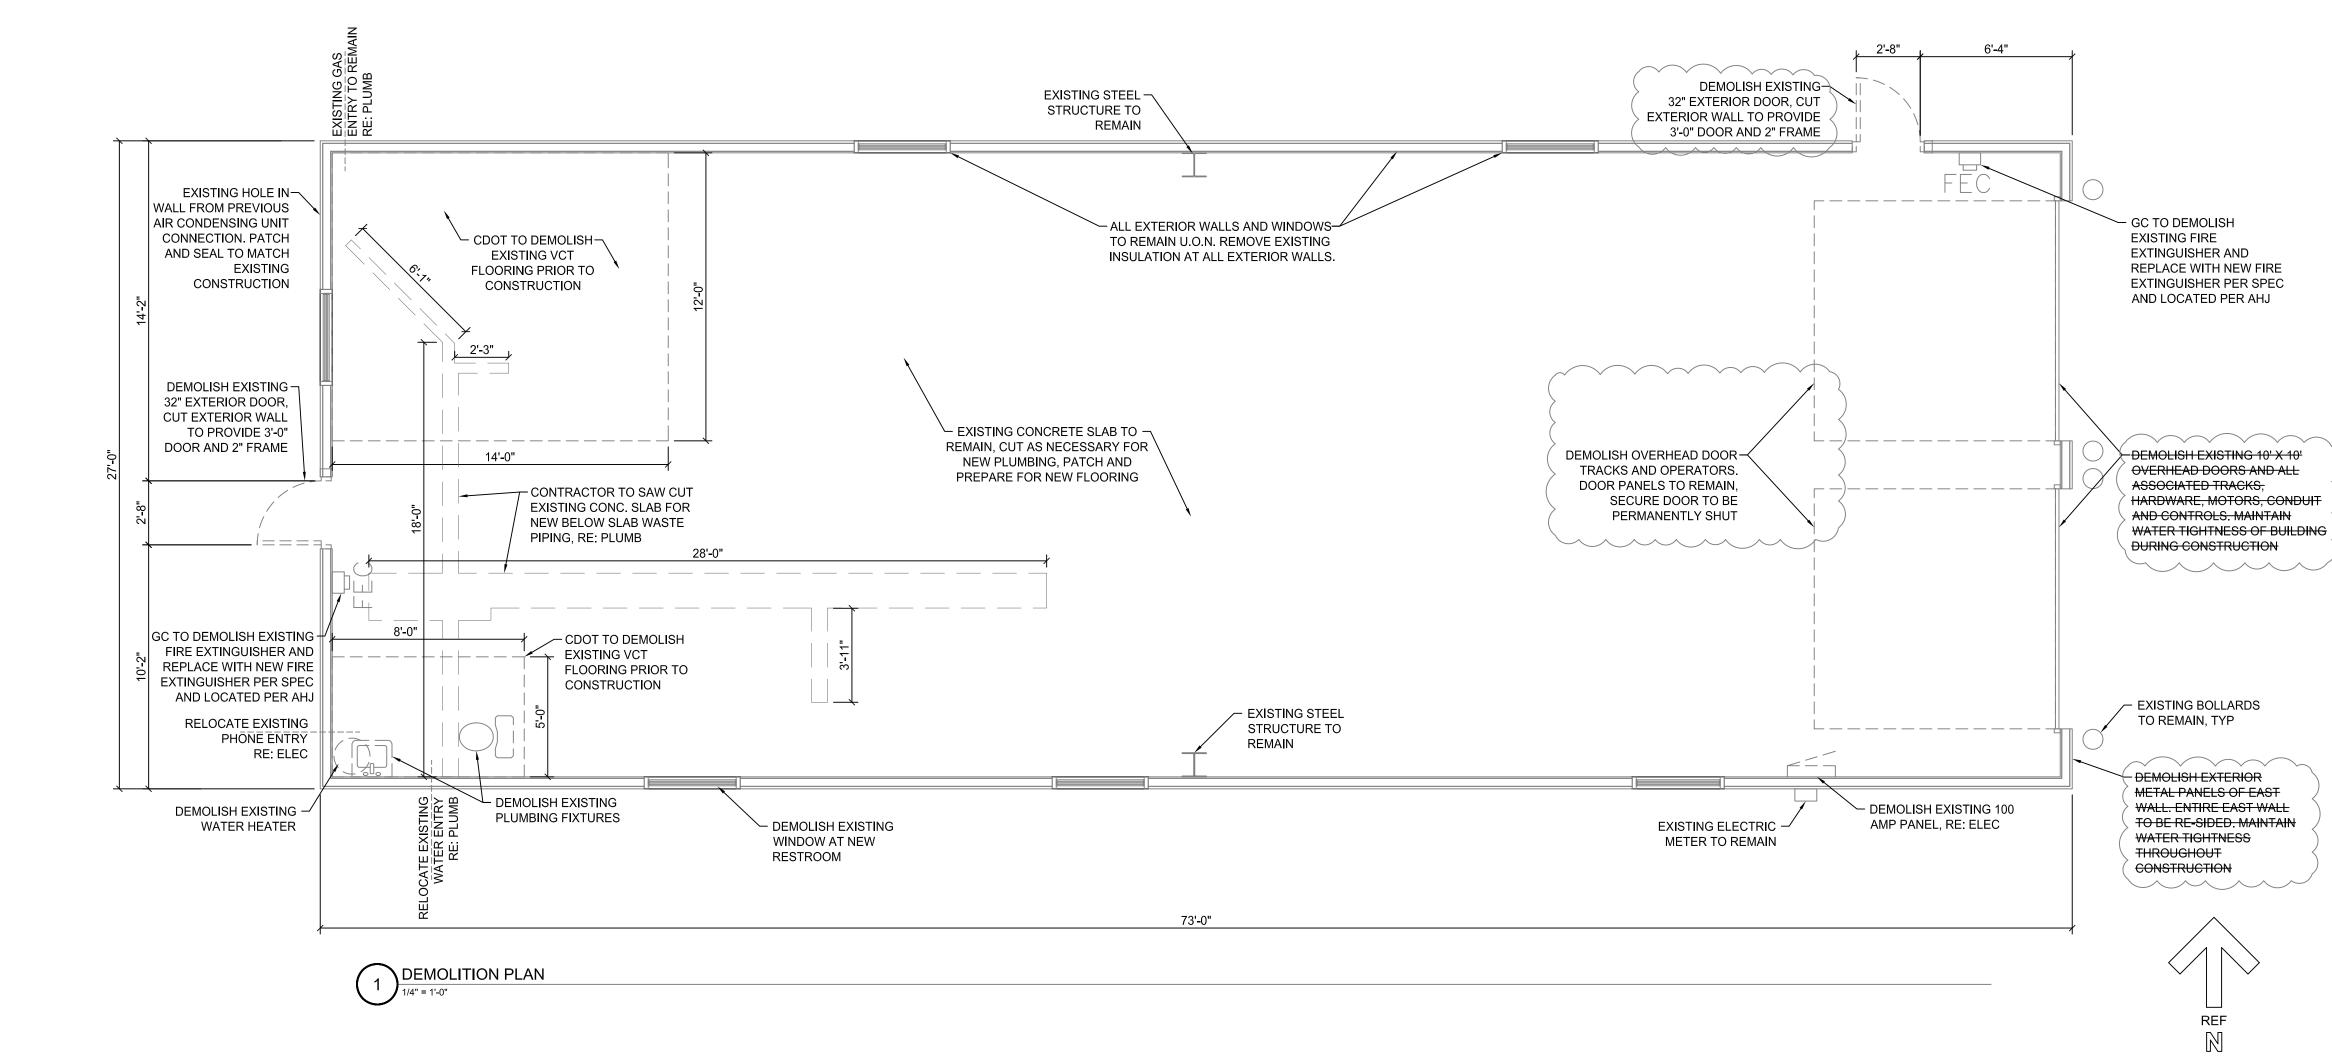

DEMOLITION PLAN NOTES

- 1. DEMOLISH AND REMOVE ALL ASSEMBLIES, MATERIALS AND DEBRIS AS INDICATED WITH A DASHED
- 2. ALL EXISTING EQUIPMENT, MATERIALS AND FIXTURES NOT SCHEDULED FOR RE-USE SHALL BE DISPOSED OF PROPERLY AND RECYCLED IF POSSIBLE. COORDINATE WITH THE OWNER'S REPRESENTATIVE AND COMPLY WITH ALL REGULATIONS AND/OR REQUIREMENTS PERTAINING TO THE REMOVAL, SALVAGE, AND STORAGE OF MATERIALS TO BE DEMOLISHED AS SCHEDULED.
- 3. EXISTING ELECTRICAL WIRING NOT SCHEDULED FOR RE-USE SHALL BE REMOVED ENTIRELY, INCLUDING HANGARS, SUPPORTS, TERMINALS, CONDUIT AND JUNCTIONS FROM THE SOURCE TO THE POINT OF TERMINATION. MAINTAIN CIRCUIT AND/OR TRANSMISSION CONTINUITY TO REMAINING DEVICES WHERE NECESSARY.
- 4. ALL PIPES AND CONDUIT SCHEDULED FOR DEMOLITION SHALL BE REMOVED IN THEIR ENTIRETY. WHEN NOT IN USE AND/OR SCHEDULED FOR RELOCATION COORDINATE ACCORDINGLY.
- 5. WHERE EXISTING PLUMBING FIXTURES ARE SCHEDULED TO BE REMOVED, REMOVE COMPLETE WITH ALL ACCESSORIES AND TRIM. REPAIR PIPING AS REQUIRED FOR NEW FIXTURES.
- 6. WHERE EXISTING FLOORING IS INDICATED TO BE REMOVED, REMOVE FLOORING, ADHESIVE AND MASTIC TO CONCRETE SUBSTRATE BELOW. IF CONCRETE OR SUBSTRATE COMES UP WITH THE FLOORING, PROVIDE LEVELING AND/OR PATCHING FOR SMOOTH SURFACE.

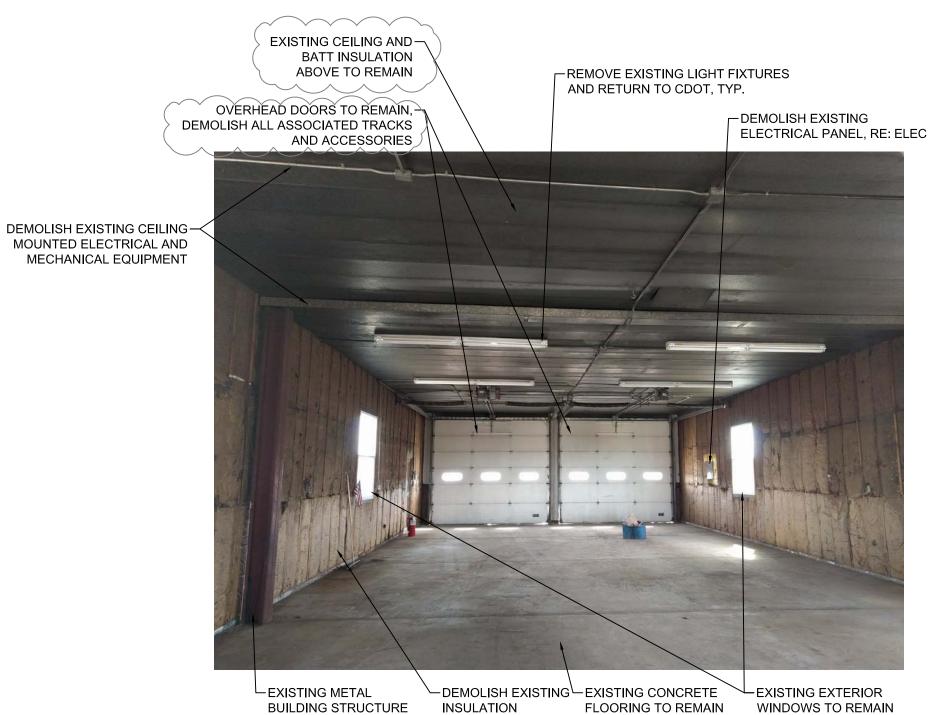

TO REMAIN

BATT INSULATION ABOVE TO REMAIN DEMOLISH EXISTING EXTERIOR -WINDOW AND PATCH TO MATCH

EXISTING CONSTRUCTION

EXISTING CEILING AND

- REMOVE EXISTING LIGHT FIXTURES AND RETURN TO CDOT, TYP. DEMOLISH EXISTING -EXTERIOR DOOR, CUT **EXTERIOR WALL TO** PROVIDE NEW 3' X 7'

PATCH EXISTING HOLES IN WALLS AND CEILING TO MATCH EXISTING CONSTRUCTION



EXISTING FURNITURE TO BE REMOVED BY CDOT LEXISTING CONCRETE SLAB TO REMAIN

EXISTING VCT FLOORING TO BE REMOVED BY CDOT

EXISTING EXTERIOR → WINDOW TO REMAIN DEMOLISH EXISTING-INSULATION

ST HIGHWAY 50 , COLORADO 81050

ANS


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DEMOLITION

DRAWN BY: KMC

CDOT PROJECT NO. SAP BUILDING # 1000/2/47

DRAWING NUMBER

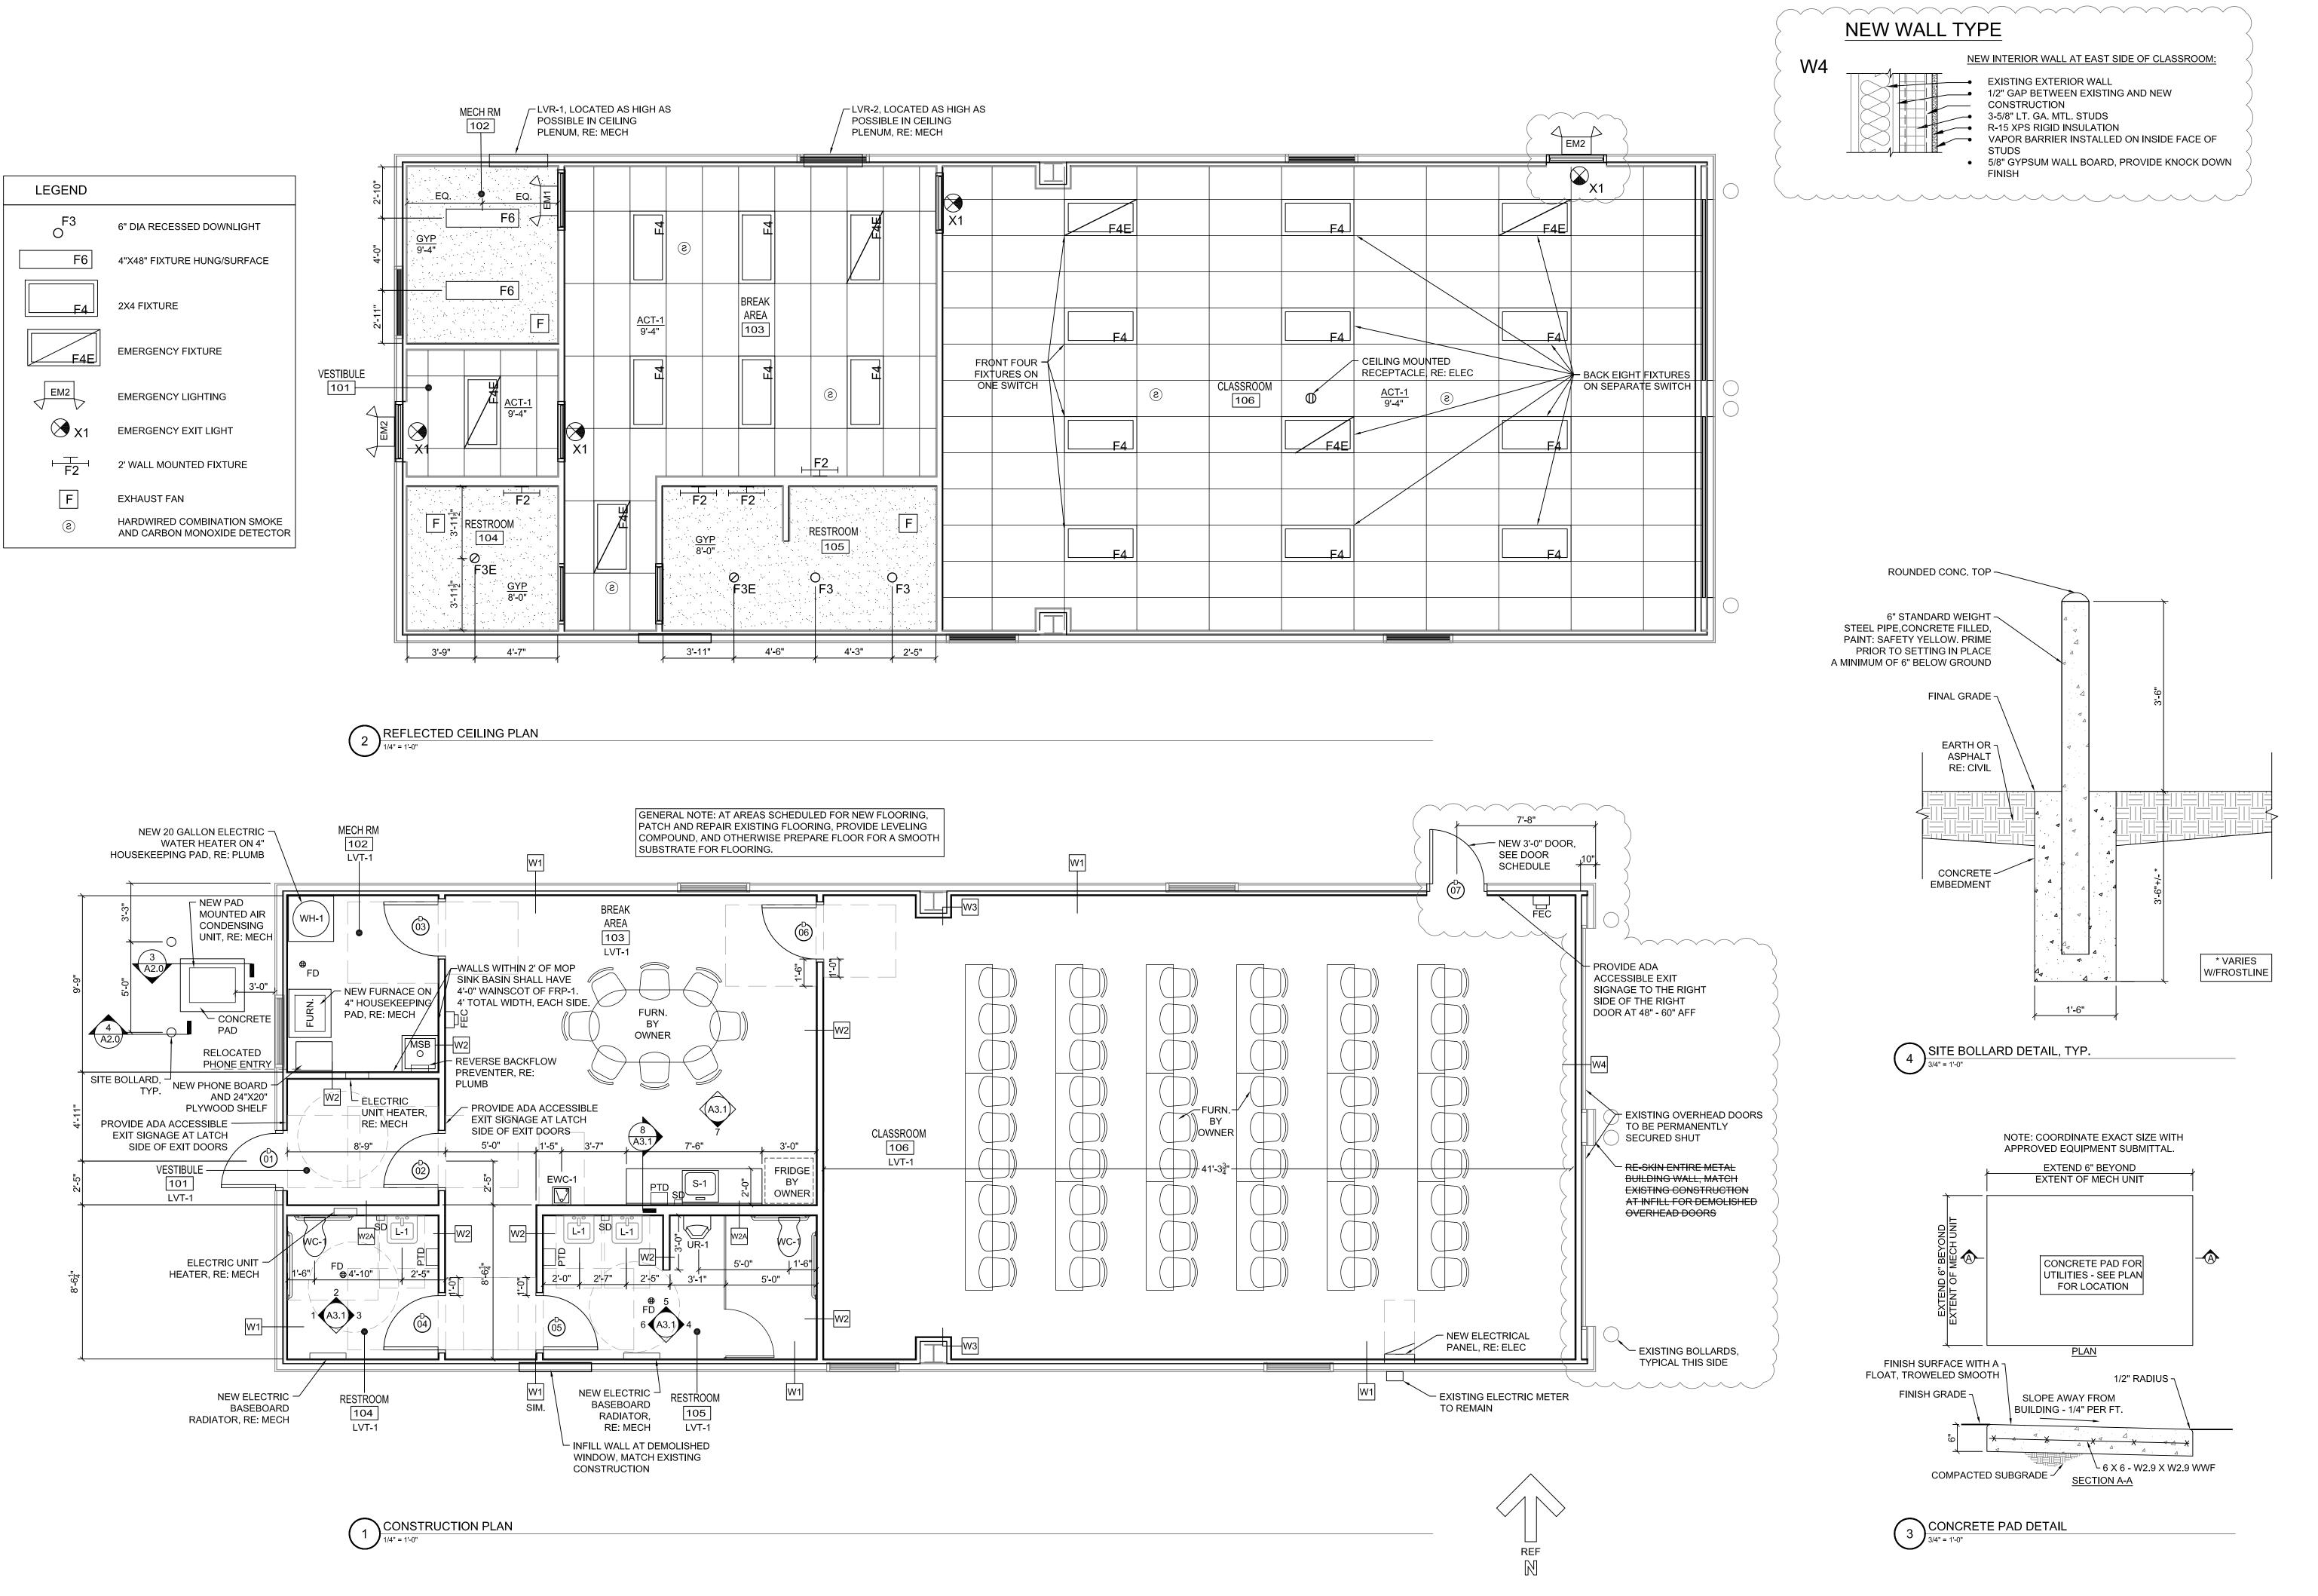


28201 WEST HIGHWAY 50 LA JUNTA, COLORADO 81050 **CONSTRUCTION PLANS**

DRAWN BY: KMC

CDOT PROJECT NO. SAP BUILDING # 1000/2/47

DRAWING NUMBER A2.0

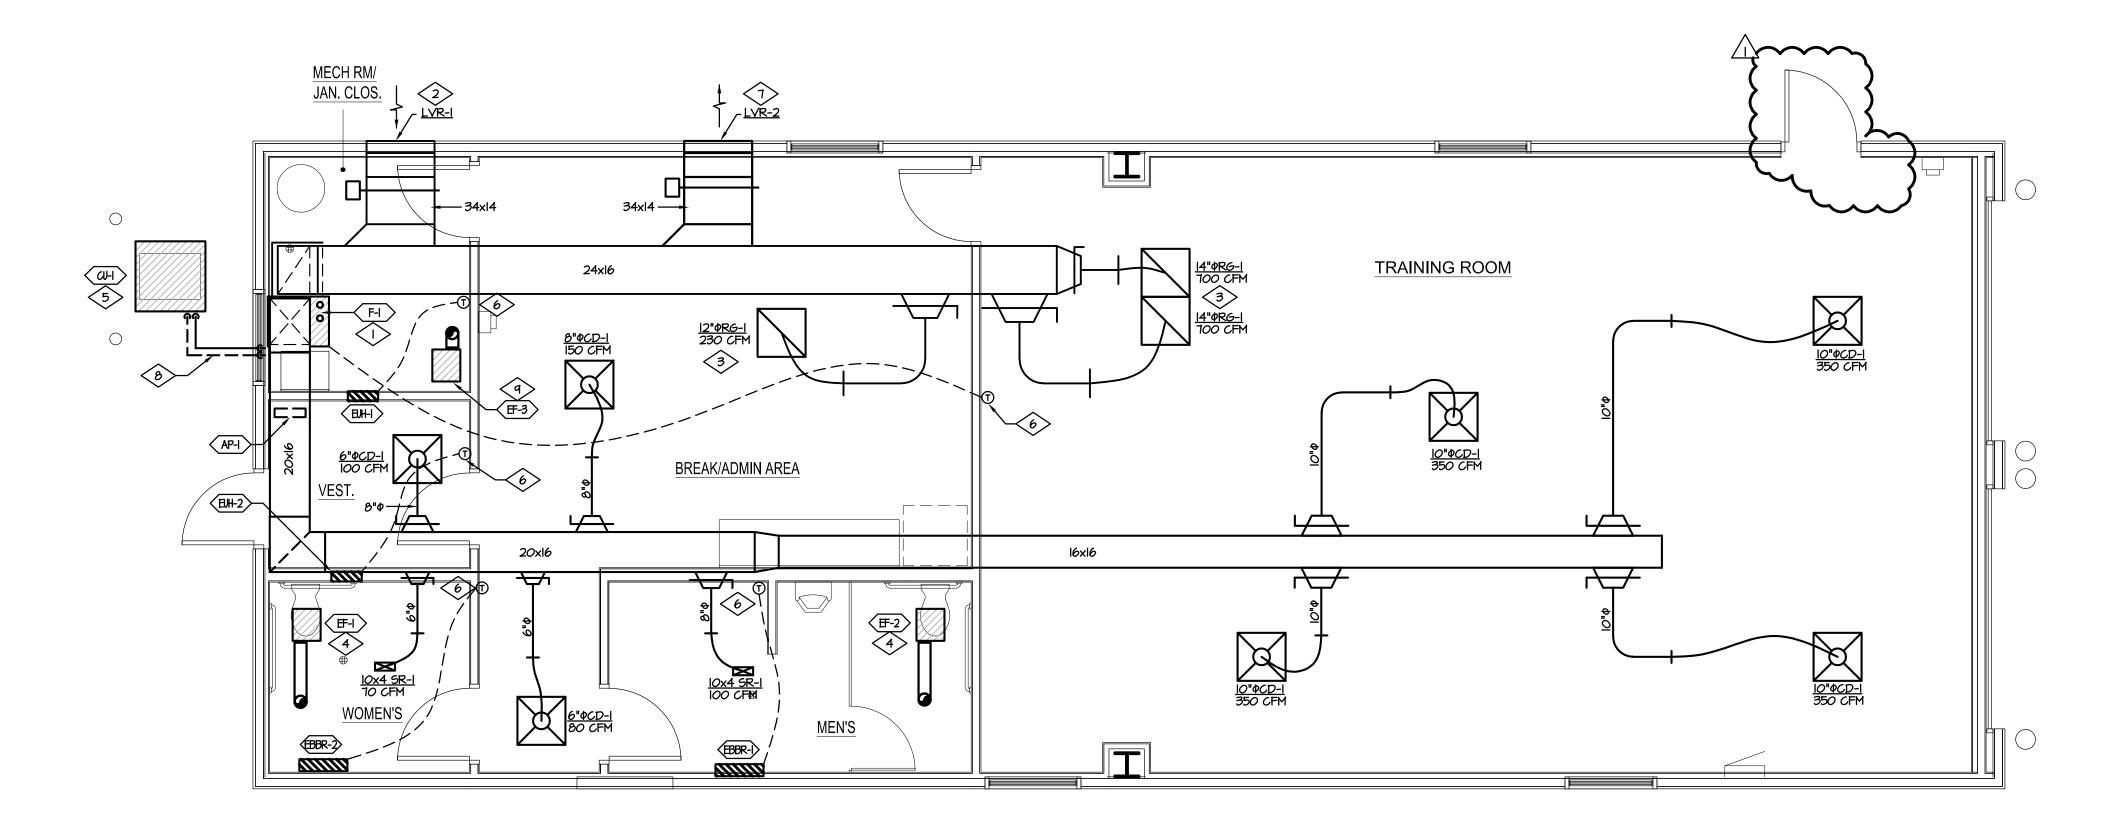




GENERAL NOTES

- I. REFERENCE DIAGRAMS FOR INSTALLATION OF HVAC EQUIPMENT AND DEVICES.
- PLANS ARE DIAGRAMMATIC. FIELD COORDINATE LOCATION OF NEW DUCTWORK, EQUIPMENT, ETC WITH STRUCTURE, LIGHTS, AND PLUMBING.
- 3. ALL DUCT DIMENSIONS SHOWN ARE SHEET METAL DIMENSIONS.
- 4. NOT ALL DUCT TRANSITIONS AND OFFSETS ARE SHOWN. CONTRACTOR SHALL PROVIDE THE NECESSARY FITTING REQUIRED AND INSTALL ACCORDINGLY.
- 5. COORDINATE THERMOSTAT LOCATIONS WITH FURNITURE LAYOUT, INSTALL ACCORDINGLY. VERIFY FURNITURE LAYOUT WITH ARCHITECTURAL DRAWINGS.
- 6. CONTRACTOR SHALL PROVIDE NECESSARY CODE COMPLYING CLEARANCES FOR ALL EQUIPMENT INSTALLED.
- 7. THERMOSTATS SHALL BE INSTALLED ON INTERIOR WALLS OR COLUMNS WHERE POSSIBLE. FOR THERMOSTATS INSTALLED ON EXTERIOR WALLS, PROVIDE INSULATED AND VENTILATED MOUNTING BOX BEHIND THERMOSTAT, SEE DIAGRAM.
- ALL DUCTWORK LOCATED IN ATTIC SPACES SHALL BE INSULATED WITH A MINIMUM R-I2 DUCT LINER OR WRAP.

○ DRAWING NOTES

- MOUNT FURNACE ON 4" CONCRETE HOUSEKEEPING PAD. ROUTE 3" COMBUSTION AIR AND 3" FLUE OUT THROUGH ROOF. PROVIDE MANUFACTURER APPROVED CONCENTRIC VENT TERMINATION.
- OUTSIDE AIR LOUVER LVR-I SHALL BE INSTALLED AS HIGH AS POSSIBLE IN CEILING PLENUM, SEE ARCHITECTURAL PLANS FOR ELEVATION. PROVIDE FULL SIZE PLENUM AND ROUTE 34x14 OUTSIDE AIR DUCT INTO MECHANICAL ROOM TO RETURN DUCTWORK.

 MOTORIZED DAMPER TO BE CONTROLLED BY ECONOMIZER CONTROLLER. REFER TO FURNACE SCHEDULE FOR OPERATION AND BALANCING.
- 3. PROVIDE LAY-IN RETURN GRILL IN CEILING AND TRANSITION TO RETURN DUCTWORK.
- 4. CEILING MOUNTED EXHAUST FAN. ROUTE 6" EXHAUST DUCT AS HIGH AS POSSIBLE. PROVIDE HOODED ROOF CAP AND BIRDSCREEN AT PENETRATION. INTERLOCK FAN WITH OCCUPANCY SENSOR, REFER TO ELECTRICAL PLANS FOR MORE
- INSTALL <u>CU-I</u> ON 6" CONCRETE PAD. PROVIDE MANUFACTURER RECOMMENDED CLEARANCE ON ALL SIDES. ROUTE REFRIGERANT PIPING LINE SET TO <u>F-I</u>. COORDINATE FINAL PROPERTIES FINAL PROPERTIES OF THE POINTS INTO DUE TO THE PROPERTIES OF THE PROPERTIES OF THE PROPERTY POINTS
- 6. MOUNT THERMOSTAT 48" AFF. TO COMPLY WITH ADA REQUIREMENTS. COORDINATE EXACT LOCATION WITH ALL OTHER TRADES.
- 7. RELIEF LOUVER LVR-2 TO BE INSTALLED AS HIGH AS POSSIBLE IN CEILING PLENUM. SEE ARCHITECTURAL PLANS FOR ELEVATION. ROUTE 30x14 DUCTWORK TO RETURN AIR DUCTWORK AS INDICATED. MOTORIZED DAMPER TO BE CONTROLLED BY ECONOMIZER CONTROLLER. REFER TO FURNACE SCHEDULE FOR OPERATION AND BALANCING.
- 8. EXTERIOR REFRIGERANT PIPE SHALL BE INSULATED WITH ALUMINUM UV PROTECTION
- CEILING MOUNTED EXHAUST FAN. ROUTE 6"\$ EXHAUST DUCT AS HIGH AS POSSIBLE. PROVIDE HOODED ROOF CAP AND BIRDSCREEN AT PENETRATION. INTERLOCK FAN WITH TIME CLOCK.

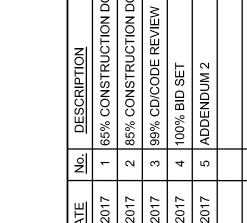

ansportation

A JUNTA TRAINING F 28201 WEST HIGHWAY 50 LA JUNTA, COLORADO 81020 **TRAINING**

MECHANICAL PLAN



DRAWN BY: KMC


CDOT PROJECT NO. 21914 SAP BUILDING # 1000/2/47

> DRAWING NUMBER M 3.0



info@mep-eng.com www.mep-eng.com



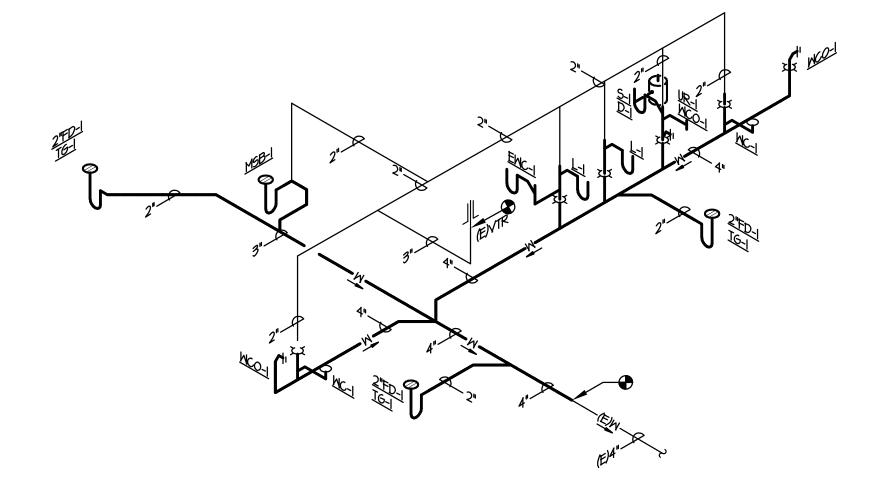

WASTE AND VENT ISOMETRIC
P3.0 SCALE: N.T.S.



GENERAL NOTES

ALL NEW BELOW GRADE WASTE PIPING WILL REQUIRE MODIFICATION OF EXISTING SLAB ON GRADE. REPAIR AFFECTED SLAB TO MATCH EXISTING.

○ DRAWING NOTES

- ROUTE 3" VENT PIPING TO EXISTING ROOF PENETRATION, MODIFY EXISTING VENT PENETRATION AS REQUIRED.
- CONTRACTOR SHALL FIELD VERIFY INVERT ELEVATION AND DIRECTION OF FLOW FOR THE EXISTING SANITARY SYSTEM PRIOR TO START OR CONSTRUCTION.

LA JUNTA TRAINING R(28201 WEST HIGHWAY 50 LA JUNTA, COLORADO 81020


PLUMBING PLAN



DRAWN BY:

CDOT PROJECT NO. 21914 SAP BUILDING # 1000/2/47

DRAWING NUMBER P3.0

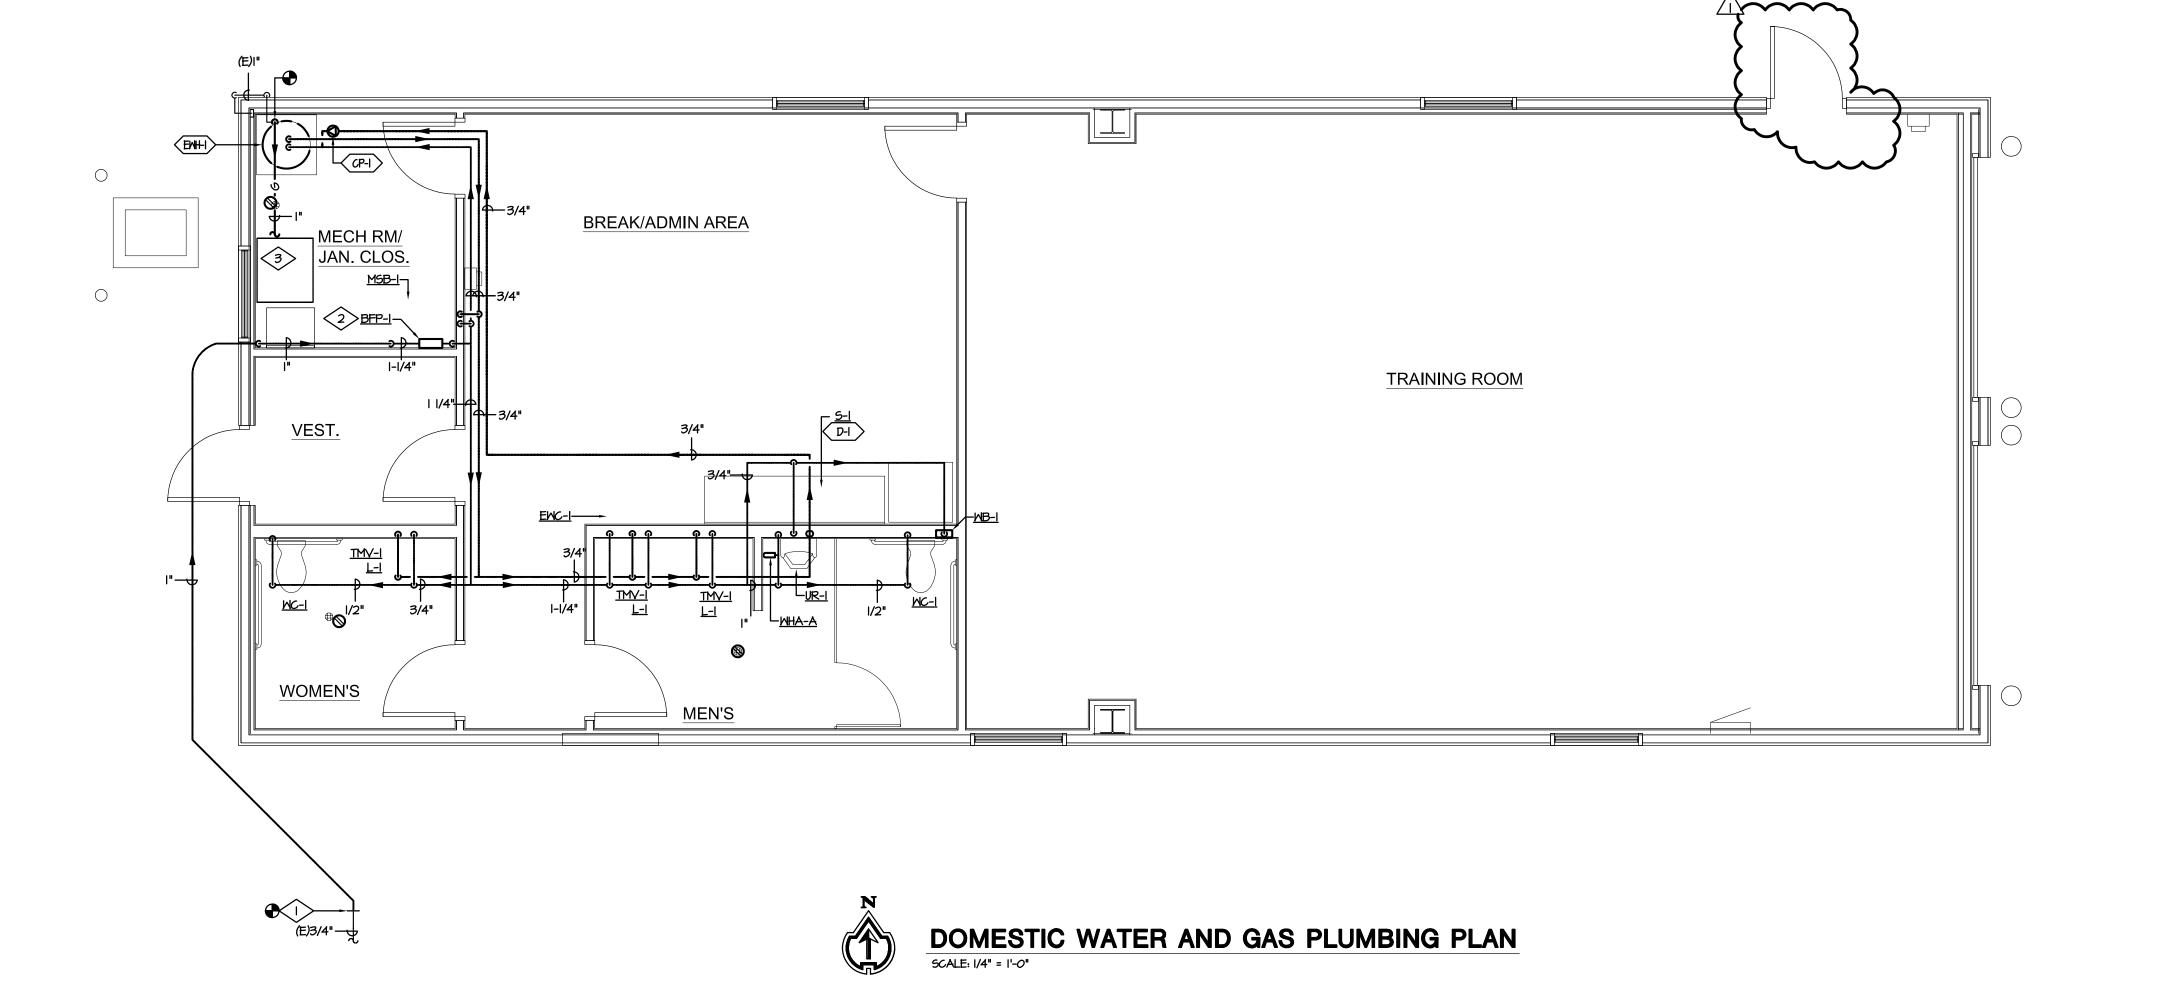

○ DRAWING NOTES

- CONTRACTOR TO FIELD VERIFY LOCATION OF WATER SERVICE PIPE AND PIPE MATERIAL. CONNECT AND MATCH NEW I" DOMESTIC WATER PIPING TO EXISTING 3/4" PIPE. ROUTE PIPING AS SHOW WITH NO JOINTS BELOW GRADE.
- 2. MOUNT BFP-I ABOVE MSB-I. PIPE DISCHARGE FROM <u>BFP-I</u> TO <u>MSB-I</u> WITH AIR GAP. SEE DIAGRAM ON P I.I.
- I" GAS TO GAS FIRED FURNACE. REFER TO MECHANICAL PLANS. CONNECT TO APPLIANCE PER DIAGRAMS.

TION DOCS EVIEW	
DESCRIPTION 65% CONSTRUCTION DOCS 85% CONSTRUCTION DOCS 99% CD/CODE REVIEW 100% BID SET ADDENDUM 2	
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DATE 03/17/2017 04/12/2017 05/12/2017 06/14/2017	


LA JUNTA TRAINING RO 28201 WEST HIGHWAY 50 LA JUNTA, COLORADO 81020 **PLUMBING PLAN**



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CDOT PROJECT NO. 21914 SAP BUILDING # 1000/2/47

DRAWING NUMBER P3.1



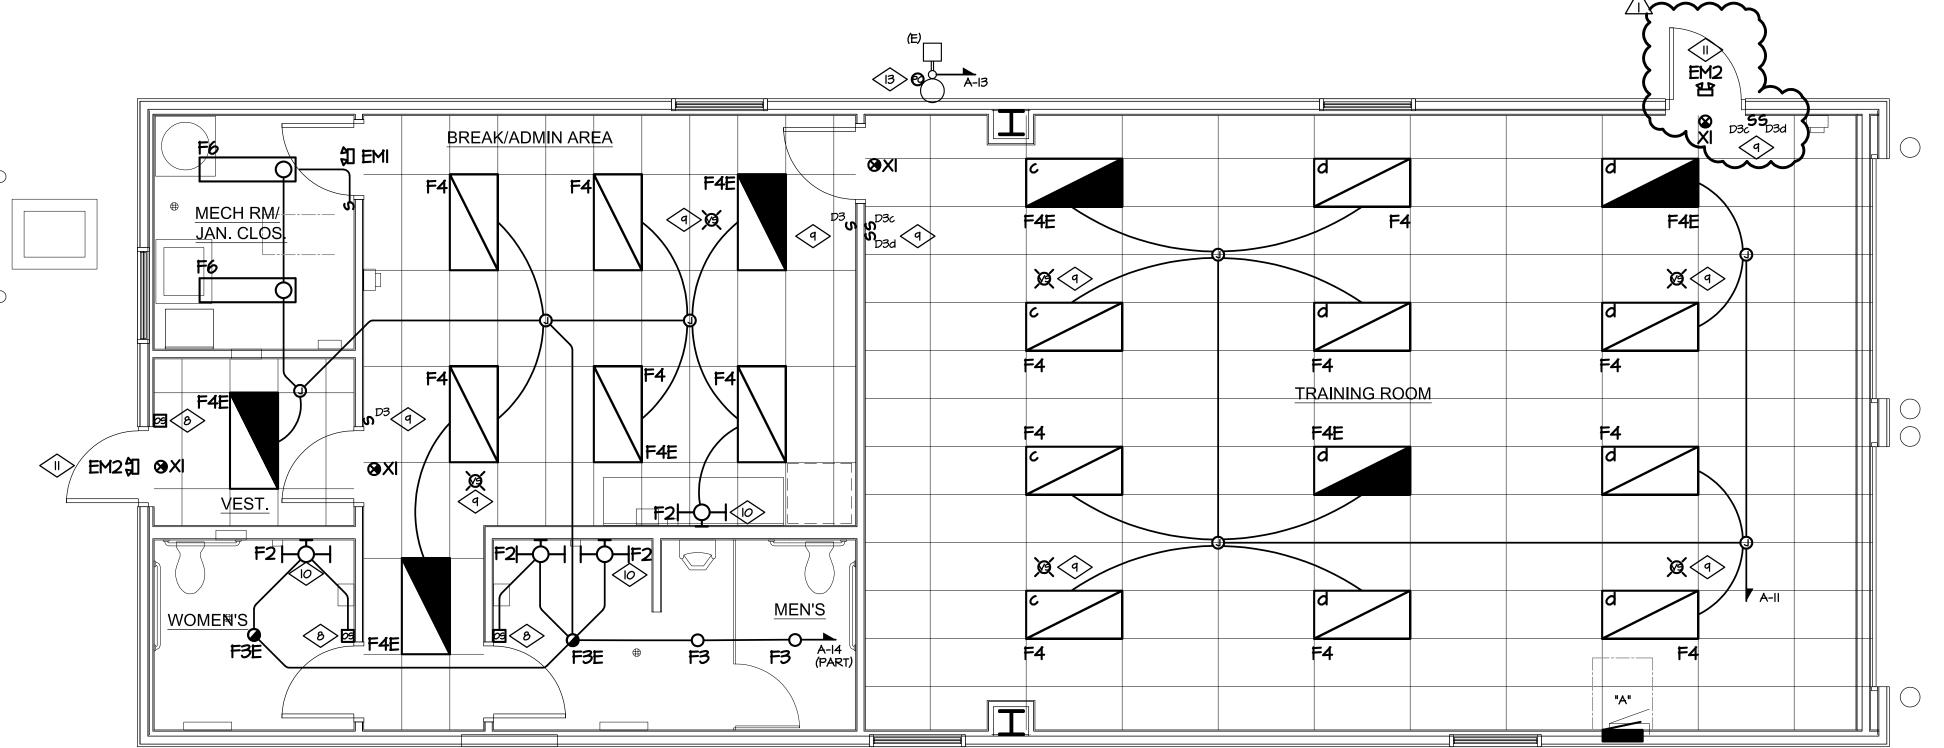

GENERAL NOTES

- I. ALL EM/EXIT SIGN LIGHT FIXTURES AND BATTERY PACKS TO BE CONNECTED TO NEAREST UNSWITCHED LEG OF LOCAL LIGHTING CIRCUIT.
- 2. ALL ELECTRICAL WORK SHALL COMPLY WITH 2014 NEC REQUIREMENTS.

○ DRAWING NOTES POWER PLAN

- COORDINATE EXACT PANEL LOCATION WITH OWNER PRIOR TO INSTALLATION.
- 2. CONNECT EXHAUST FAN TO OCCUPANCY SENSOR / SWITCH CONTROLLED LIGHTING CIRCUIT SERVING THIS ROOM.
- 3. CONTRACTOR TO PROVIDE REMOTE GFCI RESET BUTTON.
- 4. PROVIDE 48" X 48" X 3/4" TELEPHONE BOARD WITH (2) NEMA 5-20R, 20A, DEDICATED RECEPTACLES MOUNTED AT +60" AFF. PROVIDE (1) #6 CU AWG GND IN 1-1/2" CONDUIT TO NEAREST COLD WATER PIPE OR BUILDINGS STEEL FOR EQUIPMENT GROUND. SEE SPECIFICATION SECTION 16121 FOR ADDITIONAL REQUIREMENTS.
- 5. PROVIDE (2) 4" CONDUIT FOR TELEPHONE AND DATA. INSTALL 3 EACH I-I/4" CONDUIT INTERDUCTS IN ONE OF THE 4" CONDUITS. COORDINATE EXACT ROUTING WITH ARCHITECT AND CIVIL ENGINEER PRIOR TO INSTALLATION. PROVIDE A MINIMUM OF EIGHT (8) PAIRS OF TELEPHONE LINES REQUIRED TO SERVE THE BUILDING. SEE SPECIFICATION SECTION 16121 FOR ADDITIONAL REQUIREMENTS.
- 6. CONNECT 24V DAMPER MOTOR TO I20V CIRCUIT INDICATED.
- CEILING MOUNTED DUPLEX RECEPTACLE AND DATA PORT FOR CEILING MOUNTED PROJECTOR. COORDINATE EXACT LOCATION WITH OWNER PRIOR TO ROUGH-IN. COORDINATE EQUIPMENT REQUIREMENTS WITH OWNER/VENDOR PRIOR TO ROUGH-IN. PROJECTOR TO BE PROVIDED AND INSTALLED BY OWNER.
- 8. PROVIDE WALL MOUNTED PASSIVE DUAL TECHNOLOGY WALL SWITCH SENSOR. SENSOR SWITCH 'WSD PDT WH' OR EQUAL.
- 9. PROVIDE CEILING MOUNTED, PASSIVE DUAL TECHNOLOGY, LINE VOLTAGE VACANCY SENSOR, SENSOR SWITCH 'CMR IO' OR APPROVED EQUAL. PROVIDE SENSOR OVERRIDE
- IO. COORDINATE FIXTURE MOUNTING HEIGHT WITH COOT PRIOR TO ROUGH-IN AND INSTALLATION. REFER TO ARCHITECTURAL ELEVATIONS.
- II. BATTERY FOR EM2 FIXTURES TO BE INSTALLED/LOCATED WITHIN BUILDING INTERIOR. COORDINATE LOCATION OF BATTERY WITH OWNER PRIOR TO INSTALLATION.
- 12. HARD-WIRED CEILING MOUNTED COMBINATION SMOKE AND CARBON MONOXIDE DETECTOR WITH BATTERY BACK-UP. KIDDE 900-0114A OR EQUAL, TO CIRCUIT A-27. PROVIDE CEILING MOUNTED FIRE STROBE KIDDE SLITTI OR EQUAL. INTERLOCK FIRE STROBES TO SMOKE/CARBON MONOXIDE DETECTORS.
- 13. LOCATION OF PHOTOCELL TO CONTROL EXISTING EXTERIOR LIGHT FIXTURE.
- 14. PROVIDE CEILING MOUNTED FIRE STROBE KIDDE SLITTI OR EQUAL. INTERLOCK FIRE STROBES TO SMOKE/CARBON MONOXIDE DETECTORS.

S LA JUNTA TRAINING RO 28201 WEST HIGHWAY 50 LA JUNTA, COLORADO 81020 & LIGHTING PL **POWER**



DRAWN BY:KMC

CDOT PROJECT NO. 21914 SAP BUILDING # 1000/2/47

> DRAWING NUMBER E3.0



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